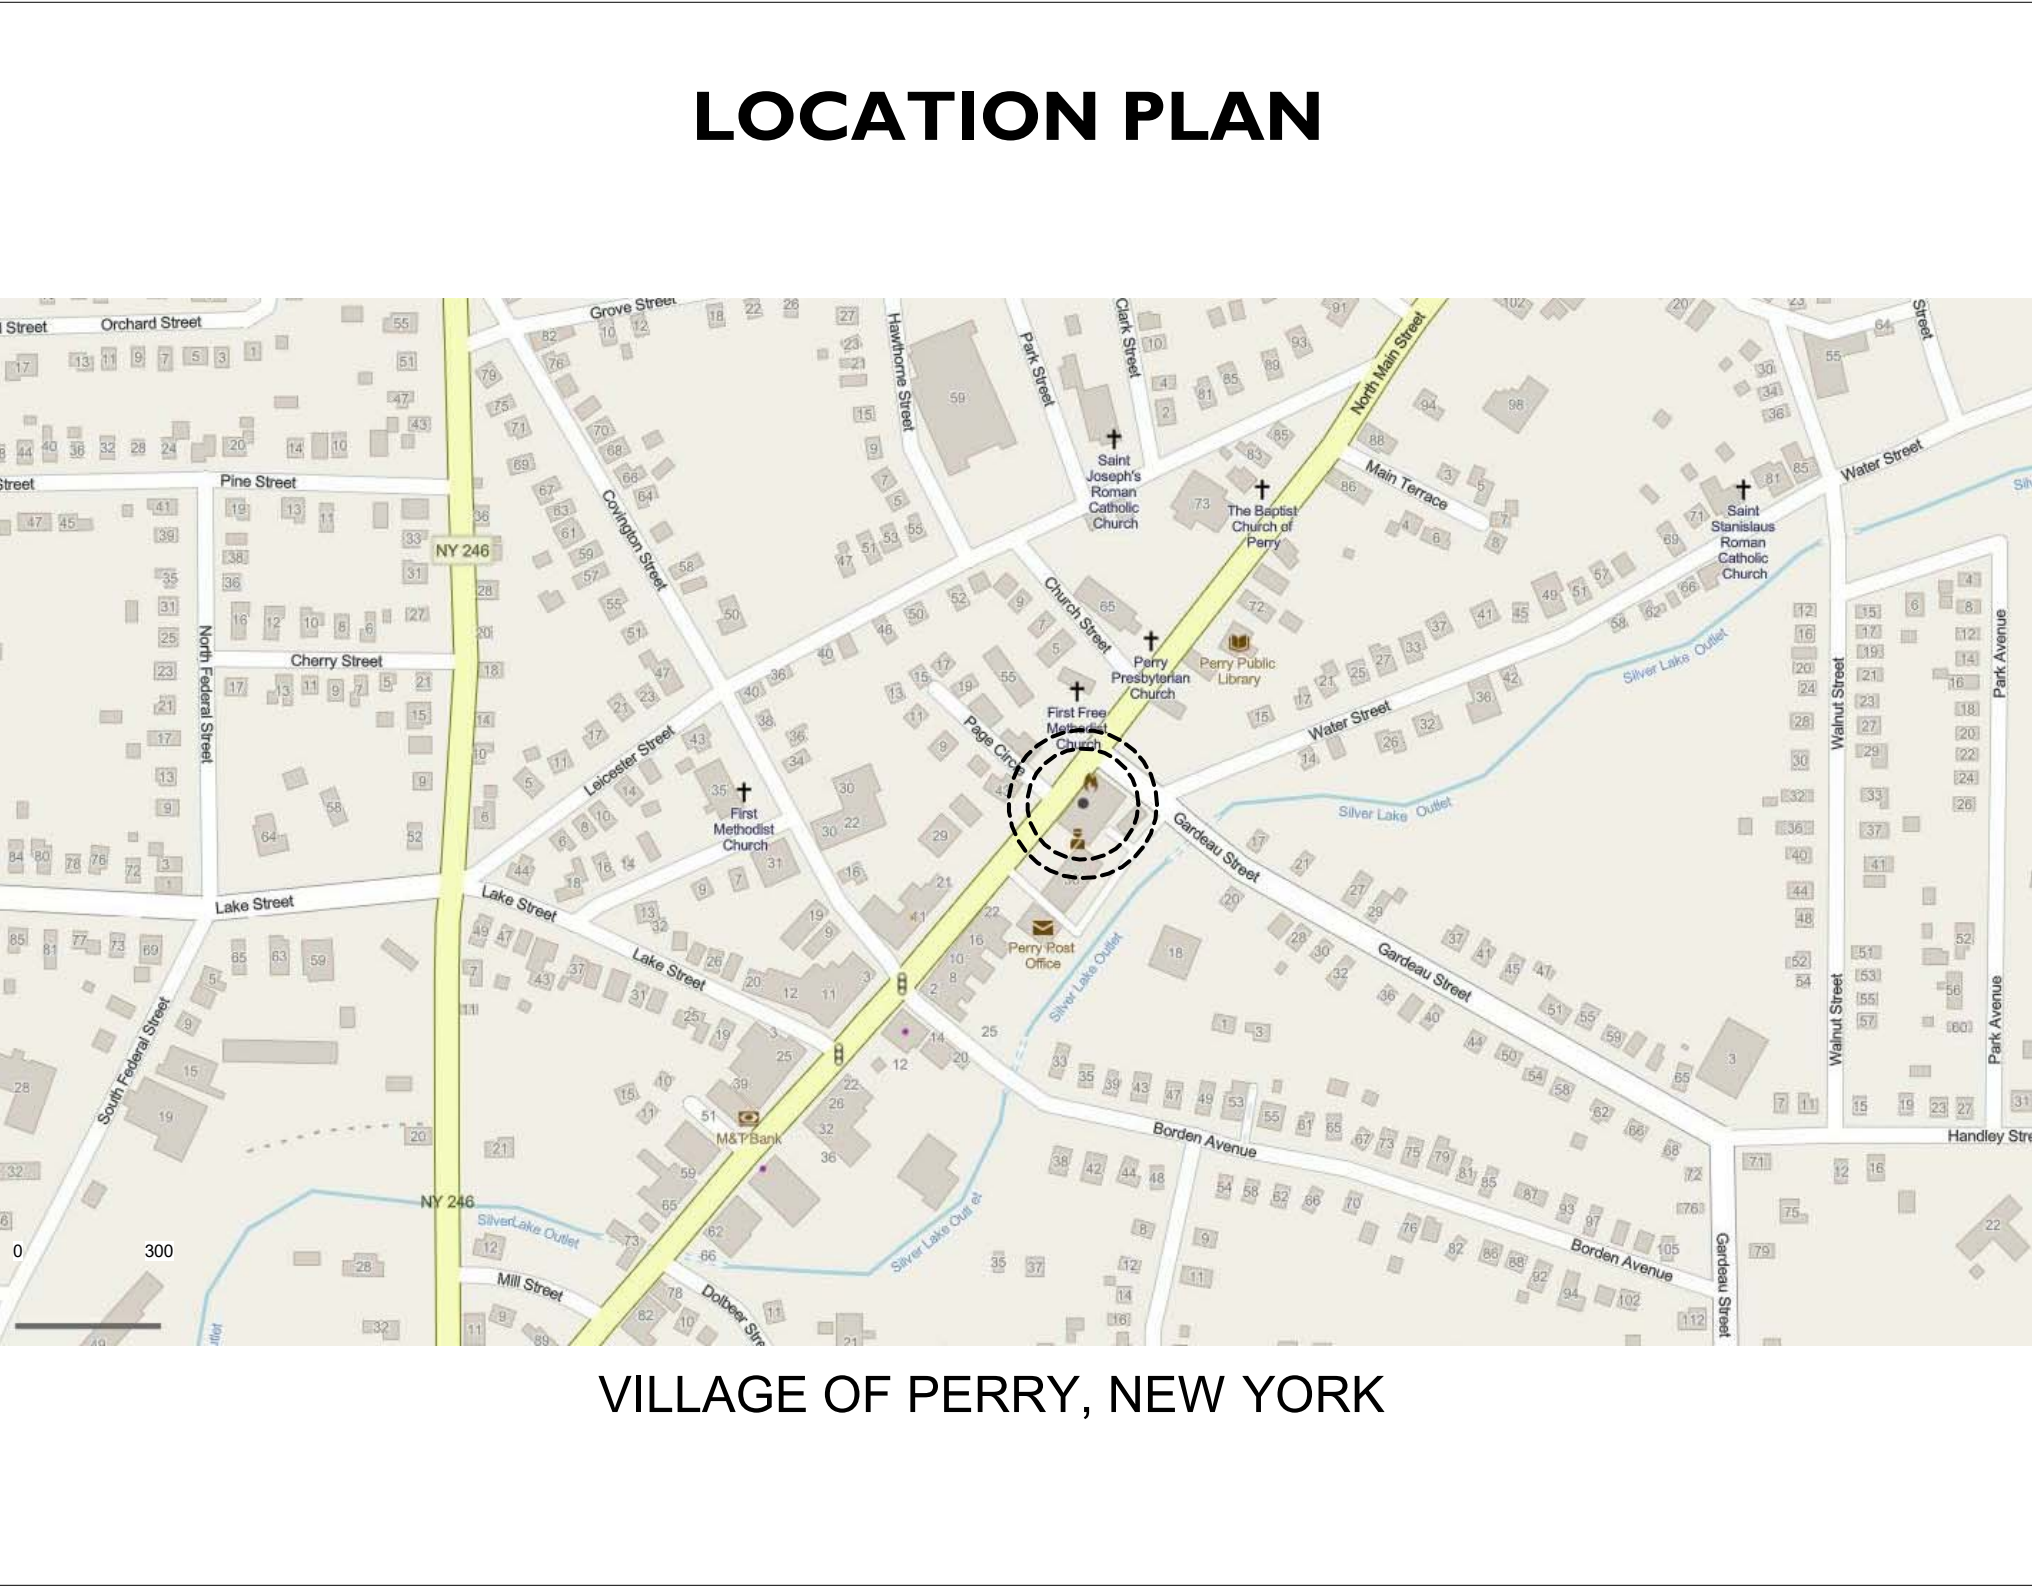



# ABBREVIATIONS

&	AND	EP	ELECTRICAL PANEL	MAS	MASONRY	SND	SANITARY NAPKIN
@	AT	EPDM	ETHYLENE	MATL	MATERIAL		DISPOSAL
AB	ANCHOR BOLT		PROPYLENE DIENE	MAX	MAXIMUM	SNT	SEALANT
AC	AIR CONDITIONING		M-CLASS	MECH	MECHANICAL	SP	STANDPIPE
ACC	ACCESSIBLE	EQ	EQUAL	MED	MEDIUM	SPEC	SPECIFIED OR
ACOUST	ACOUSTICAL	EQUIP	EQUIPMENT	MEMBR	MEMBRANE		SPECIFICATION
ACT	ACOUSTIC CEILING	EXH	EXHAUST	MH	MAN HOLE	SPK	SPRINKLER OR
	TILE	EXIST	EXISTING	MIN	MINIMUM		SPEAKER
AD	ACCESS DOOR	EXP	EXPANSION	MISC	MISCELLANEOUS	SQ	SQUARE
ADD	ADDENDUM	EXP'D	EXPOSED	MO	MASONRY OPENING	SS	STAINLESS STEEL
ADJ	ADJACENT	EXT	EXTERIOR	MR	MOISTURE	SSK	SERVICE SINK
AFF	ABOVE FINISHED	FA	FIRE ALARM	MTD	MOUNTED	ST&V	STAIN & VARNISH
FLOOR		FB	FACE BRICK	MTG	MOUNTING	STA	STATION
AFG	ABOVE FINISHED	FD	FLOOR DRAIN	MTL	METAL	STD	SOUND
GRADE		FDC	FIRE DEPARTMENT	MULL	MULLION	STC	TRANSMISSION
AGGR	AGGREGATE		CONNECTION				COEFFICIENT
ALT	ALTERNATE	FE	FIRE EXTINGUISHER	N	NORTH	STD	STANDARD
ALUM	ALUMINUM		(WALL MOUNT)	NA	NOT APPLICABLE	STG	SEATING
ANOD	ANODIZED	FEC	FIRE EXTINGUISHER	NC	NOISE CRITERIA	STL	STEEL
APC	ACOUSTICAL PANEL		CABINET	NIC	NOT IN CONTRACT	STOR	STORAGE
CEILING		FF&E	FURNITURE,	NO	NUMBER	STRG	STRINGER
APPROX	APPROXIMATE		FIXTURES AND	NOM	NOMINAL	STRUCT	STRUCTURE OR
ARCH	ARCHITECTURAL	FFB	EQUIPMENT	NON COMB	NON COMBUSTIBLE		STRUCTURAL
ASPH	ASPHALT	FFEL	FLUSH FLOOR BOX	NTS	NOT TO SCALE	SUBCAT	SUBCATEGORY
ATTN	ATTENTION		FINISH FLOOR	NW	NORTHWEST	SUSP	SUSPENDED
AUTO	AUTOMATIC	FH	ELEVATION	OA	OUTSIDE AIR	SV	SHEET VINYL
AV	AUDIO/VISUAL	FHC	FLAT HEAD	OC	ON CENTER	SW	SOUTHWEST
BD	BOARD	FIN	FIRE HOSE CABINET	OD	OUTSIDE DIAMETER	SYM	SYMMETRICAL
BET, BTW	BETWEEN	FIXT	FIXTURE	OD	OVERFLOW DRAIN	SYS	SYSTEM
BIT	BITUMINOUS	FL	FLOOR	OFCI	OWNER FURNISHED,	T	TREAD
BLDG	BUILDING	FLASH	FLASHING		CONTRACTOR	T&B	TOP AND BOTTOM
BLK	BLOCK	FLUOR	FLUORESCENT	OFF	INSTALLED	T&G	TONGUE AND
BLKG	BLOCKING	FND	FOUNDATION	OFOI	OWNER FURNISHED,		GROOVE
BM	BEAM	FO	FACE OF		OWNER INSTALLED	TB	TOWEL BAR
BO	BOTTOM OF	FP	FIRE PROTECTION	OH	OPPOSITE HAND	TEL	TELEPHONE/TELECO
BOT	BOTTOM	FPG	FIREPROOFING	OPNG	OPENING		M
BRG	BEARING	FR	FIRE RESISTANT	OPP	OPPOSITE	TELE	TELEPHONE
BRK	BRICK	FRC	FIBER REINFORCED	ORD	OVERFLOW ROOF	TEMP	TEMPERATURE
BRKT	BRACKET		CONCRETE		DRAIN	TEMP	TEMPORARY
BSMNT	BASEMENT	FRT	FIRE RETARDANT	OVR	OVERHEAD	TH	THICKNESS
C	CHANNEL		TREATED			THR	THRESHOLD
CAB	CABINET	FT	FEET/FOOT	PAV	PAVING	THRU	THROUGH
CAT	CATEGORY	FTG	FOOTING	PBD	PARTICLE BOARD	TKBD	TACK BOARD
CB	CATCH BASIN	FURN	FURNITURE	PC	PRECAST	TLT	TOILET
CB	CEMENT BOARD	FURR	FURRING	PDF	POWER DRIVEN	TMPD	TEMPERED
CBU	CEMENTITIOUS	FWC	FABRIC WALL	PERF	PERFORATED	TO	TOP OF
BACKER UNIT			COVERING	PERIM	PERIMETER	TOB	TOP OF BEAM
CC	CENTER TO CENTER	FWP	FABRIC WRAPPED	PERP	PERPENDICULAR	TOC	TOP OF CONCRETE
CCTV	CLOSED CIRCUIT		PANEL	PI	PLATE	TOS	TOP OF STEEL
CEM	CEMENT	GA	GAUGE	PLAM	PLASTIC LAMINATE	TPD	TOILET PAPER
CER	CERAMIC	GALV	GALVANIZED	PLAS	PLASTER		DISPENSER
CG	CORNER GUARD	GB	GRAB BAR	PLBG	PLUMBING	TS	TUBE STEEL
CH	CHILLER	GC	GENERAL	PLF	POUNDS PER LINEAR	TV	TELEVISION
CI	CAST IRON		CONTRACT(OR)		FOOT	TYP	TYPICAL
CIP	CAST-IN-PLACE	GEN	GENERAL	PLYWD	PLYWOOD	UL	UNDERWRITERS
CJ	CONTROL JOINT	GFRG	GLASS FIBER	PNL	PANEL		LABORATORIES
CL	CENTERLINE		REINFORCED	PNT	PAINT OR PAINTED	UNFIN	UNFINISHED
CLG	CEILING	GL	CONCRETE	POL	POLISHED	UNO	UNLESS NOTED
CLR	CLEAR	GLAZ	GLASS	POLYISO	POLYISOCYANURATE		OTHERWISE
CLT	CLOSET	GRAN	GLAZING	PR	PAIR	UON	UNLESS OTHERWISE
CMT	CERAMIC MOSAIC	GRD	GRANULAR	PREFAB	PREFABRICATED	URNL	NOTED
TILE		GRFG	GROUND	PROJ	PROJECT	VAC	URNAL
CMU	CONCRETE		GLASS FIBER	PSF	POUNDS PER		VENTILATION AND
MASONRY UNIT			REINFORCED		SQUARE FOOT		AIR CONDITIONING
CNTR	COUNTER	GSM	GYPSUM			VAR	VARIES
COL	CLEANOUT		GALVANIZED SHEET	PT	PRESSURE TREATED		VINYL ASBESTOS
COL	COLUMN	GV	METAL	PTN	PARTITION	VB	TILE
CONC	CONCRETE	GWB	GAS VALVE	PVC	POLYVINYL	VCT	VAPOR BARRIER
COND	CONDITION		GYPSUM WALL		CHLORIDE		VINYL COMPOSITION
CONN	CONNECTION	GYP	BOARD	QT	QUARRY TILE		TILE
CONST	CONSTRUCTION	H	GYPSUM	QTY	QUANTITY	VERT	VERTICAL
CONT	CONTINUOUS	HB	HIGH/HEIGHT	R	RADIUS/RISER	VEST	VESTIBULE
CONTR	CONTRACTOR	HC	HOSE BIB	RA	RETURN AIR	VIF	VERIFY IN FIELD
COORD	COORDINATE	HID	HANDICAPPED	RAD	RADIUS	VP	VISION PANEL
CORR	CORRIDOR	HDWD	HARDWARE	RB	RESILIENT BASE	VR	VAPOR RETARDER
CPT	CARPET	HM	HARDWOOD	RBR	RUBBER	VT	VINYL TILE
CT	CERAMIC TILE	HNDRL	HOLLOW METAL	RCP	REFLECTED CEILING	VTR	VENT THROUGH
CTR	CENTER	HO	HANDRAIL		PLAN		ROOF
CTSK	COUNTERSUNK	HORIZ	HOLD OPEN	RD	ROOF DRAIN	VWC	VINYL WALL
CW	COLD WATER	HP	HORIZONTAL	REC	RECESSED		COVERING
CWT	CERAMIC WALL TILE	HR	HIGH POINT	RECPT	RECEPTACLE	W	WIDEST
D	DEEP, DEPTH	HRC	HOUR	REF	REFERENCE	W/	WITH
DBL	DOUBLE	HT	HOSE REEL CABINET	REFR	REFRIGERATOR	WC	WITHOUT
DEG	DEGREE	HTR	HEIGHT	REG	REGISTER	WO	WATER CLOSET
DEMO	DEMOLISH OR	HVAC	HEATER	REINF	REINFORCED/REINFO	W	WOOD
DEMOLITION			HEATING			WM	WINDOW
DEPT	DEPARTMENT	HW	VENTILATION AND	REL	RELOCATE	WIN	WIRE MESH
DET	DETAIL		AIR CONDITIONING	REM	REMOVABLE	WP	WATERPROOF/WATE
DF	DRINKING FOUNTAIN	ID	HOT WATER	REOOM	RECOMMENDED		RPROOFING
DIA	DIAMETER	IGU	INSIDE DIAMETER	REQ	REQUIRE/REQUIRED	WPM	WATERPROOF
DIFF	DIFFUSER		INSULATED GLASS	RESIL	RESILIENT		MEMBRANE
DIM	DIMENSION	IN	UNIT	REV	REVISION/REVISED	WS	WEATHER-STRIPPING
DIMS	DIMENSIONS	INCD	INCH/INCHES	RM	ROOM	WSCT	WAINSCOT
DISP	DISPENSER	INCL	INCANDESCENT	RND	ROUND	WT	WEIGHT
DIV	DIVISION		INCLUDED/INCLUDIN	RO	ROUGH OPENING	WV	WATER VALVE
DMPF	DAMP PROOFING	INFO	G	ROW	RIGHT OF WAY	WWF	WELDED WIRE
DN	DOWN	INSUL	INFORMATION	RTD	RATED		FABRIC
DO	DOOR OPENING		INSULATION OR	RTL	RATING	WWM	WELDED WIRE MESH
DR	DOOR	INT	INSULATED	RWL	RAIN WATER LEADER		
DRN	DRAIN	INTERM	INTERIOR	S	SOUTH		
DS	DOWNSPOUT	INV	INTERMEDIATE	S/S	SANITARY/STORM		
DTL	DETAIL	JAN	INVERT		SEWER		
DW	DISHWASHER	JC	JANITOR	SA	SUPPLY AIR		
DWG	DRAWING	JST	JANITOR'S CLOSET	SAF	SELF ADHERED		
DWR	DRAWER	JT	JOIST		FLASHING		
E	EAST	KIT	JOINT	SC	SOLID CORE		
EA	EACH	KO	KITCHEN	SCHED	SCHEDULE		
EB	EXPANSION BOLT	LM	KNOCK OUT	SD	STORM DRAIN		
EJ	EXPANSION JOINT	LAV	LAMINATED	SE	SOUTHEAST		
EL	ELEVATION	LB	LAVATORY	SECT	SECTION		
ELEC	ELECTRICAL	LF	POUNDS	SF	SQUARE FEET/FOOT		
ELEV	ELEVATOR	LLH	LINEAR FEET	SH	SPRINKLER HEAD		
EMER	EMERGENCY	LLV	LONG LEG	SHR	SHOWER		
ENCL	ENCLOSURE	LT	HORIZONTAL	SHT	SHEET		
ENG	ENGINEER	LWT	LONG LEG VERTICAL	SIM	SIMILAR		
		MANUF	LIGHT	SM	SHEET METAL		
			LIGHTWEIGHT	SM	SURFACE MOUNTED		
			MANUFACTURER				



GRANT REQUIREMENTS & HISTORIC SIGNIFICANCE:	GRANT FUNDING REQUIREMENTS:
<p><b>HISTORIC SIGNIFICANCE:</b></p> <p>PERRY VILLAGE HALL HAS BEEN DETERMINED ELIGIBLE FOR LISTING ON THE NATIONAL REGISTER OF HISTORIC PLACES. ALL WORK OF THIS PROJECT MUST BE COMPLETED IN ACCORDANCE WITH THE "SECRETARY OF THE INTERIOR'S STANDARDS", LATEST EDITION.</p>	<p>THIS PROJECT IS FUNDED BY A COMMUNITY DEVELOPMENT BLOCK GRANT PROVIDED BY THE U.S. DEPARTMENT OF HOUSING AND URBAN DEVELOPMENT (HUD) AND ADMINISTERED BY THE NYS OFFICE OF COMMUNITY RENEWAL (OCR). ALL WORK MUST BE COMPLETED ACCORDING TO THE REQUIREMENTS LISTED IN THE PROJECT MANUAL.</p>

DRAWING LIST			
<b>CODE CONFORMANCE</b> CC-01	CODE CONFORMANCE		
<b>SITework</b> A1-00	SITE PLAN		
<b>DEMOLITION</b> AD-01 AD-02	DEMOLITION PLANS DEMOLITION PLANS		
<b>ARCHITECTURAL</b> A1-01 A1-02 A2-01 A5-01 A5-02 A6-01 A6-02 A7-01	BASEMENT AND GROUND FLOOR PLANS FIRST AND SECOND FLOOR PLANS ELEVATIONS ELEVATOR PLANS, SECTION & DETAILS STAIR PLANS, SECTION & DETAILS WINDOW & DOOR SCHEDULES, TYPES & DETAILS PARTITION & FINISH SCHEDULES REFLECTED CEILING PLANS		
<b>STRUCTURAL</b> S1-01 S1-02 S2-01 S2-02	ELEVATOR PLANS STAIR PLANS DETAILS DETAILS		
<b>PLUMBING</b> P1-01	FIRST FLOOR PLAN - PLUMBING		
<b>MECHANICAL</b> M1-01	ATTIC PLAN - MECHANICAL		
<b>ELECTRICAL</b> ED-01 E-01 E-03	ELECTRICAL DEMOLITION PLAN ELECTRICAL FLOOR PLANS ELECTRICAL DETAILS AND SCHEDULES		



# PERRY VILLAGE HALL ADA IMPROVEMENTS

VILLAGE OF PERRY  
46 N. MAIN ST.  
PERRY, NY 14530  
CONSTRUCTION BID SET  
APRIL 5, 2021

## ARCHITECTURE

FLYNN BATTAGLIA ARCHITECTS, D.P.C.  
617 Main Street  
Suite 401  
Buffalo, New York 14203  
Telephone (716) 854-2424

## STRUCTURAL ENGINEERING

PETRILLI ENGINEERING, P.C.  
245 Kinsey Ave.  
Kenmore, New York 14217  
Telephone (716) 854-3508

## MEP/F ENGINEERING

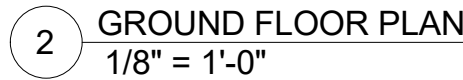
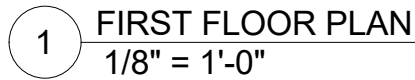
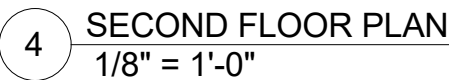
P.MAX ENGINEERING, P.C.  
598 Lafayette Ave.  
Suite 6  
Buffalo, NY 14222  
Telephone (716) 381-9389

## REFERENCE SYSTEMS

<b>VIEW TITLE</b> 1 View Name 1/8" = 1'-0" FINISH FLOOR ELEVATION IN FT. ABOVE SEA LEVEL ELEVATION MARKER (OCCURS AT BLDG. ELEVATIONS AND SECTIONS, AND AT WALL SECTIONS)	<b>BUILDING ENTRANCE</b> LOCATION OF LARGE SCALE PLAN 1 A101 AREA INCLUDED IN LARGE SCALE BLOW-UP OF PLAN ENLARGE SCALE PLAN MARKER
EXISTING WINDOW TAG WINDOW / STOREFRONT / LOUVER TAG WINDOW / STOREFRONT / LOUVER OPENING TAGS (OCCURS AT BUILDING PLANS, ELEVATIONS AND SECTIONS)	PARTITION TYPE NO. PARTITION TYPE (OCCURS AT 1/8" OR 1/4" SCALE DWGS)
INTERIOR ELEVATION NO. SHEET NO. INTERIOR ELEVATION (OCCURS AT PLAN DRAWINGS)	MATCH CURRENT DWG. W/ WITH THIS DWG. TO COMPLETE FLOOR PLAN, ELEVATION OR SECTION 1 / A101 MATCH LINE TAG
EXTERIOR ELEVATION NO. SHEET NO. EXTERIOR ELEVATION (OCCURS AT PLAN DRAWINGS)	DETAIL NO. 1 A101 SHEET NO. SECTION NO. 1 A101 SHEET NO. DETAIL TAG / WALL SECTION / BUILDING SECTION TAG

## KEY TO MATERIALS

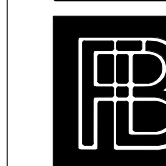
	WOOD BLOCKING OR GROUNDS
	FINISHED WOOD TRIM OR MOLDING
	PLYWOOD
	RIGID INSULATION
	BATT INSULATION
	CONCRETE
	CMU
	BRICK MASONRY
	STONE
	PLASTER / STUCCO
	GYPSUM WALL BOARD (GWB)
	SOLID SURFACE



CC-01

The floor plan shows a rectangular building with several rooms. A north arrow is located in the bottom left corner, pointing towards the top-left. To the right of the north arrow is a diagram showing a circle with a vertical line and a horizontal line, with the letter 'N' above it and the word 'PROJECT' below it.

DATE 01/05/2020



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245 Kinsey Ave  
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VILLAGE OF PERRY  
46 N. MAIN ST.  
PERRY, NY 14530

**100% CONSTRUCTION  
DOCUMENT BID SET**

NOTES &amp; REVISIONS:

Revision Schedule		
Revision Number	Date	Description

DRAWING ISSUED: APRIL 5, 2021

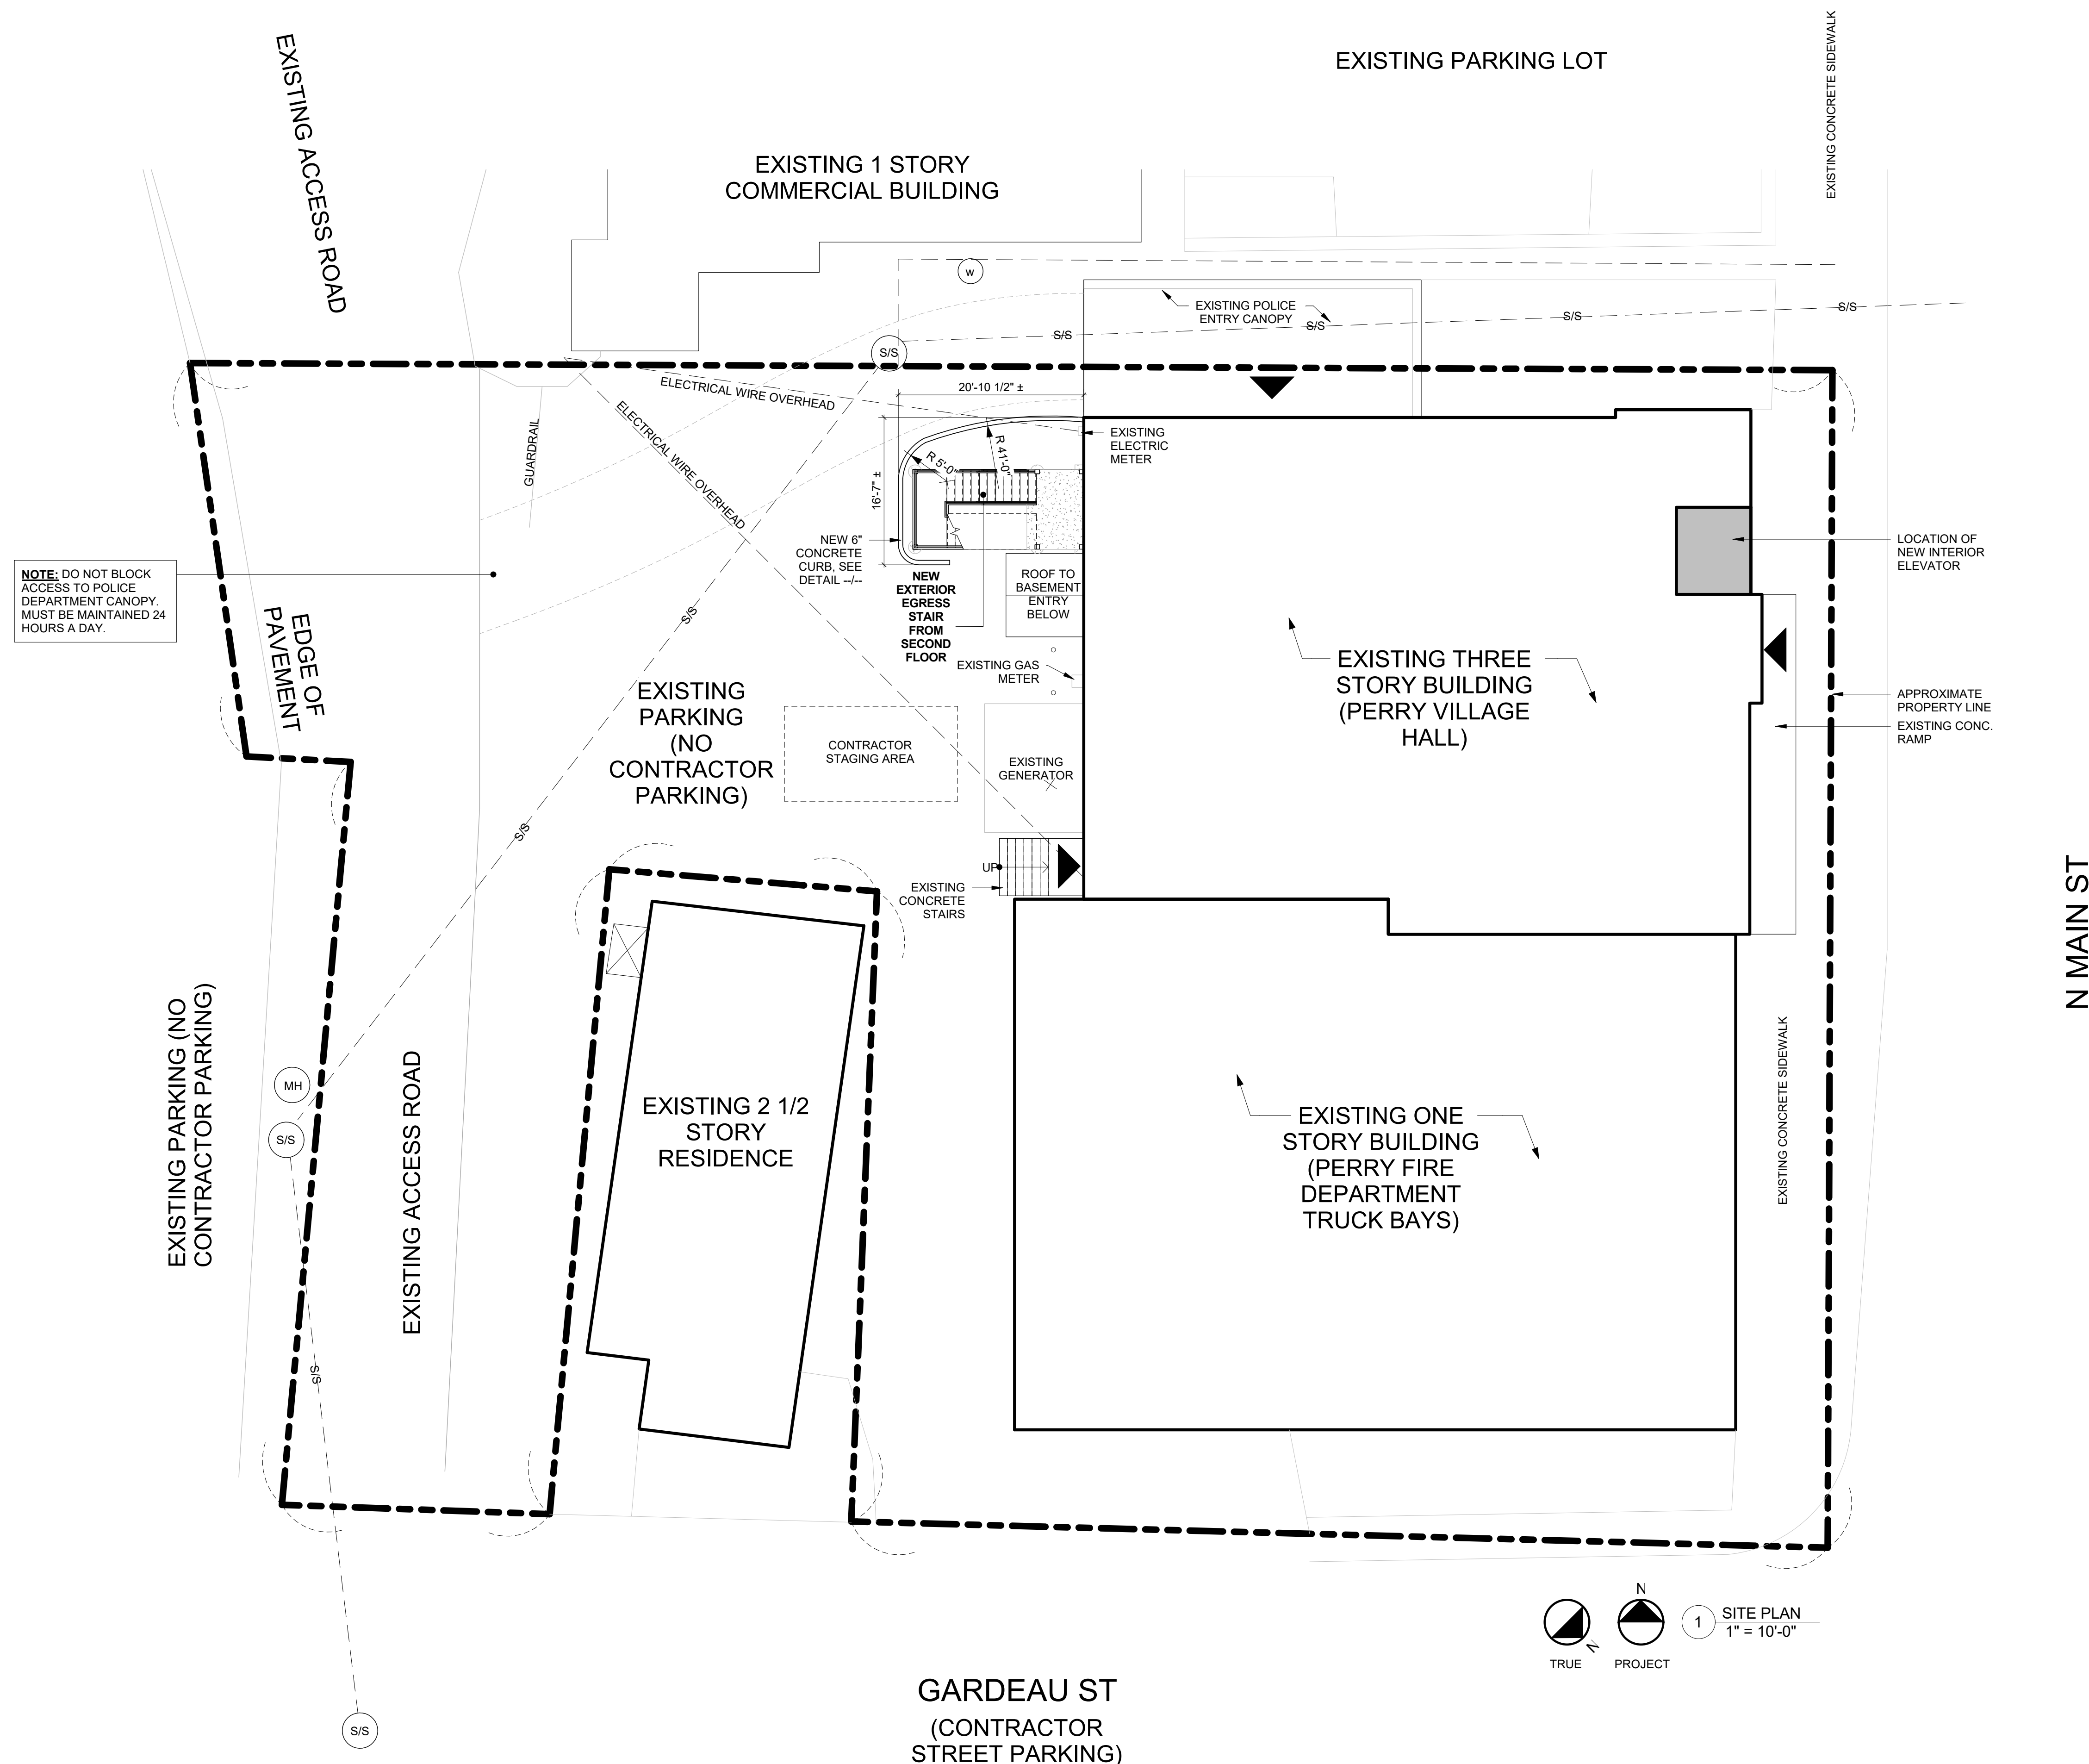
Project Number:	Scale:
00370	1" = 10'-0"

Drawn By: MB	Checked By: MM, LM
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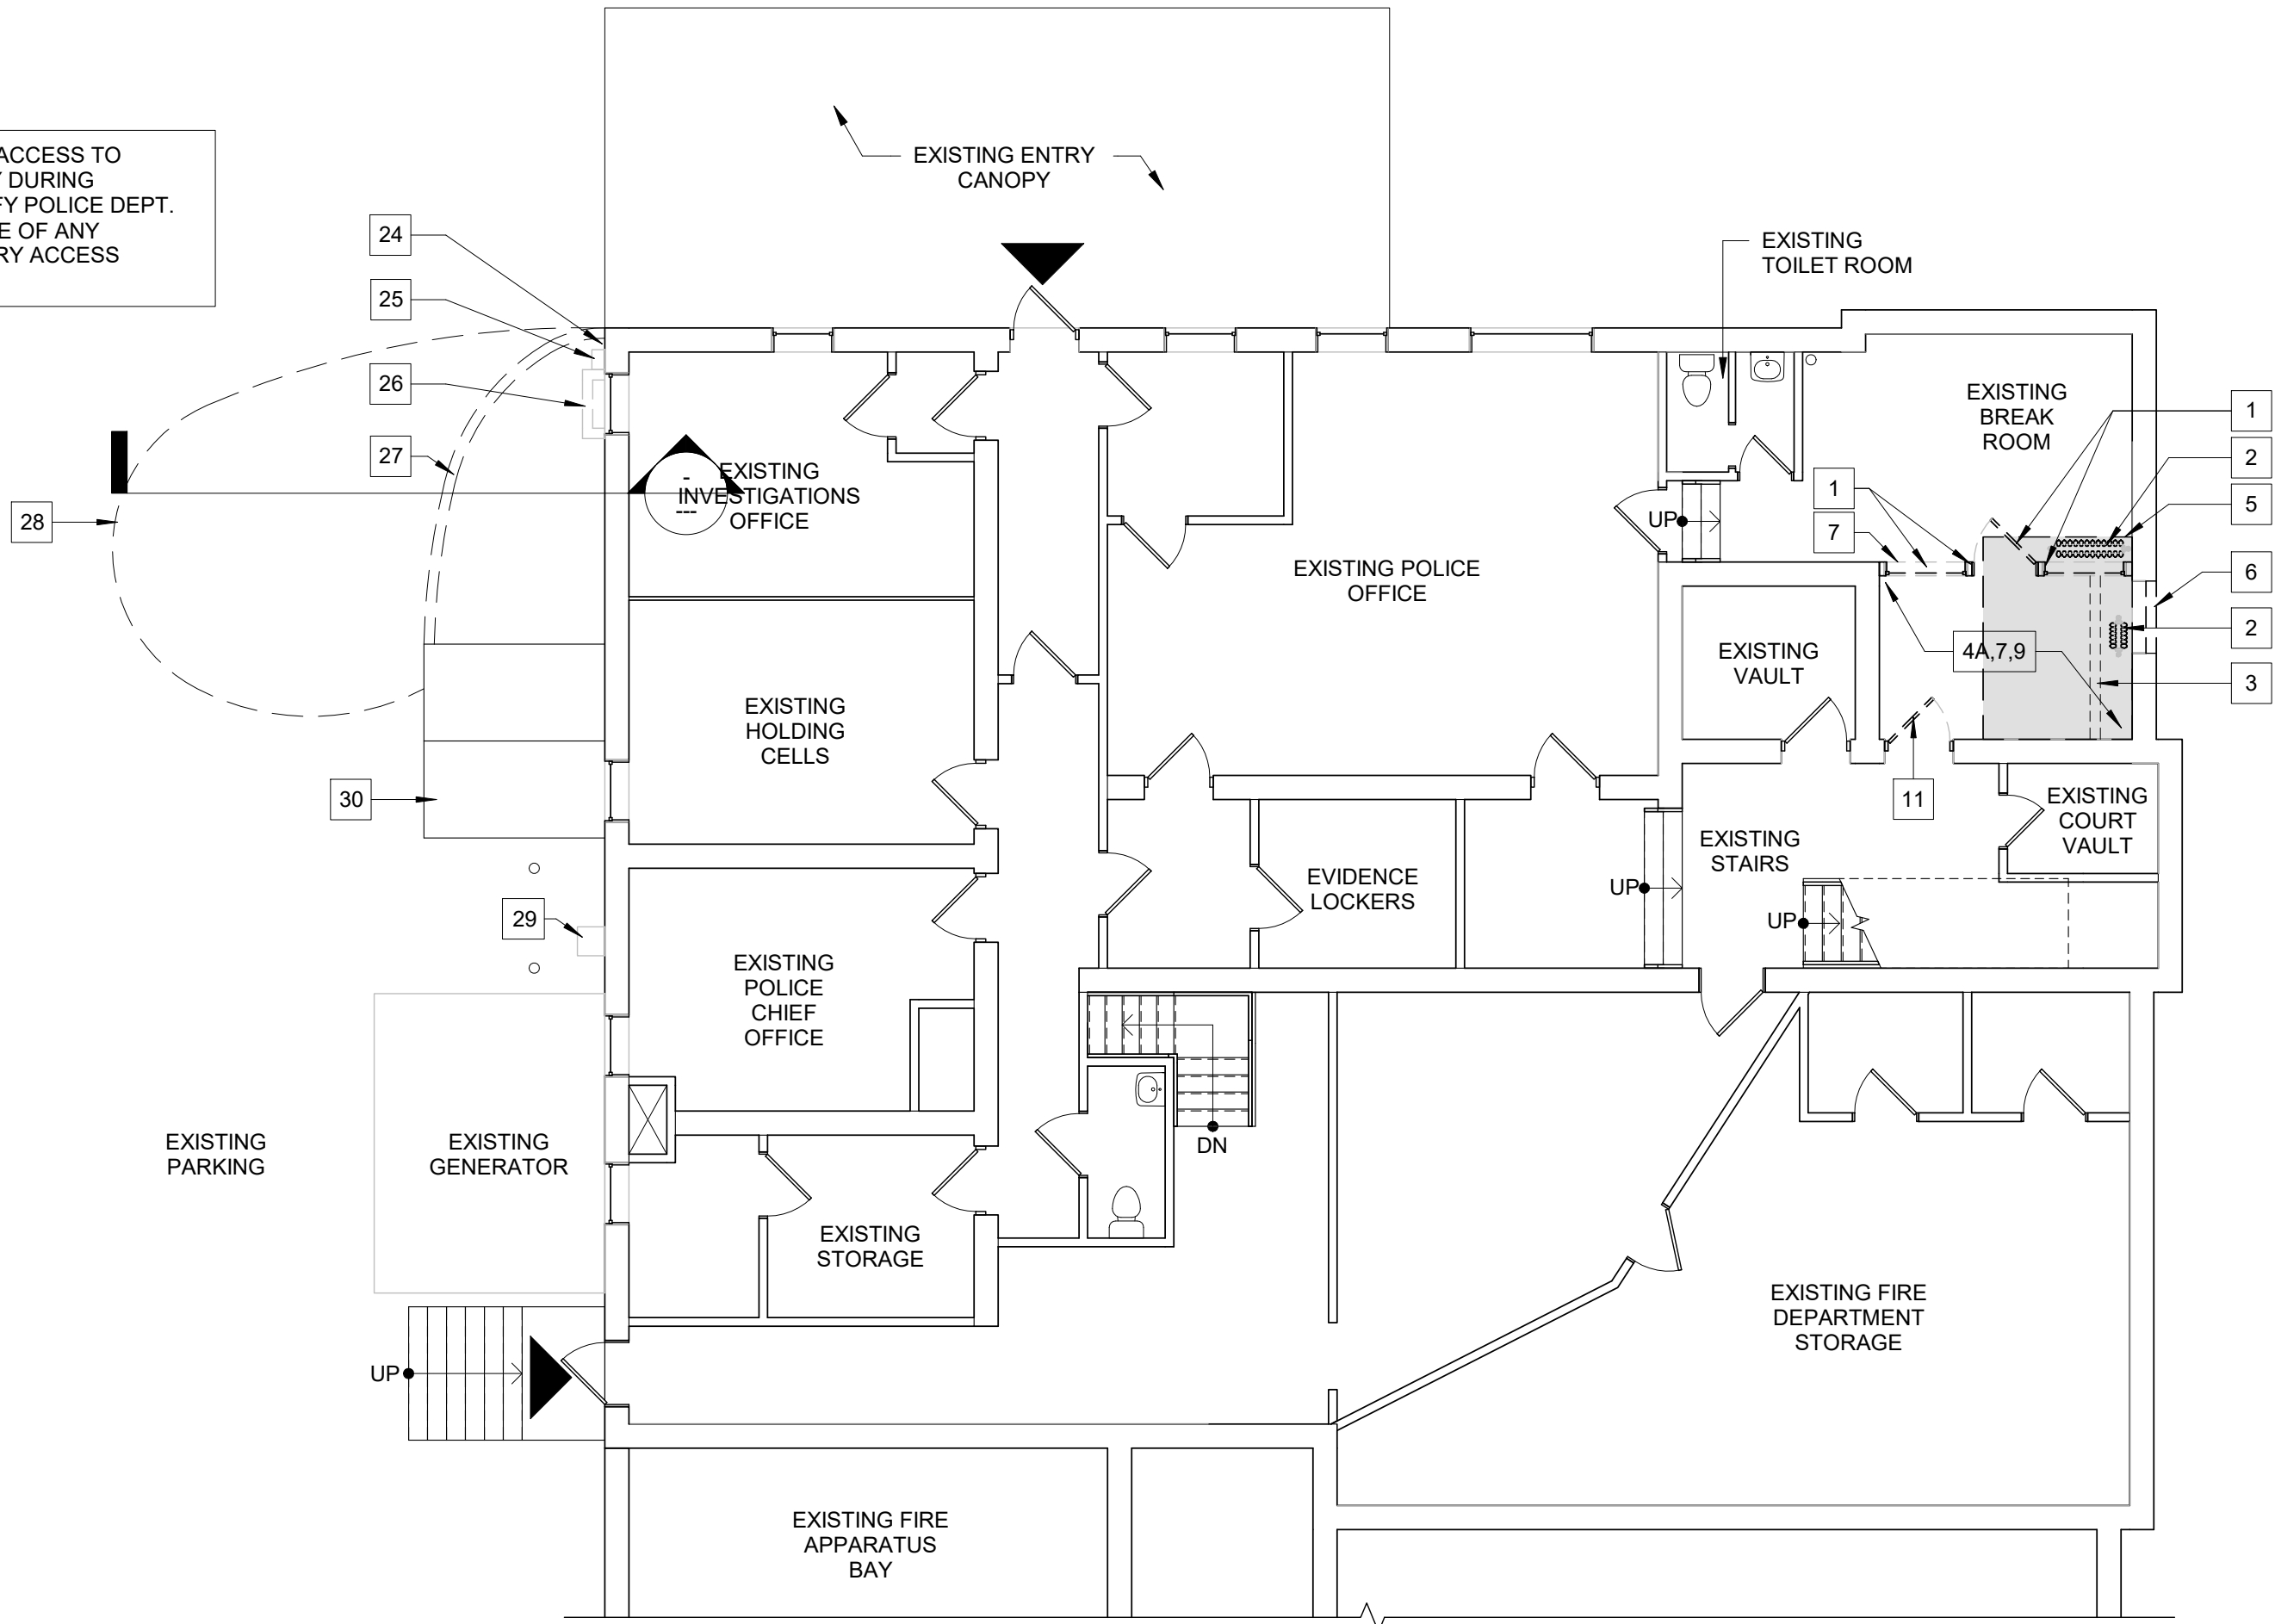
Drawing Title  
SITE PLAN

Drawing Number

A1-00



NOTE: MAINTAIN 24 HR ACCESS TO POLICE ENTRY CANOPY DURING REMOVAL WORK. NOTIFY POLICE DEPT. MIN. 72 HRS IN ADVANCE OF ANY NECESSARY TEMPORARY ACCESS LIMITATIONS



1 GROUND FLOOR DEMOLITION PLAN  
1/8" = 1'-0"

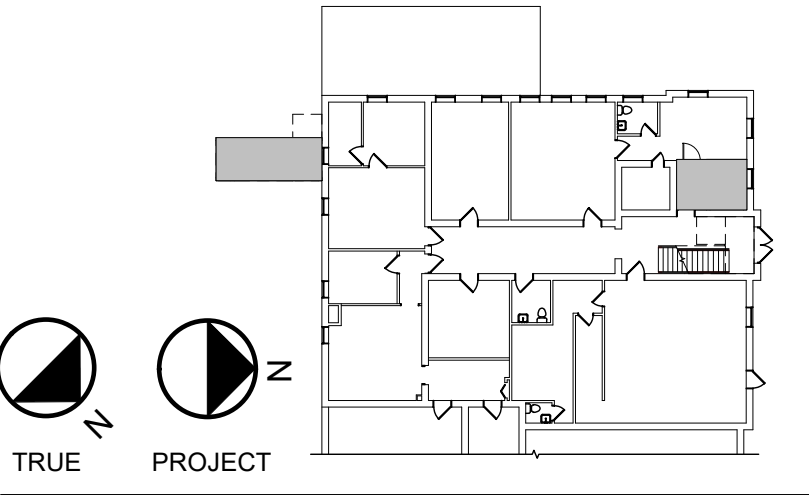
GENERAL DEMOLITION NOTES (FLOOR PLANS):

- A. DRAWINGS MAY NOT INDICATE ALL DEMOLITION / REMOVALS. CONTRACTOR IS TO REFER TO ALL DRAWINGS, SPECIFICATIONS AND FIELD CONDITIONS TO DETERMINE FULL SCOPE AND PARTICULARS OF REMOVAL REQUIREMENTS PRIOR TO CONSTRUCTION.
- B. ALL DIMENSIONS ARE +/- AND ARE TO BE VERIFIED IN FIELD BEFORE PROCEEDING WITH WORK.
- C. RESTORE ALL EXIST. CONDITIONS DAMAGED DURING REMOVAL WORK AND NOT SCHEDULED TO BE REMOVED, TO MATCH EXIST. CONDITIONS. ALL AREAS REQUIRING CUTTING AND PATCHING SHALL BE FINISHED TO MATCH ADJACENT SURFACES UNLESS NOTED OTHERWISE. PATCH ALL HOLES IN FLOORS AND WALLS WITH A FIRE STOP MATERIAL (SEE SPECS) WHERE CONDUIT, PIPING, DUCTWORK, ETC. HAS BEEN REMOVED. COORD. WITH ELEC AND PLUMB. DRAWINGS.
- D. UNLESS OTHERWISE NOTED, ALL REMOVALS IDENTIFIED IN THESE NOTES BECOME PROPERTY OF THE CONTRACTOR MAKING THE REMOVAL.
- E. COORDINATE ALL DEMOLITION WORK INDICATED ON THIS DRAWING WITH THAT OF THE OTHER TRADES. COORD. WITH ELEC AND PLUMB. DRAWINGS FOR ADDITIONAL DEMOLITION WORK.
- F. STABILIZATION OF THE EXISTING PORTIONS OF THIS BUILDING SCHEDULED TO REMAIN DURING AND AFTER THE DEMOLITION WORK WILL REQUIRE A PARTICULAR SEQUENCE OF WORK.
- G. REFER TO ASBESTOS CONTAINING MATERIALS REPORT IN PROJECT MANUAL FOR REMOVALS REQUIRED IN THIS PROJECT'S SCOPE OF WORK PRIOR TO START OF CONSTRUCTION.
- H. ALL WORK AREAS INVOLVING DEMOLITION, CUTTING, MODIFICATION, ETC. TO ANY EXISTING MATERIALS SHALL BE CONSIDERED A LEAD HAZARD AREA.
- J. DUE TO THE HISTORIC NATURE OF THIS EXISTING BUILDING, ALL WORK AREAS SHOULD BE PROPERLY PROTECTED AND THOROUGHLY CLEANED AT THE END OF CONSTRUCTION.

SPECIFIC FLOOR PLAN DEMOLITION NOTES:

- 1. REMOVE EXISTING WALL, INCLUDING EXISTING DOOR AND WINDOW ASSEMBLIES IN THEIR ENTIRETY (SALVAGE AND RETURN TO OWNER), PROVIDE SUPPORT AT WALL REMOVAL AS REQUIRED.
- 2. SALVAGE EXISTING RADIATOR FOR REINSTALLATION, SEE MEP DRAWINGS FOR MORE INFORMATION.
- 3. REMOVE EXISTING STEAM PIPING AS REQUIRED FOR NEW ELEVATOR SHAFT WALLS, SEE MEP DRAWINGS FOR MORE INFORMATION.
- 4. REMOVE EXISTING FLOOR TILE IN ITS ENTIRETY INCLUDING MASTIC TO CONCRETE FLOOR BELOW. FLOOR TILE IS KNOWN TO BE ASBESTOS-CONTAINING, SEE HAZMAT REPORT IN PROJECT MANUAL FOR MORE INFORMATION.
- 4A. REMOVE EXISTING FLOOR TILE IN ITS ENTIRETY.
- 5. SAWCUT EXISTING CONCRETE SLAB AS REQUIRED FOR NEW FOUNDATIONS, SEE S-SERIES DRAWINGS FOR MORE INFORMATION.
- 6. REMOVE EXISTING INFILL, WOOD SILL AND TRIM AT EXISTING OPENING IN WALL, PREP FOR INFILL.
- 7. REMOVE EXISTING WOOD CHAIR RAIL AT WALLS IN THEIR ENTIRETY, SALVAGE AND RETURN TO OWNER.
- 8. CAREFULLY REMOVE EXISTING WOOD DOOR & FRAME IN ITS ENTIRETY. SALVAGE FOR RE-INSTALLATION.
- 9. SALVAGE EXISTING SURFACE MOUNTED LIGHT AT CEILING FOR REINSTALLATION, SEE E-SERIES DRAWINGS FOR MORE INFORMATION.
- 10. REMOVE PORTION OF LOAD-BEARING WALL (ASSUMED) AS REQUIRED FOR NEW OPENING, SHORE AS REQUIRED, SEE S-SERIES DWGS.
- 11. TEMPORARILY REMOVE DOOR FROM HINGES AND STORE AWAY FROM WORK AREA, REINSTALL AT CONCLUSION OF WORK. PROTECT DOOR FRAME DURING CONSTRUCTION.
- 12. REMOVE EXISTING WINDOW IN ITS ENTIRETY, REMOVE PORTION OF EXISTING BRICK WALL BELOW WINDOW TO EXISTING SECOND FINISHED FLOOR ELEVATION, PREP FOR NEW DOOR, MODIFY EXISTING LINTEL AS REQUIRED FOR NEW DOOR OPENING.
- 13. REMOVE PORTION OF LOAD-BEARING (ASSUMED) AS REQUIRED FOR NEW DOOR OPENING, SHORE AS REQUIRED, SEE S-SERIES DWGS.
- 14. REMOVE EXISTING METAL DOOR & FRAME IN ITS ENTIRETY.
- 15. REMOVE EXISTING PLUMBING FIXTURES IN THEIR ENTIRETY, CAP PLUMBING AS REQUIRED, SEE P-SERIES DWGS.
- 16. REMOVE SURFACE MOUNTED LIGHT AT CEILING ABOVE, SALVAGE FOR REINSTALLATION, SEE E-SERIES DWGS FOR MORE INFORMATION.
- 17. REMOVE EXISTING WINDOWS IN THEIR ENTIRETY, PREP FOR NEW WINDOW.
- 18. REMOVE PORTION OF EXISTING WOOD FLOOR STRUCTURE AS REQUIRED FOR NEW ELEVATOR, SHORE AS REQUIRED, SEE S-SERIES DWGS FOR DETAILS FOR RE-SUPPORTING FLOOR SURROUNDING OPENING.
- 19. EXISTING WOOD FLOOR TO BE PROTECTED DURING CONSTRUCTION.
- 20. REMOVE EXISTING CARPET IN ITS ENTIRETY. NOTIFY ARCHITECT OF CONDITION OF EXISTING TILE INCLUDING AREAS OF DAMAGED OR MISSING TILE. IF ARCHITECT DECIDES THAT THE TILE IS ARE IN ACCEPTABLE CONDITON, CONTRACTOR TO CAREFULLY CLEAN ADHESIVE FROM THE EXISTING TILE. USE A MIXTURE OF WARM WATER, AMMONIA, AND A TEASPOON OF MILD DISH DETERGENT PER BUCKET OF WATER, SCRUB USING A NYLON OR NATURAL BRISTLE BRUSH. IF THIS MIXTURE IS INSUFFICIENT TO FULLY REMOVE ADHESIVE, COORDINATE WITH ARCHITECT. DO NOT USE A MORE ABRASIVE METHOD WITHOUT ARCHITECT'S APPROVAL. WHERE TILE IS MISSING OR DAMAGED, REPLACE WITH SALVAGED OR NEW MOSAIC TILE TO MATCH (INCLUDING GROUT COLOR). REPLACEMENT TILE CAN BE SOURCED FROM MULTIPLE MANUFACTURERS INCLUDING: AMERICAN RESTORATION TILE, MABELVALE, AR, PH: (501) 455-1000.
- 21. REMOVE PORTION OF EXISTING CONCRETE FLOOR STRUCTURE AS REQUIRED FOR NEW ELEVATOR, SHORE AS REQUIRED, SEE S-SERIES DWGS FOR DETAILS FOR RE-SUPPORTING FLOOR SURROUNDING OPENING.
- 22. REMOVE EXISTING NON-LOAD BEARING WALL AS SHOWN. PATCH AND REPAIR EXISTING WALL AND ADJACENT FINISHES TO REMAIN (MATCH EXISTING).
- 23. CAREFULLY REMOVE WOOD DOOR & FRAME IN ITS ENTIRETY, SALVAGE AND RETURN TO OWNER.
- 24. REMOVE EXISTING EXTENSION AT BASE OF DOWNSPOUT.
- 25. EXISTING ELECTRIC METER TO REMAIN.
- 26. REMOVE EXISTING WINDOW & CONCRETE WINDOW WELL AT BASEMENT LEVEL (GROUND FLOOR LEVEL WINDOW TO REMAIN).
- 27. REMOVE EXISTING CONCRETE CURB AND ROCK BED, SALVAGE ROCKS FOR REINSTALLATION.
- 28. REMOVE PORTION OF EXISTING ASPHALT PARKING AREA AS REQUIRED FOR NEW EXTERIOR STAIR.
- 29. EXISTING GAS METER TO REMAIN.
- 30. EXISTING ROOF TO BASEMENT ENTRY BELOW.
- 31. EXISTING TILE FLOOR TO REMAIN.
- 32. EXISTING CARPET TO REMAIN.

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PERRY VILLAGE HALL  
ADA IMPROVEMENTS

VILLAGE OF PERRY  
46 N. MAIN ST.  
PERRY, NY 14530

100% CONSTRUCTION  
DOCUMENT BID SET

NOTES & REVISIONS:

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Revision Number	Date	Description

DRAWING ISSUED: APRIL 5, 2021

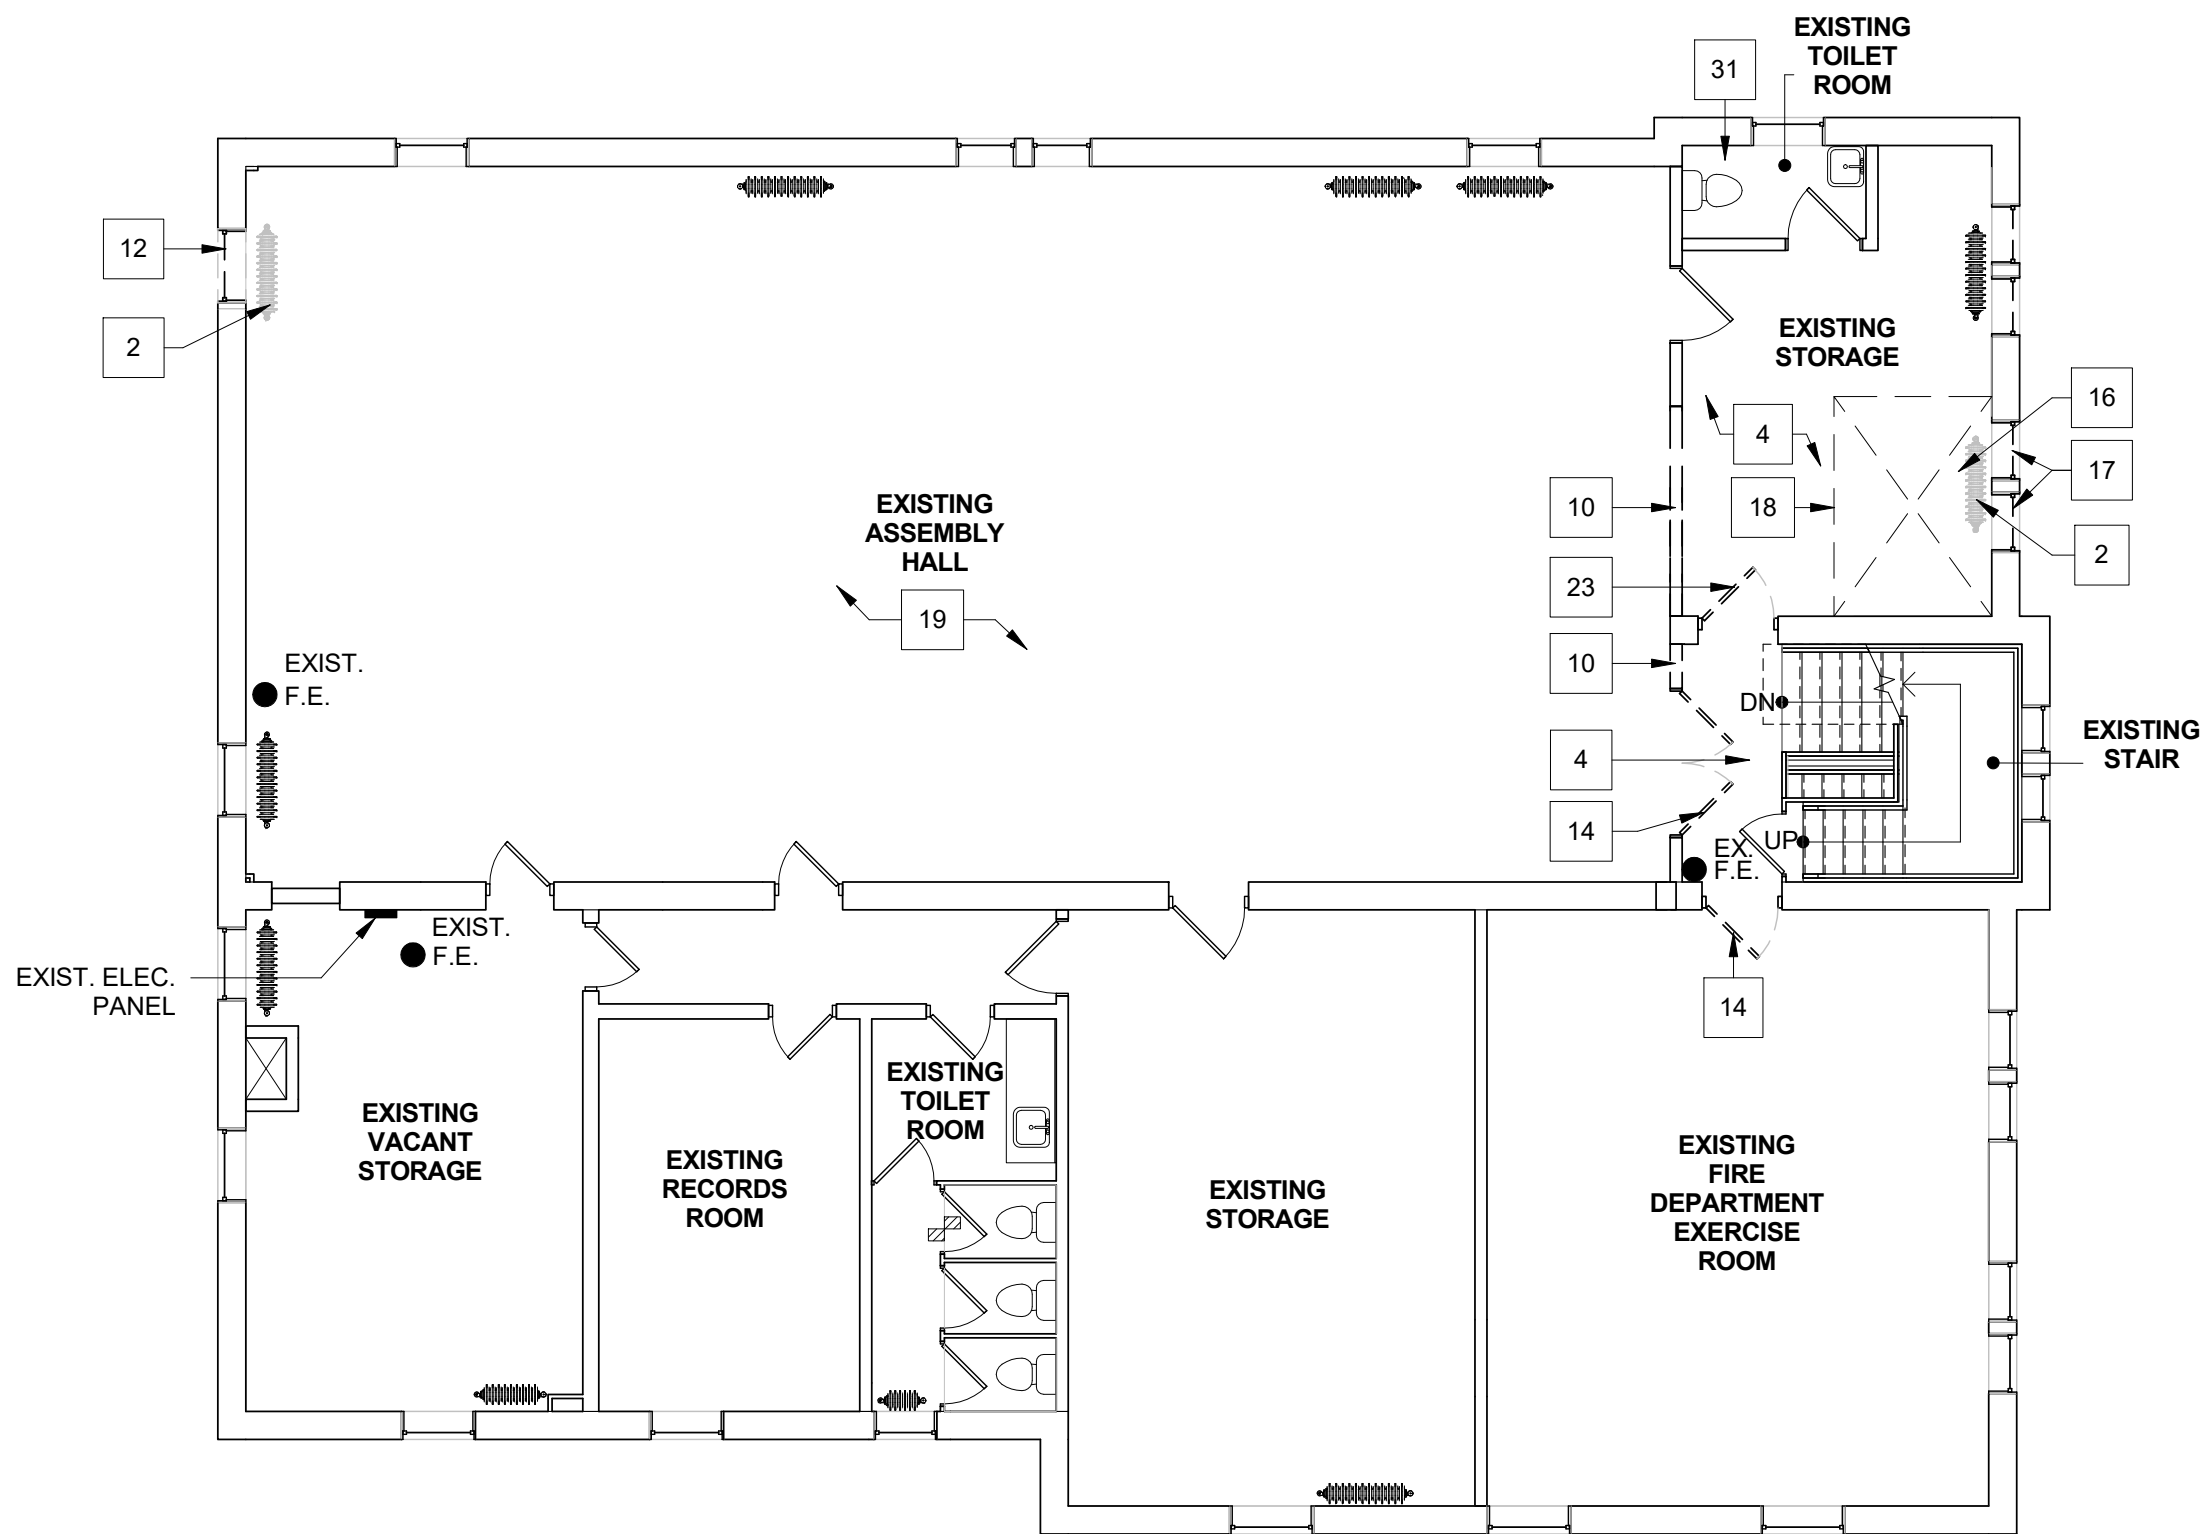
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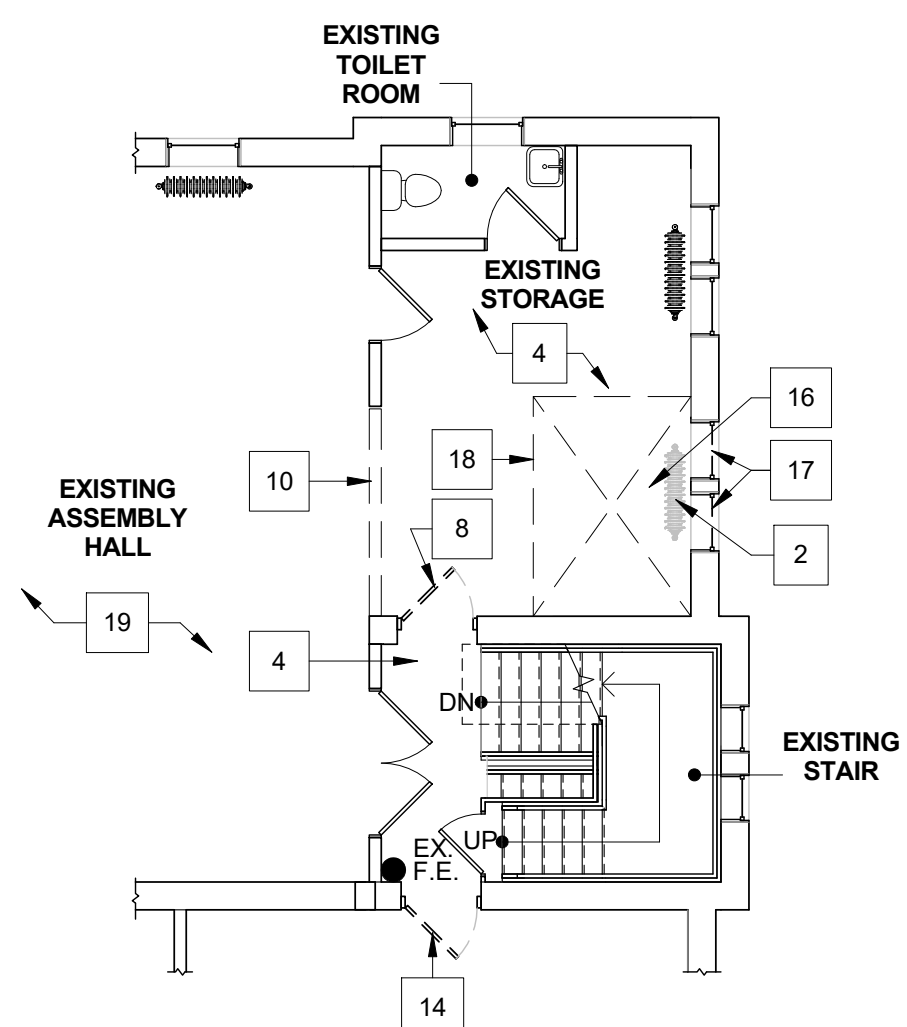
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DEMOLITION PLANS

Drawing Number

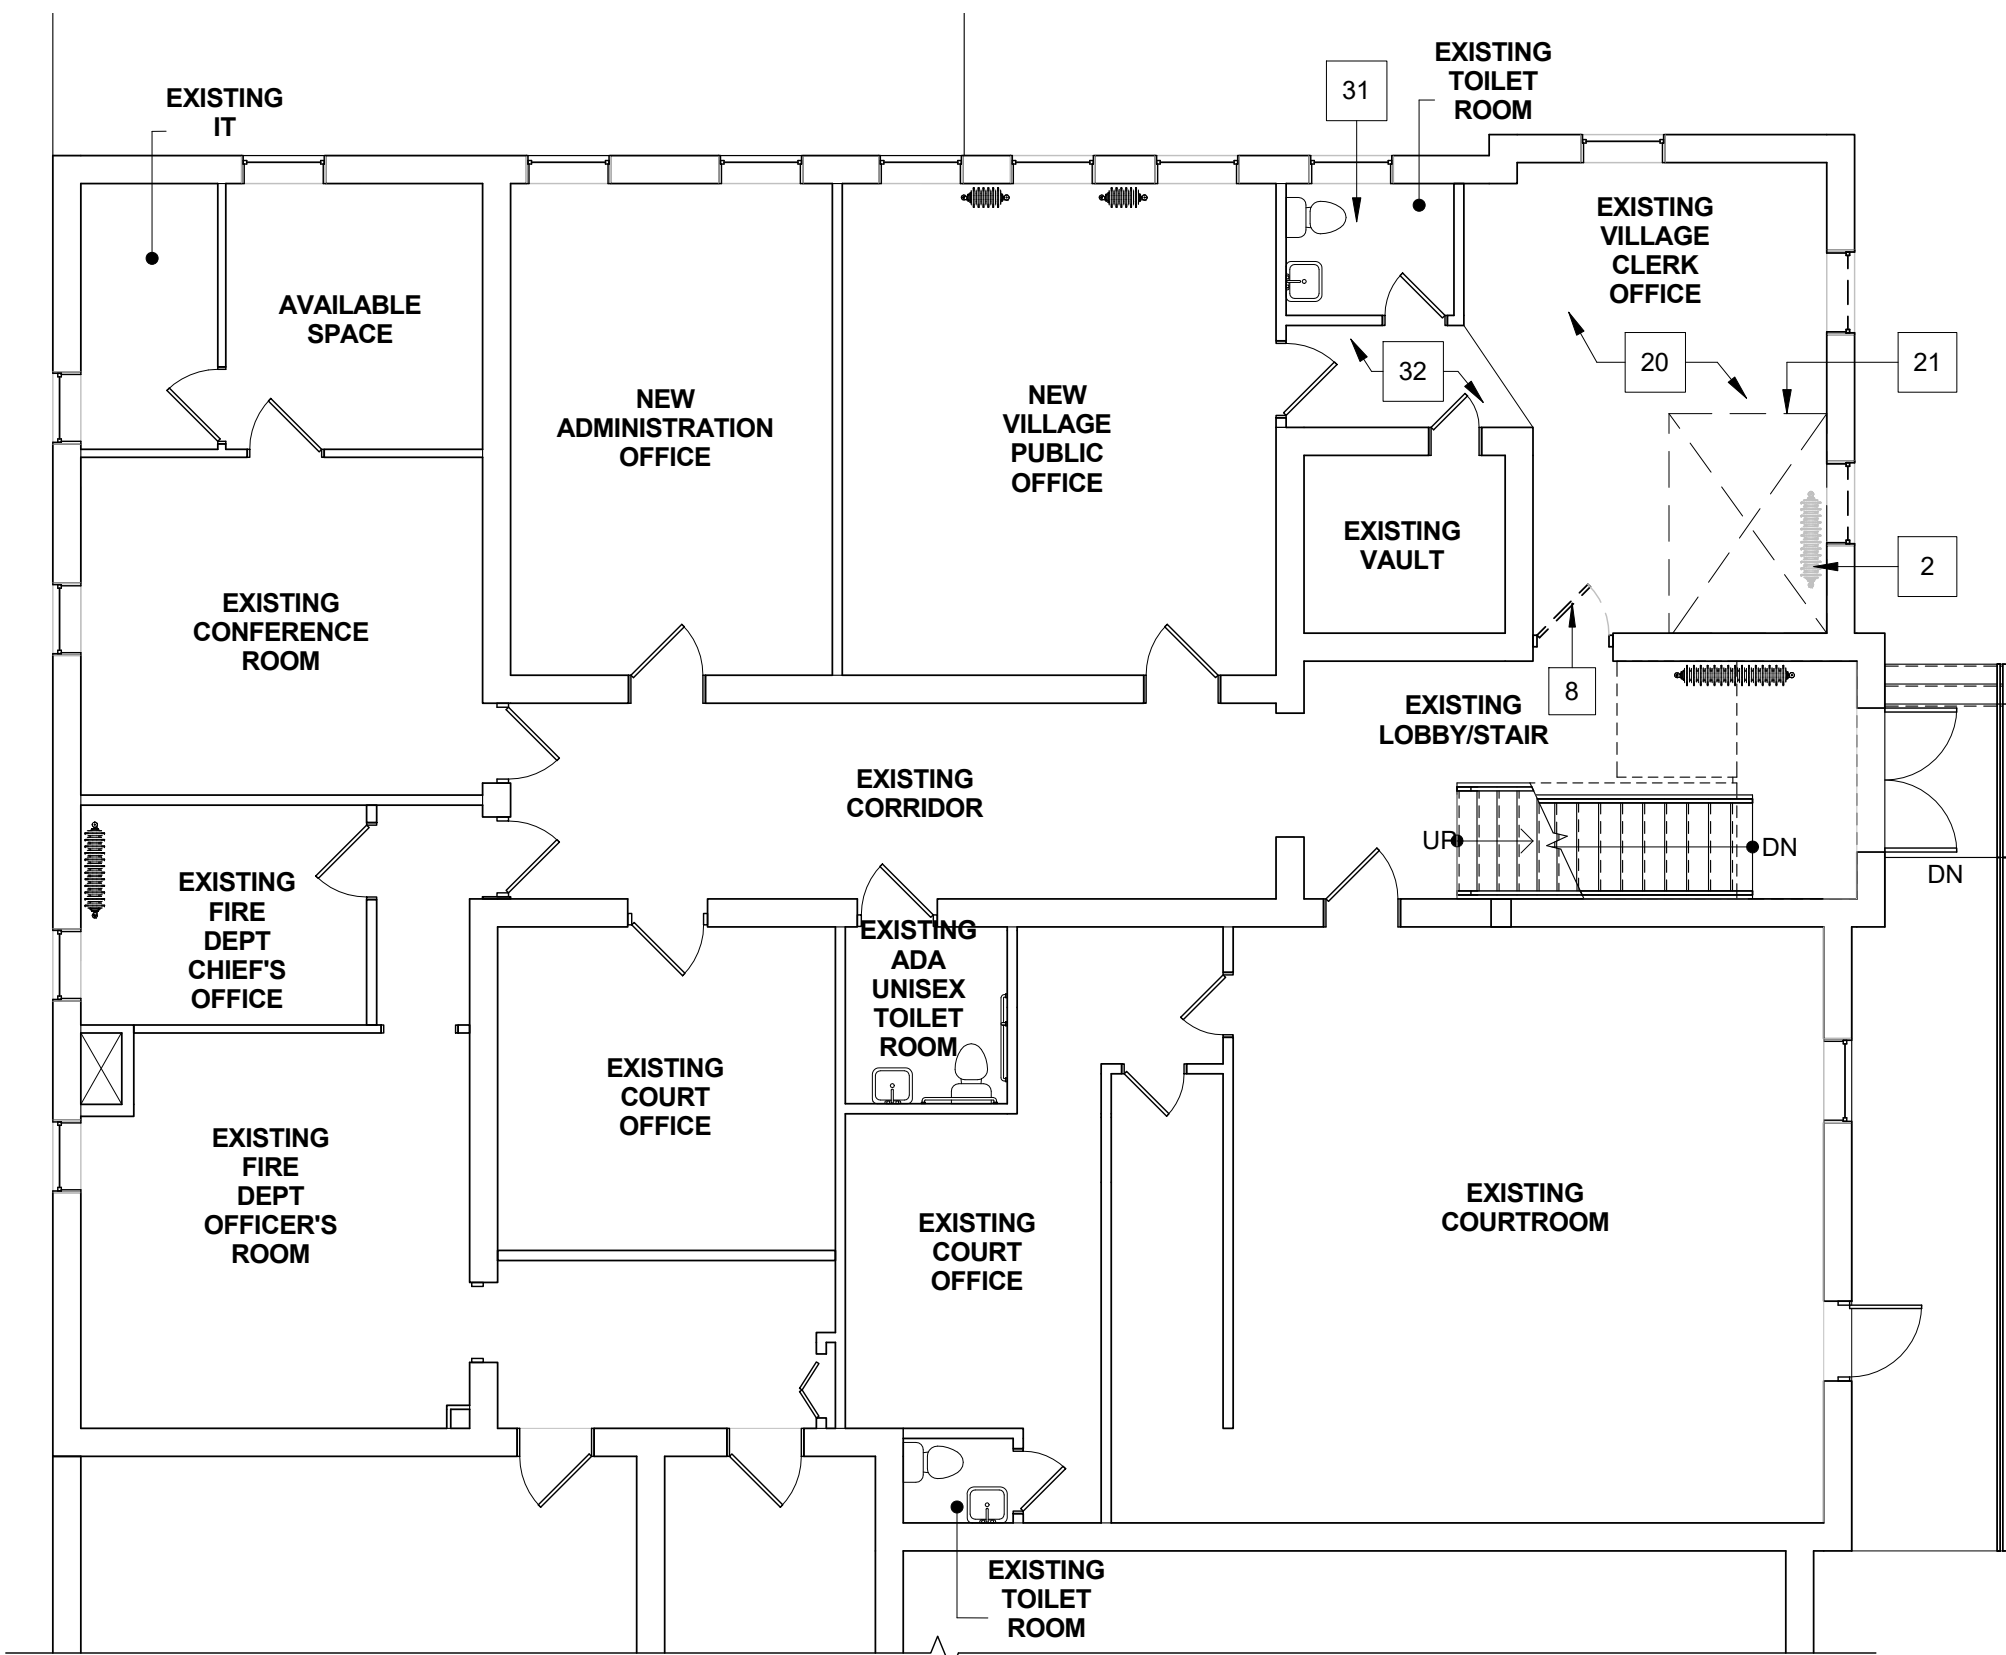
AD-01



1 SECOND FLOOR DEMOLITION PLAN  
1/8" = 1'-0"



3 PARTIAL SECOND FLOOR DEMOLITION PLAN - ALTERNATE #1  
1/8" = 1'-0"



2 FIRST FLOOR DEMOLITION PLAN  
1/8" = 1'-0"

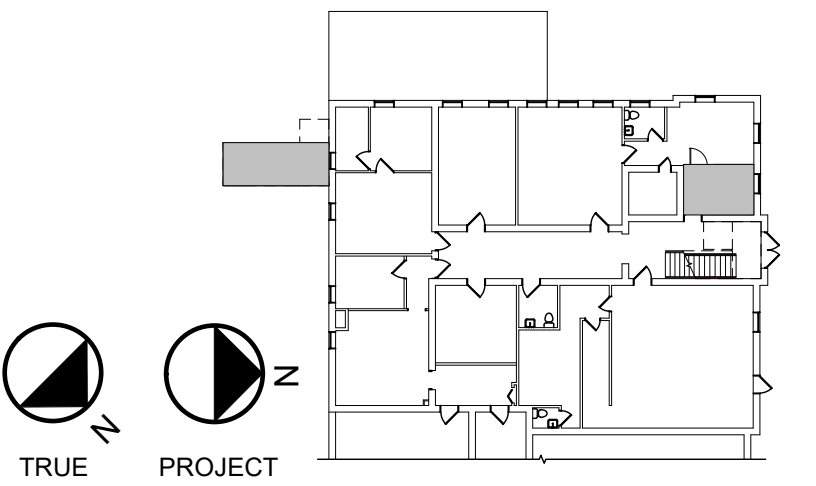
#### GENERAL DEMOLITION NOTES (FLOOR PLANS):

- DRAWINGS MAY NOT INDICATE ALL DEMOLITION / REMOVALS. CONTRACTOR IS TO REFER TO ALL DRAWINGS, SPECIFICATIONS AND FIELD CONDITIONS TO DETERMINE FULL SCOPE AND PARTICULARS OF REMOVAL REQUIREMENTS PRIOR TO CONSTRUCTION.
- ALL DIMENSIONS ARE +/- AND ARE TO BE VERIFIED IN FIELD BEFORE PROCEEDING WITH WORK.
- RESTORE ALL EXIST. CONDITIONS DAMAGED DURING REMOVAL WORK AND NOT SCHEDULED TO BE REMOVED, TO MATCH EXIST. CONDITIONS. ALL AREAS REQUIRING CUTTING AND PATCHING SHALL BE FINISHED TO MATCH ADJACENT SURFACES UNLESS NOTED OTHERWISE. PATCH ALL HOLES IN FLOORS AND WALLS WITH A FIRE STOP MATERIAL (SEE SPECS) WHERE CONDUIT, PIPING, DUCTWORK, ETC. HAS BEEN REMOVED. COORD. WITH ELEC AND PLUMB. DRAWINGS.
- UNLESS OTHERWISE NOTED, ALL REMOVALS IDENTIFIED IN THESE NOTES BECOME PROPERTY OF THE CONTRACTOR MAKING THE REMOVAL.
- COORDINATE ALL DEMOLITION WORK INDICATED ON THIS DRAWING WITH THAT OF THE OTHER TRADES. COORD. WITH ELEC AND PLUMB. DRAWINGS FOR ADDITIONAL DEMOLITION WORK.
- STABILIZATION OF THE EXISTING PORTIONS OF THIS BUILDING SCHEDULED TO REMAIN DURING AND AFTER THE DEMOLITION WORK WILL REQUIRE A PARTICULAR SEQUENCE OF WORK.
- REFER TO ASBESTOS CONTAINING MATERIALS REPORT IN PROJECT MANUAL FOR REMOVALS REQUIRED IN THIS PROJECT'S SCOPE OF WORK PRIOR TO START OF CONSTRUCTION.
- ALL WORK AREAS INVOLVING DEMOLITION, CUTTING, MODIFICATION, ETC. TO ANY EXISTING MATERIALS SHALL BE CONSIDERED A LEAD HAZARD AREA.
- DUE TO THE HISTORIC NATURE OF THIS EXISTING BUILDING, ALL WORK AREAS SHOULD BE PROPERLY PROTECTED AND THOROUGHLY CLEANED AT THE END OF CONSTRUCTION.

#### SPECIFIC FLOOR PLAN DEMOLITION NOTES:

- REMOVE EXISTING WALL, INCLUDING EXISTING DOOR AND WINDOW ASSEMBLIES IN THEIR ENTIRETY (SALVAGE AND RETURN TO OWNER); PROVIDE SUPPORT AT WALL REMOVAL AS REQUIRED.
- SALVAGE EXISTING RADIATOR FOR REINSTALLATION, SEE MEP DRAWINGS FOR MORE INFORMATION.
- REMOVE EXISTING STEAM PIPING AS REQUIRED FOR NEW ELEVATOR SHAFT WALLS, SEE MEP DRAWINGS FOR MORE INFORMATION.
- REMOVE EXISTING FLOOR TILE IN ITS ENTIRETY INCLUDING MASTIC TO CONCRETE FLOOR BELOW. FLOOR TILE IS KNOWN TO BE ASBESTOS-CONTAINING. SEE HAZMAT REPORT IN PROJECT MANUAL FOR MORE INFORMATION.
- REMOVE EXISTING FLOOR TILE IN ITS ENTIRETY.
- SAWCUT EXISTING CONCRETE SLAB AS REQUIRED FOR NEW FOUNDATIONS, SEE S-SERIES DRAWINGS FOR MORE INFORMATION.
- REMOVE EXISTING INFILL, WOOD SILL AND TRIM AT EXISTING OPENING IN WALL, PREP FOR INFILL.
- REMOVE EXISTING WOOD CHAIR RAIL AT WALLS IN THEIR ENTIRETY, SALVAGE AND RETURN TO OWNER.
- CAREFULLY REMOVE EXISTING WOOD DOOR & FRAME IN ITS ENTIRETY, SALVAGE FOR RE-INSTALLATION.
- SALVAGE EXISTING SURFACE MOUNTED LIGHT AT CEILING FOR REINSTALLATION, SEE E-SERIES DRAWINGS FOR MORE INFORMATION.
- REMOVE PORTION OF LOAD-BEARING WALL (ASSUMED) AS REQUIRED FOR NEW OPENING, SHORE AS REQUIRED, SEE S-SERIES DWGS.
- TEMPORARILY REMOVE DOOR FROM HINGES AND STORE AWAY FROM WORK AREA, REINSTALL AT CONCLUSION OF WORK. PROTECT DOOR FRAME DURING CONSTRUCTION.
- REMOVE EXISTING WINDOW IN ITS ENTIRETY, REMOVE PORTION OF EXISTING BRICK WALL BELOW WINDOW TO EXISTING SECOND FINISHED FLOOR ELEVATION, PREP FOR NEW DOOR, MODIFY EXISTING LINTEL AS REQUIRED FOR NEW DOOR OPENING.
- REMOVE PORTION OF LOAD-BEARING (ASSUMED) AS REQUIRED FOR NEW DOOR OPENING, SHORE AS REQUIRED, SEE S-SERIES DWGS.
- REMOVE EXISTING METAL DOOR & FRAME IN ITS ENTIRETY.
- REMOVE EXISTING PLUMBING FIXTURES IN THEIR ENTIRETY, CAP PLUMBING AS REQUIRED, SEE P-SERIES DWGS.
- REMOVE SURFACE MOUNTED LIGHT AT CEILING ABOVE, SALVAGE FOR REINSTALLATION, SEE E-SERIES DWGS FOR MORE INFORMATION.
- REMOVE EXISTING WINDOWS IN THEIR ENTIRETY, PREP FOR NEW WINDOW.
- REMOVE PORTION OF EXISTING WOOD FLOOR STRUCTURE AS REQUIRED FOR NEW ELEVATOR, SHORE AS REQUIRED, SEE S-SERIES DWGS FOR DETAILS FOR RE-SUPPORTING FLOOR SURROUNDING OPENING.
- EXISTING WOOD FLOOR TO BE PROTECTED DURING CONSTRUCTION.
- REMOVE EXISTING CARPET IN ITS ENTIRETY. NOTIFY ARCHITECT OF CONDITION OF EXISTING TILE INCLUDING AREAS OF DAMAGED OR MISSING TILE. IF ARCHITECT DECIDES THAT THE TILE IS ARE IN ACCEPTABLE CONDN. CONTRACTOR TO CAREFULLY CLEAN ADHESIVE FROM THE EXISTING TILE. USE A MIXTURE OF WARM WATER, AMMONIA, AND A TEASPOON OF MILD DISH DETERGENT PER BUCKET OF WATER. SCRUB USING A NYLON OR NATURAL BRISTLE BRUSH. IF THIS MIXTURE IS INSUFFICIENT TO FULLY REMOVE ADHESIVE, COORDINATE WITH ARCHITECT. DO NOT USE A MORE ABRASIVE METHOD WITHOUT ARCHITECT'S APPROVAL. WHERE TILE IS MISSING OR DAMAGED, REPLACE WITH SALVAGED OR NEW MOSAIC TILE TO MATCH (INCLUDING GROUT COLOR). REPLACEMENT TILE CAN BE SOURCED FROM MULTIPLE MANUFACTURERS INCLUDING: AMERICAN RESTORATION TILE, MABELVALE, AR, PH: (601) 455-1000.
- REMOVE PORTION OF EXISTING CONCRETE FLOOR STRUCTURE AS REQUIRED FOR NEW ELEVATOR, SHORE AS REQUIRED, SEE S-SERIES DWGS FOR DETAILS FOR RE-SUPPORTING FLOOR SURROUNDING OPENING.
- REMOVE EXISTING NON-LOAD BEARING WALL AS SHOWN. PATCH AND REPAIR EXISTING WALL AND ADJACENT FINISHES TO REMAIN (MATCH EXISTING).
- CAREFULLY REMOVE WOOD DOOR & FRAME IN ITS ENTIRETY, SALVAGE AND RETURN TO OWNER.
- REMOVE EXISTING EXTENSION AT BASE OF DOWNSPOUT.
- EXISTING ELECTRIC METER TO REMAIN.
- REMOVE EXISTING WINDOW & CONCRETE WINDOW WELL AT BASEMENT LEVEL (GROUND FLOOR LEVEL WINDOW TO REMAIN).
- REMOVE EXISTING CONCRETE CURB AND ROCK BED, SALVAGE ROCKS FOR REINSTALLATION.
- REMOVE PORTION OF EXISTING ASPHALT PARKING AREA AS REQUIRED FOR NEW EXTERIOR STAIR.
- EXISTING GAS METER TO REMAIN.
- EXISTING ROOF TO BASEMENT ENTRY BELOW.
- EXISTING TILE FLOOR TO REMAIN.
- EXISTING CARPET TO REMAIN.

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## PERRY VILLAGE HALL ADA IMPROVEMENTS

VILLAGE OF PERRY  
46 N. MAIN ST.  
PERRY, NY 14530

**100% CONSTRUCTION  
DOCUMENT BID SET**

#### NOTES & REVISIONS:

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DRAWING ISSUED: APRIL 5, 2021

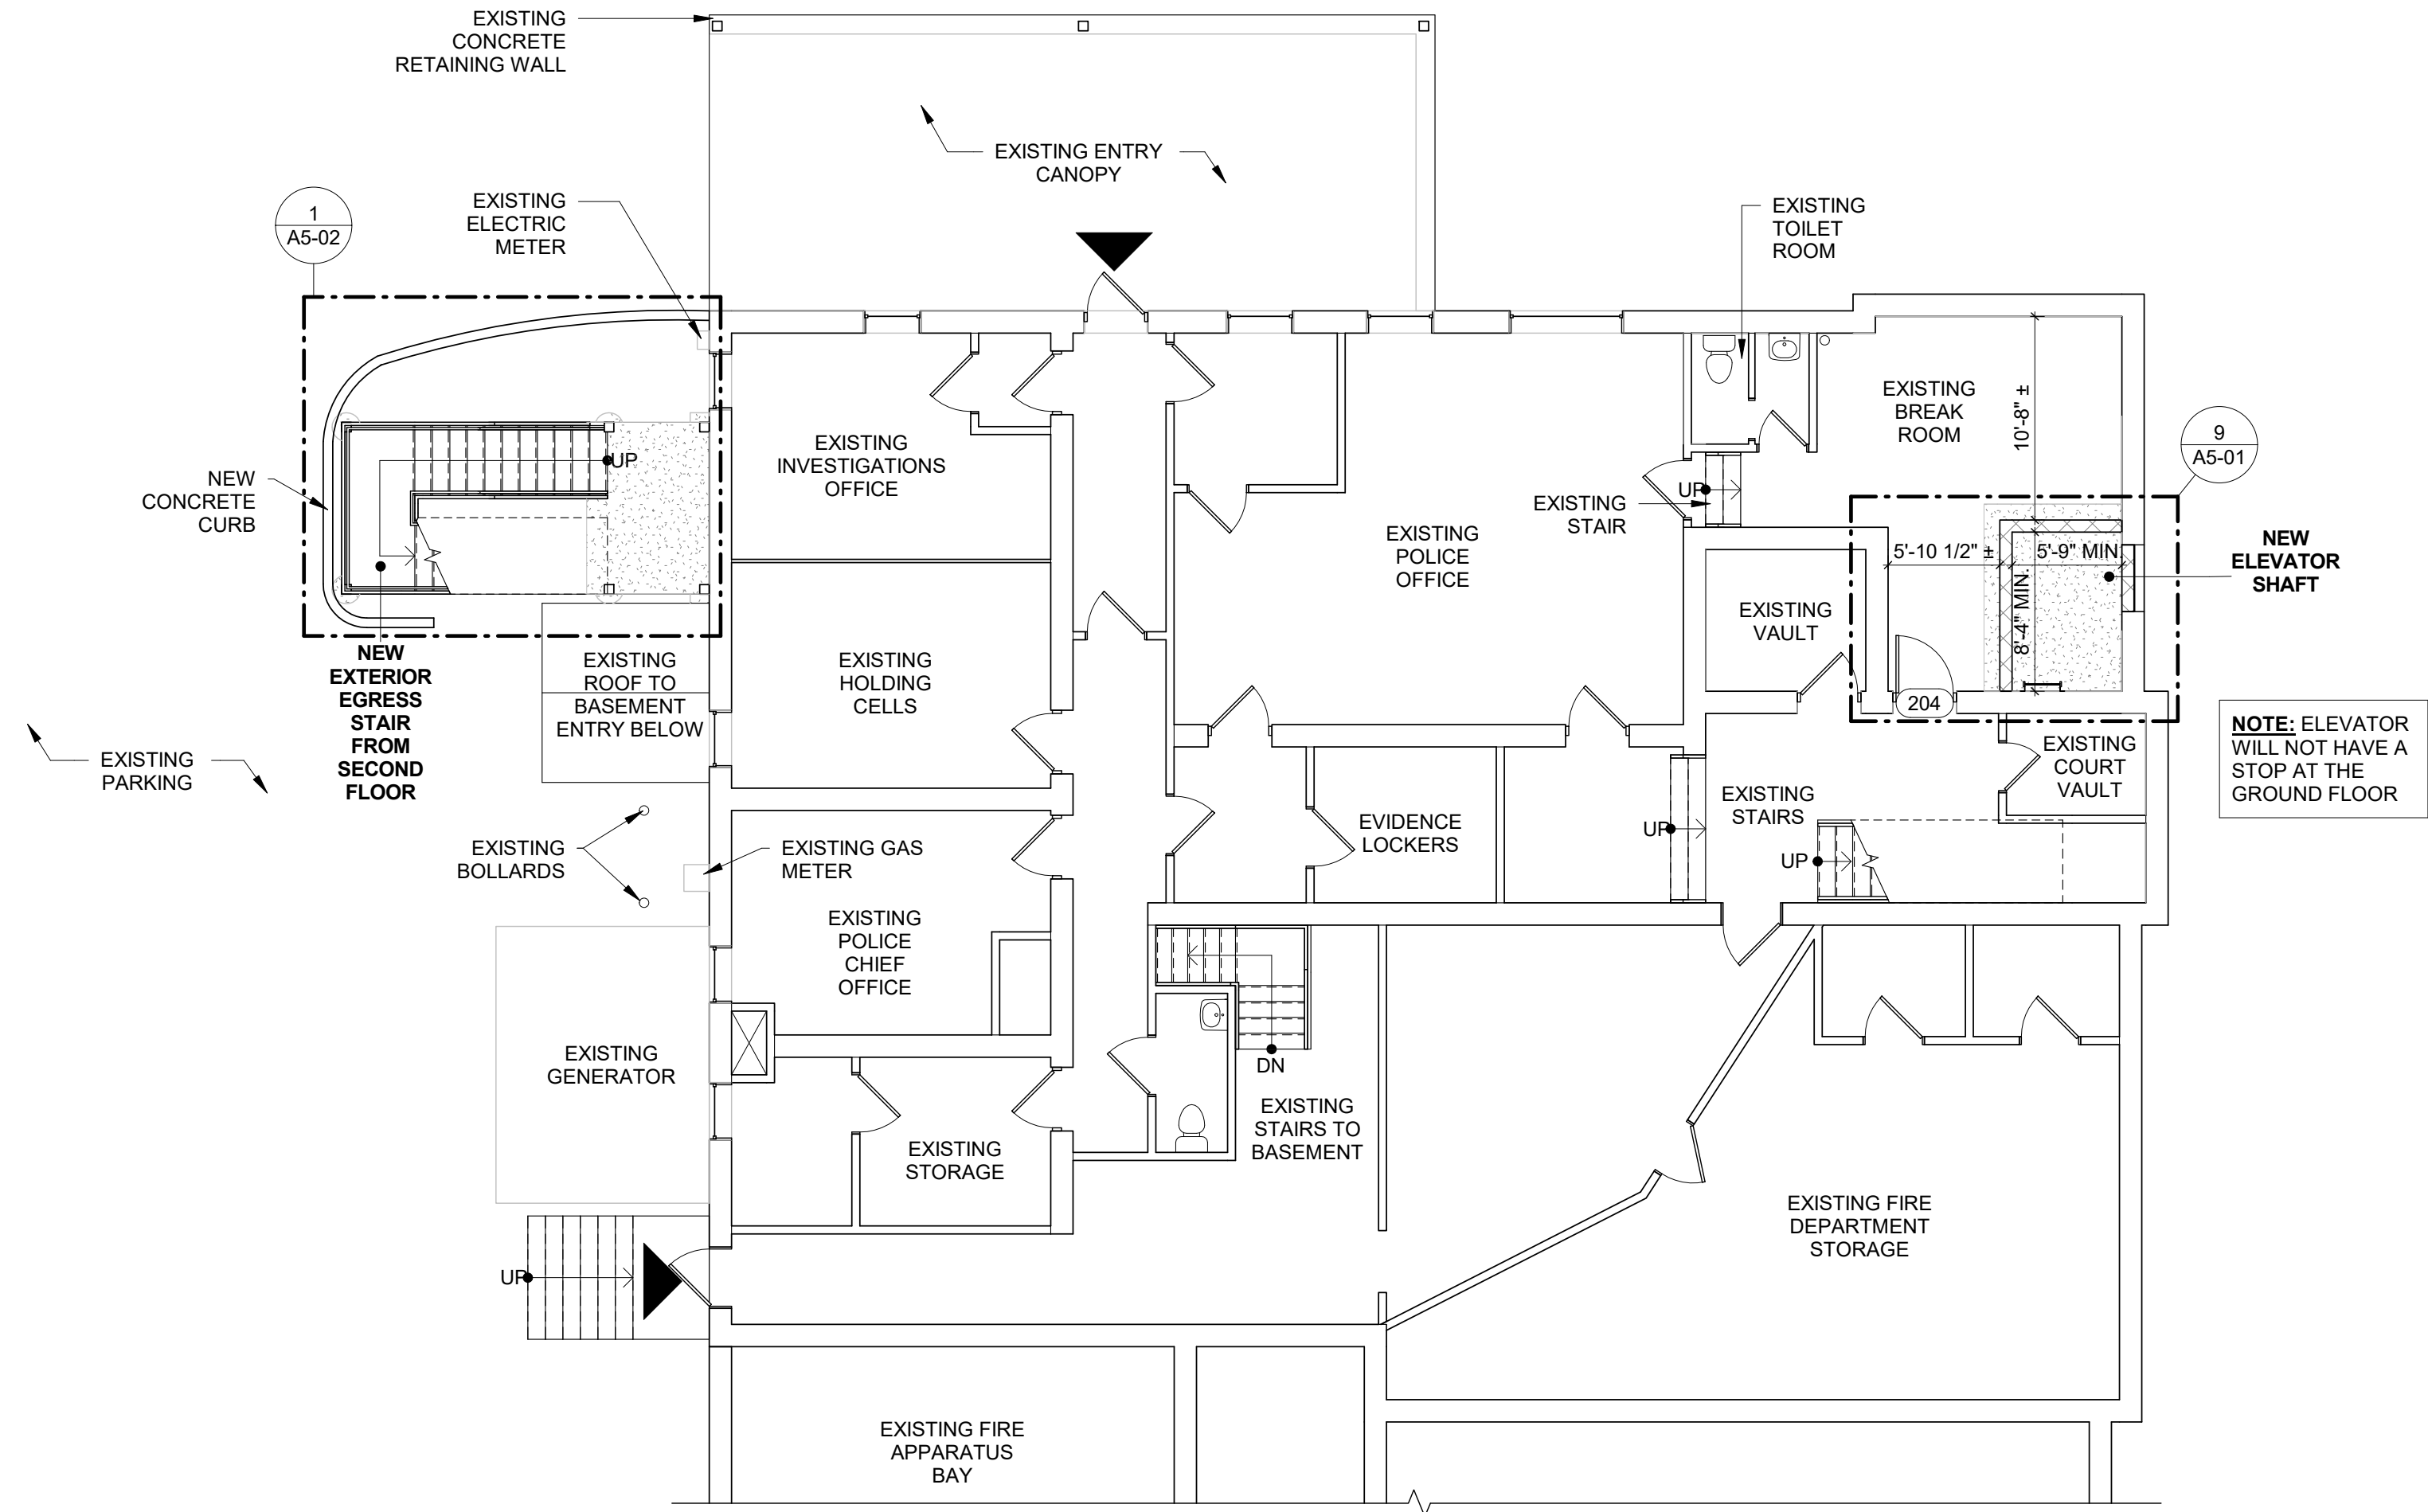
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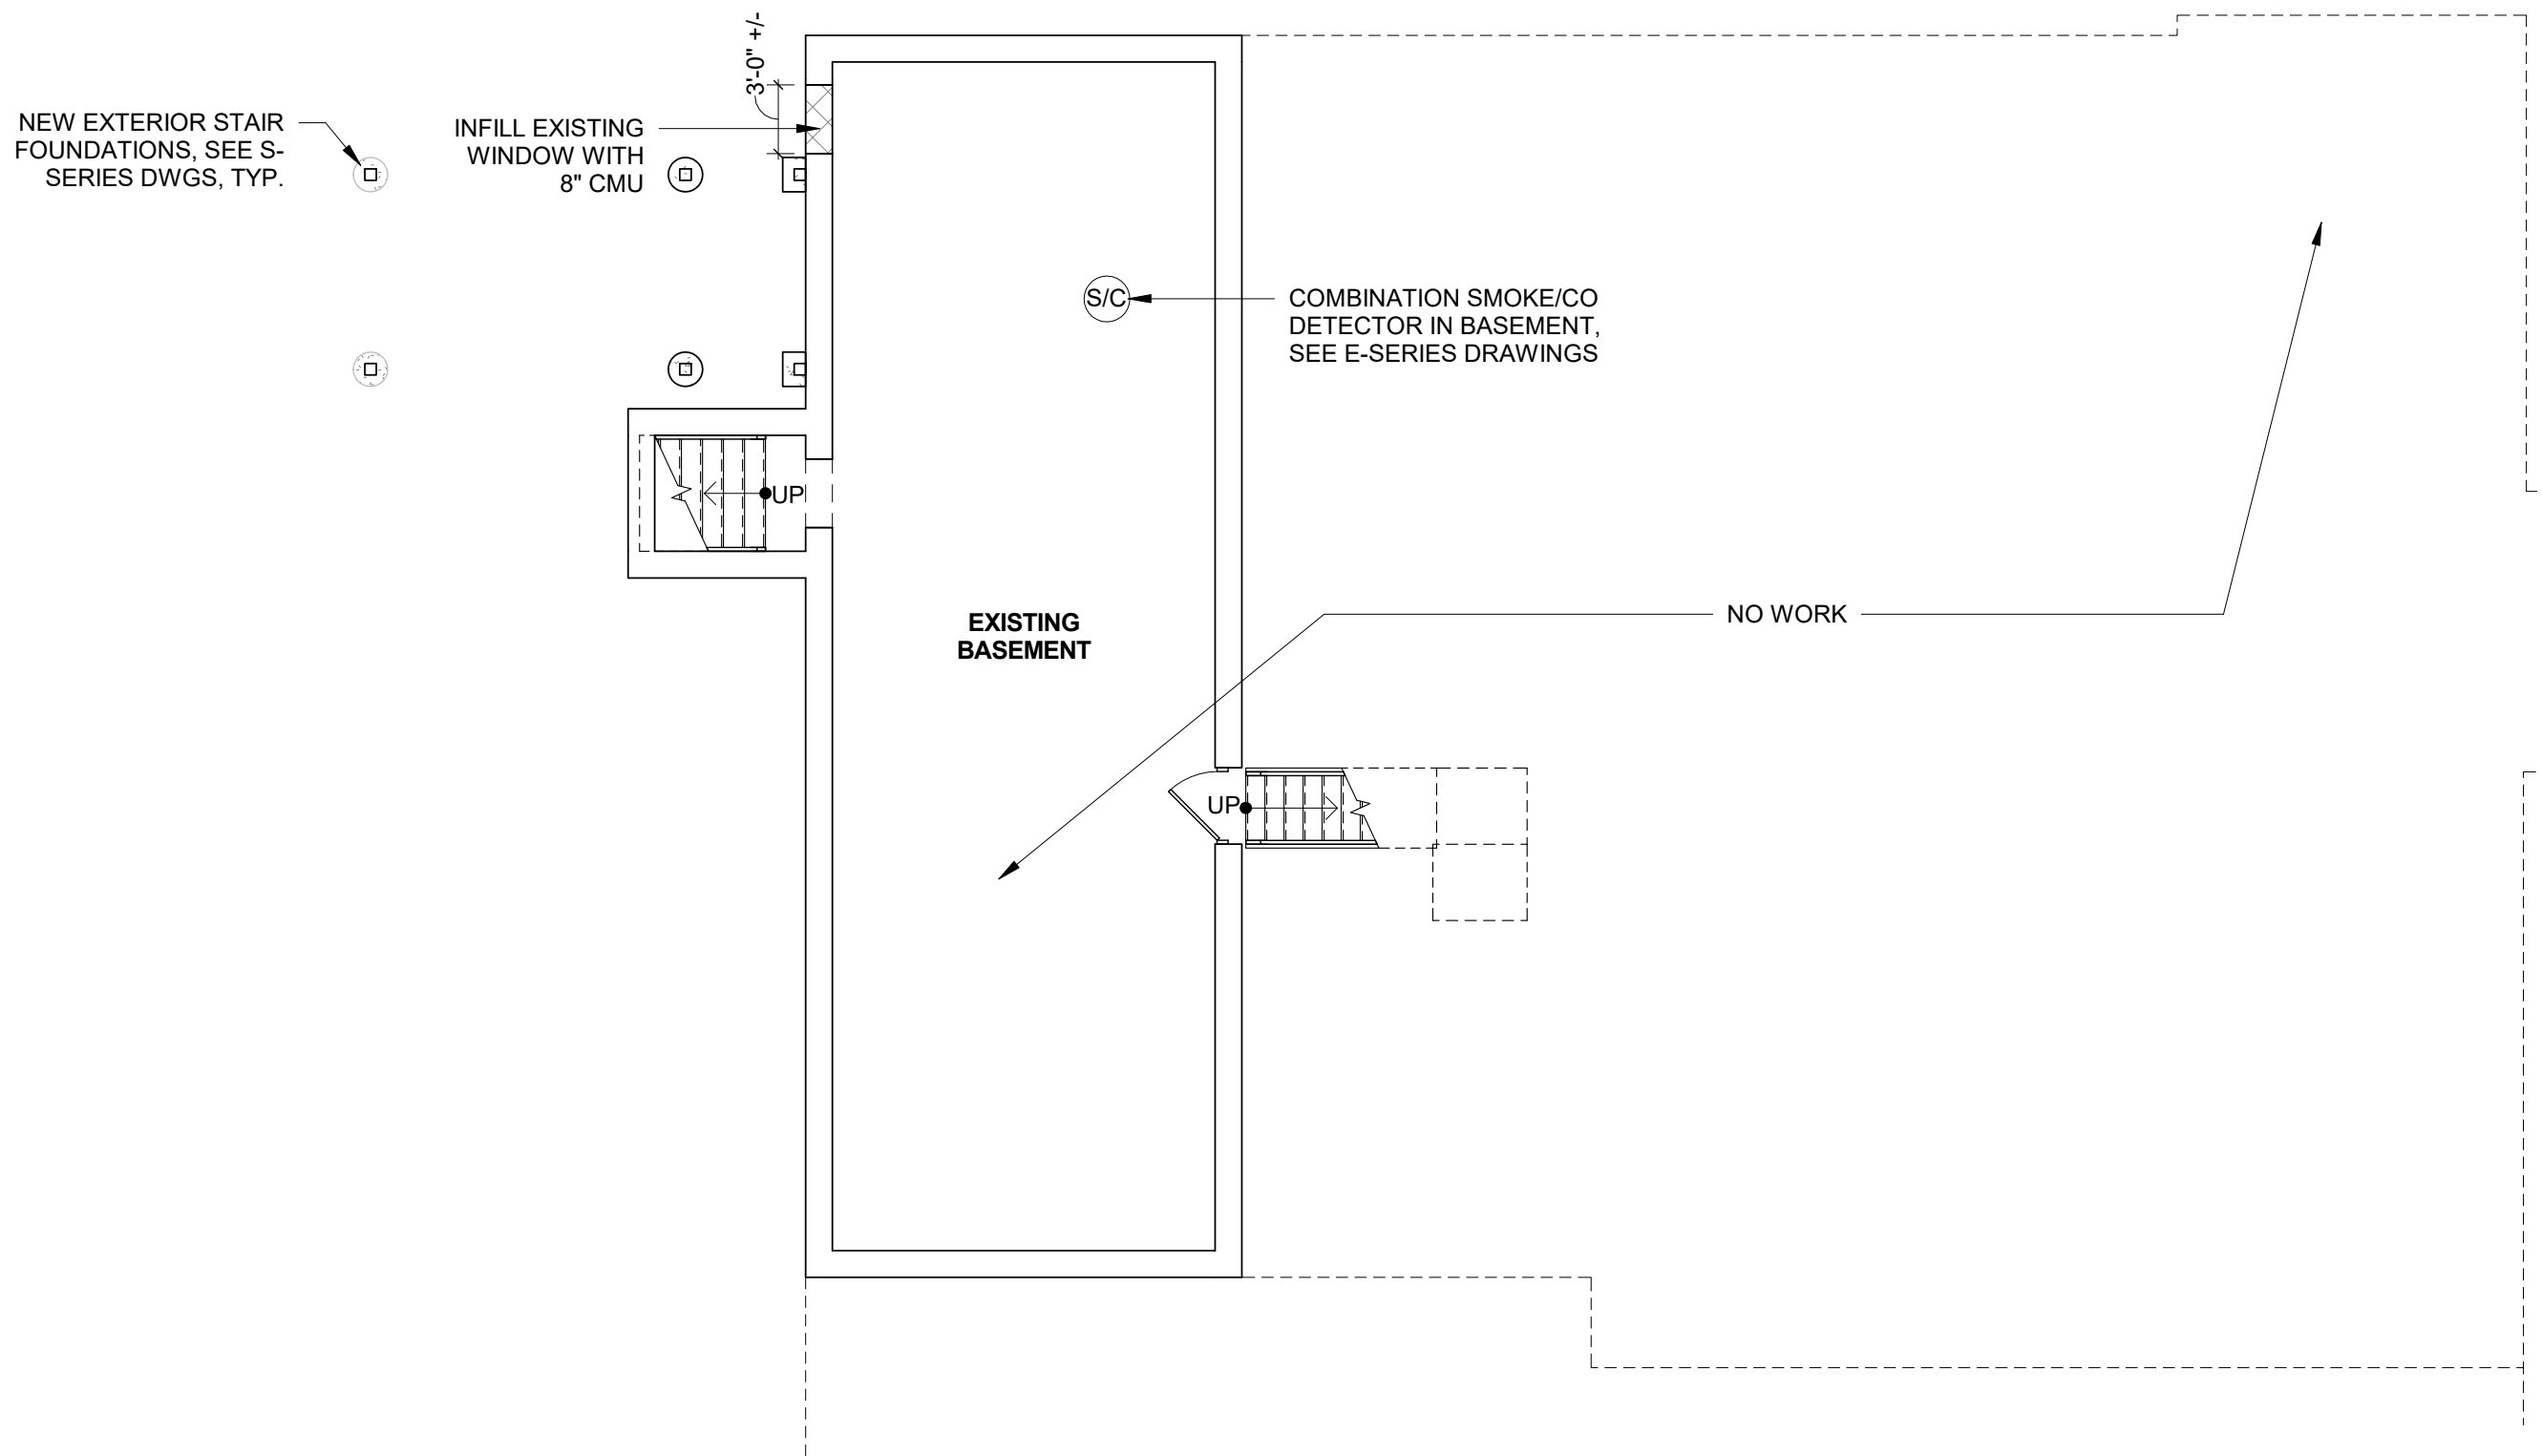
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**DEMOLITION PLANS**

Drawing Number

**AD-02**



1 GROUND FLOOR PLAN  
1/8" = 1'-0"



2 BASEMENT FLOOR PLAN  
1/8" = 1'-0"

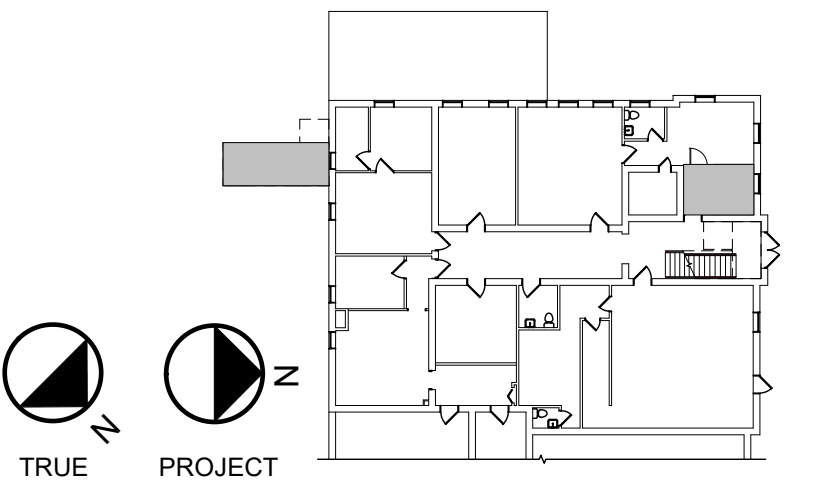
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#### ALTERNATE NOTES:

**ALTERNATE #1:** THE NEW ELEVATOR LOBBY IS TO BE REDUCED IN SIZE. SEE SHEET A5-01 FOR DETAILS.

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## PERRY VILLAGE HALL ADA IMPROVEMENTS

VILLAGE OF PERRY  
46 N. MAIN ST.  
PERRY, NY 14530

**100% CONSTRUCTION  
DOCUMENT BID SET**

#### NOTES & REVISIONS:

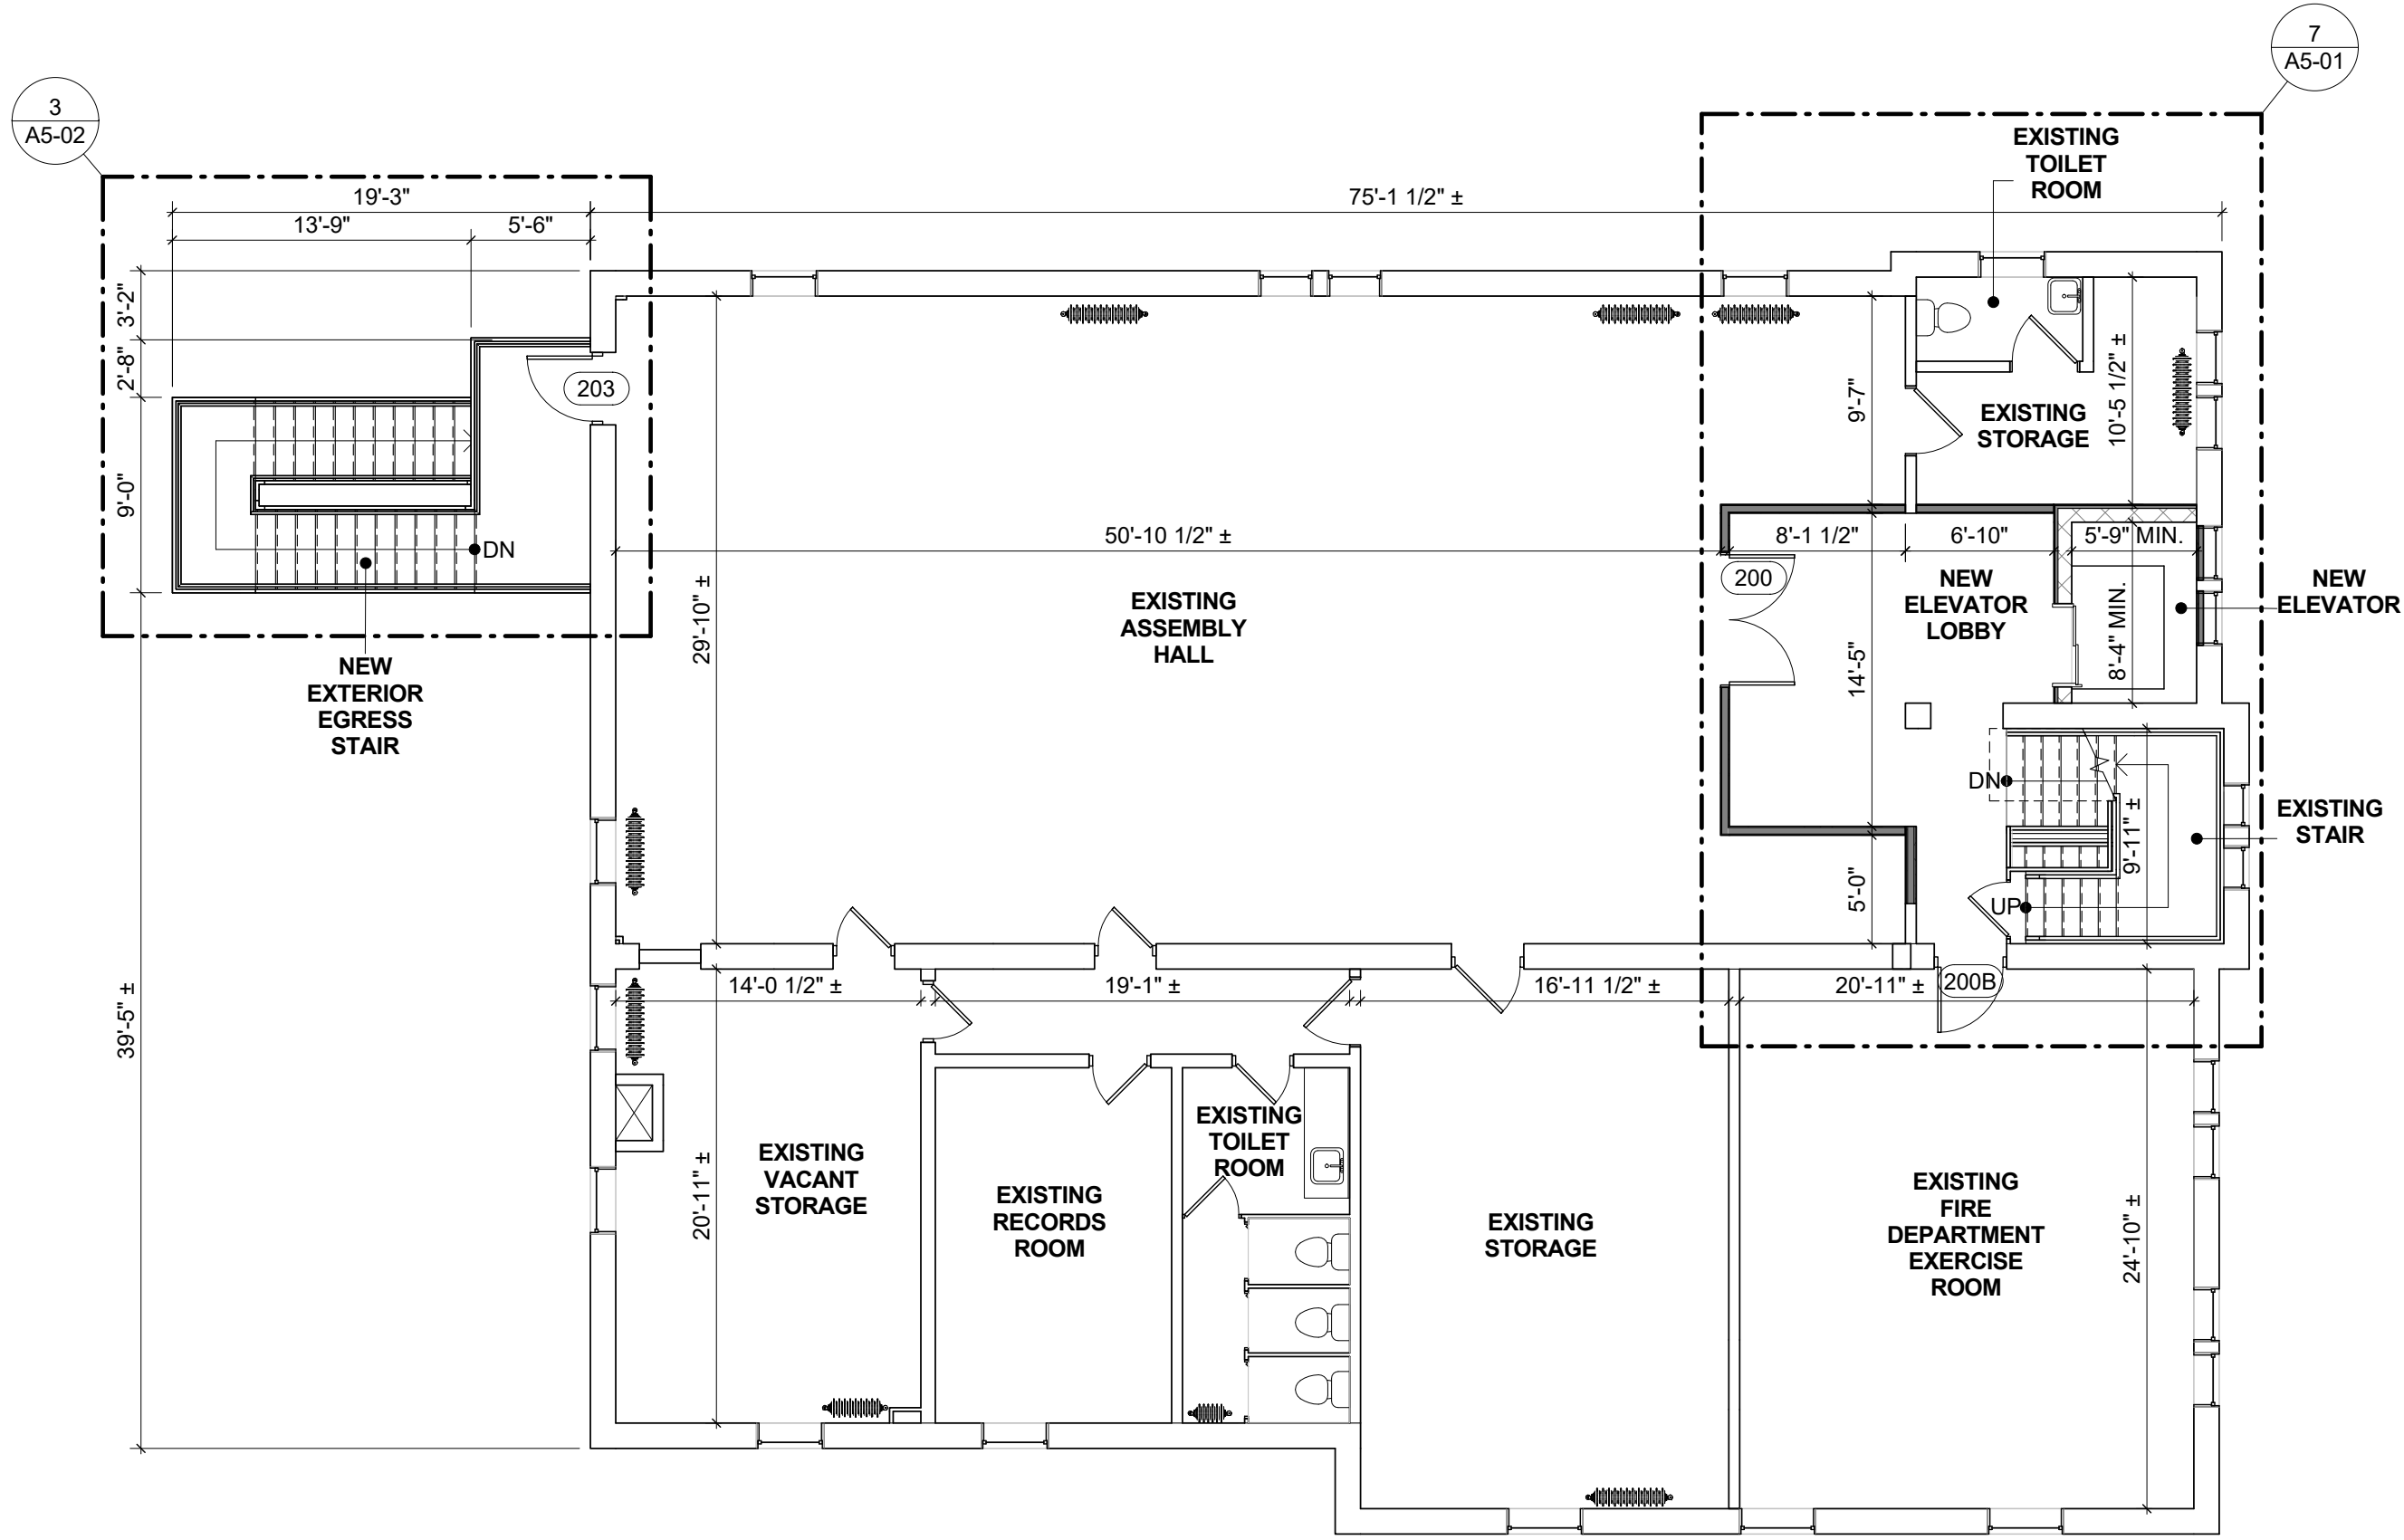
Revision Schedule		
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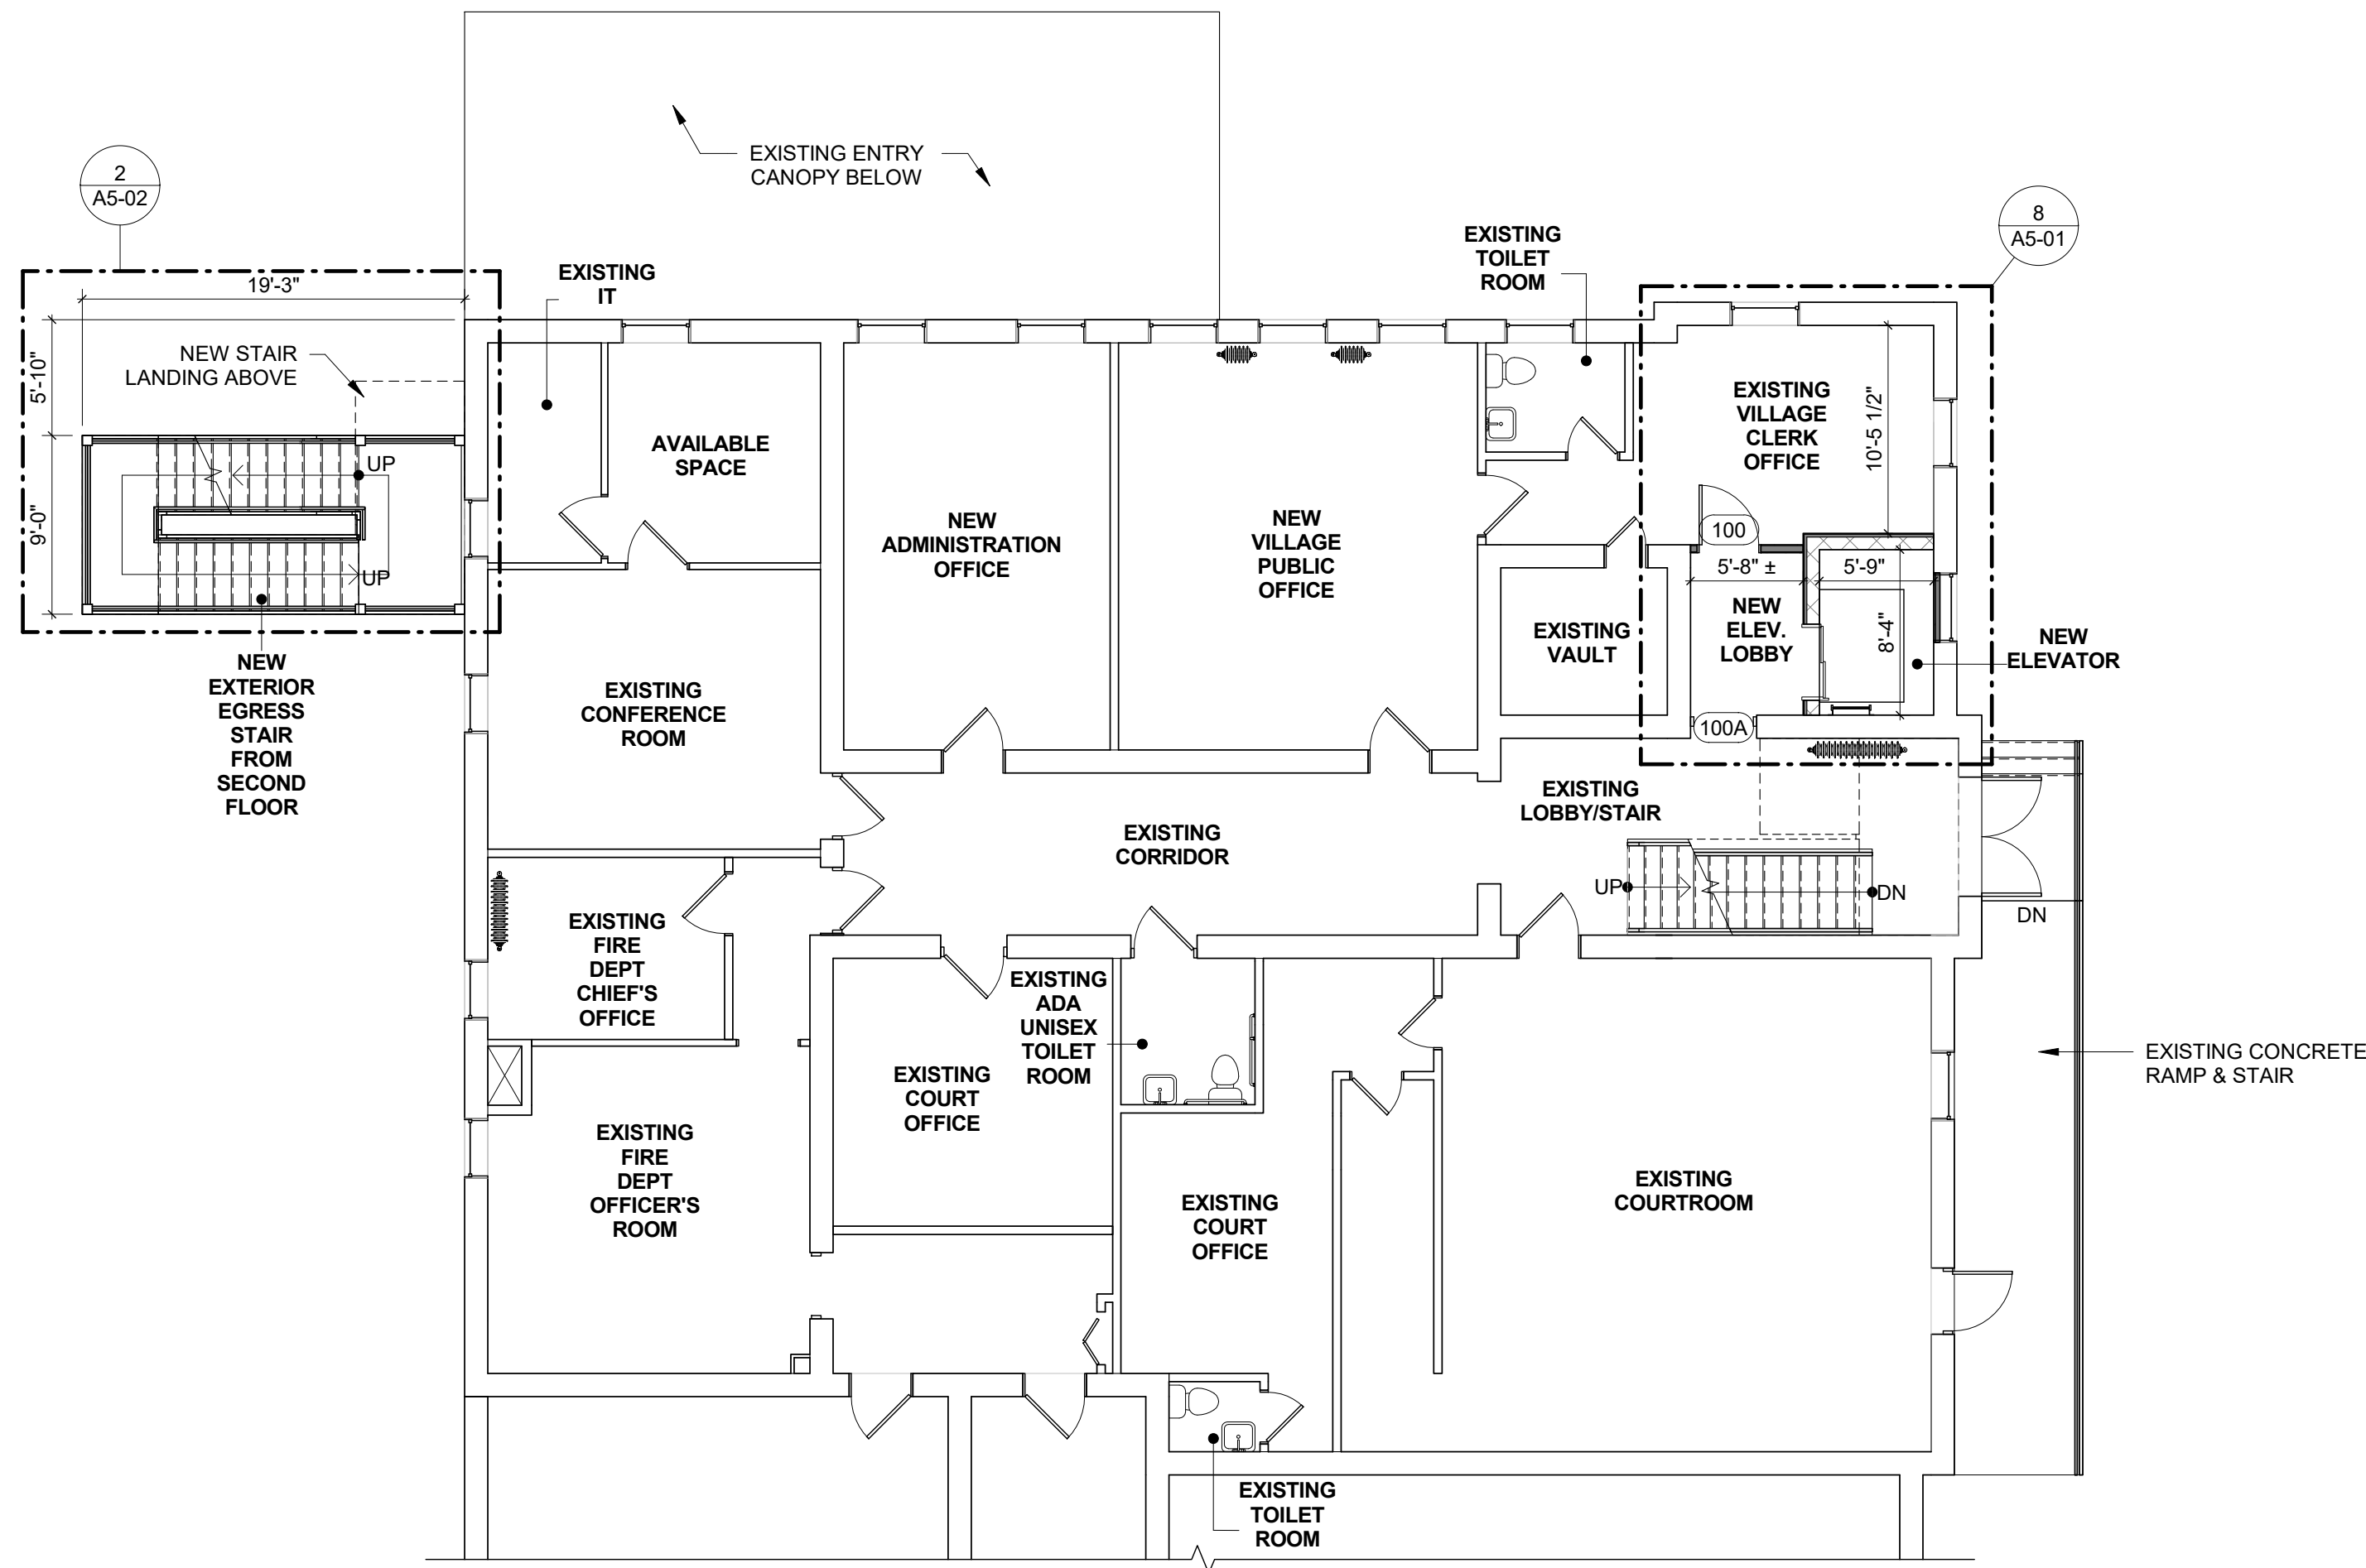
Drawing Title  
**BASEMENT AND GROUND FLOOR PLANS**

Drawing Number

**A1-01**



1 SECOND FLOOR PLAN  
1/8" = 1'-0"



2 FIRST FLOOR PLAN  
1/8" = 1'-0"

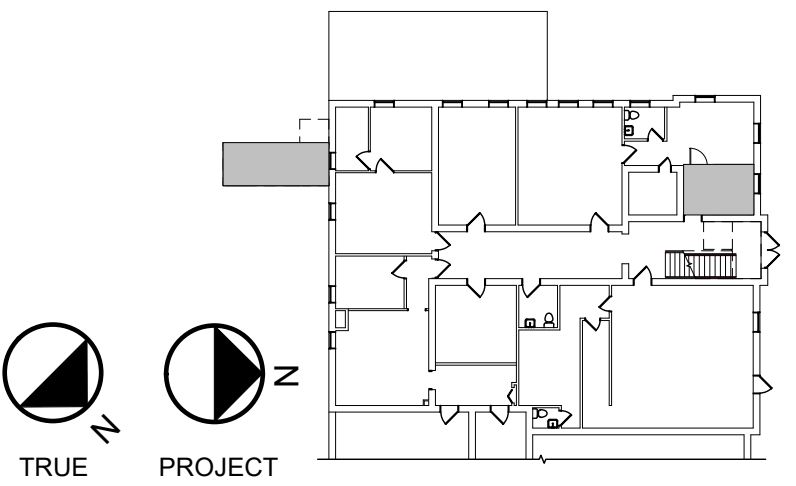
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**ALTERNATE #1:** THE NEW ELEVATOR LOBBY IS TO BE REDUCED IN SIZE, SEE SHEET A5-01 FOR DETAILS.

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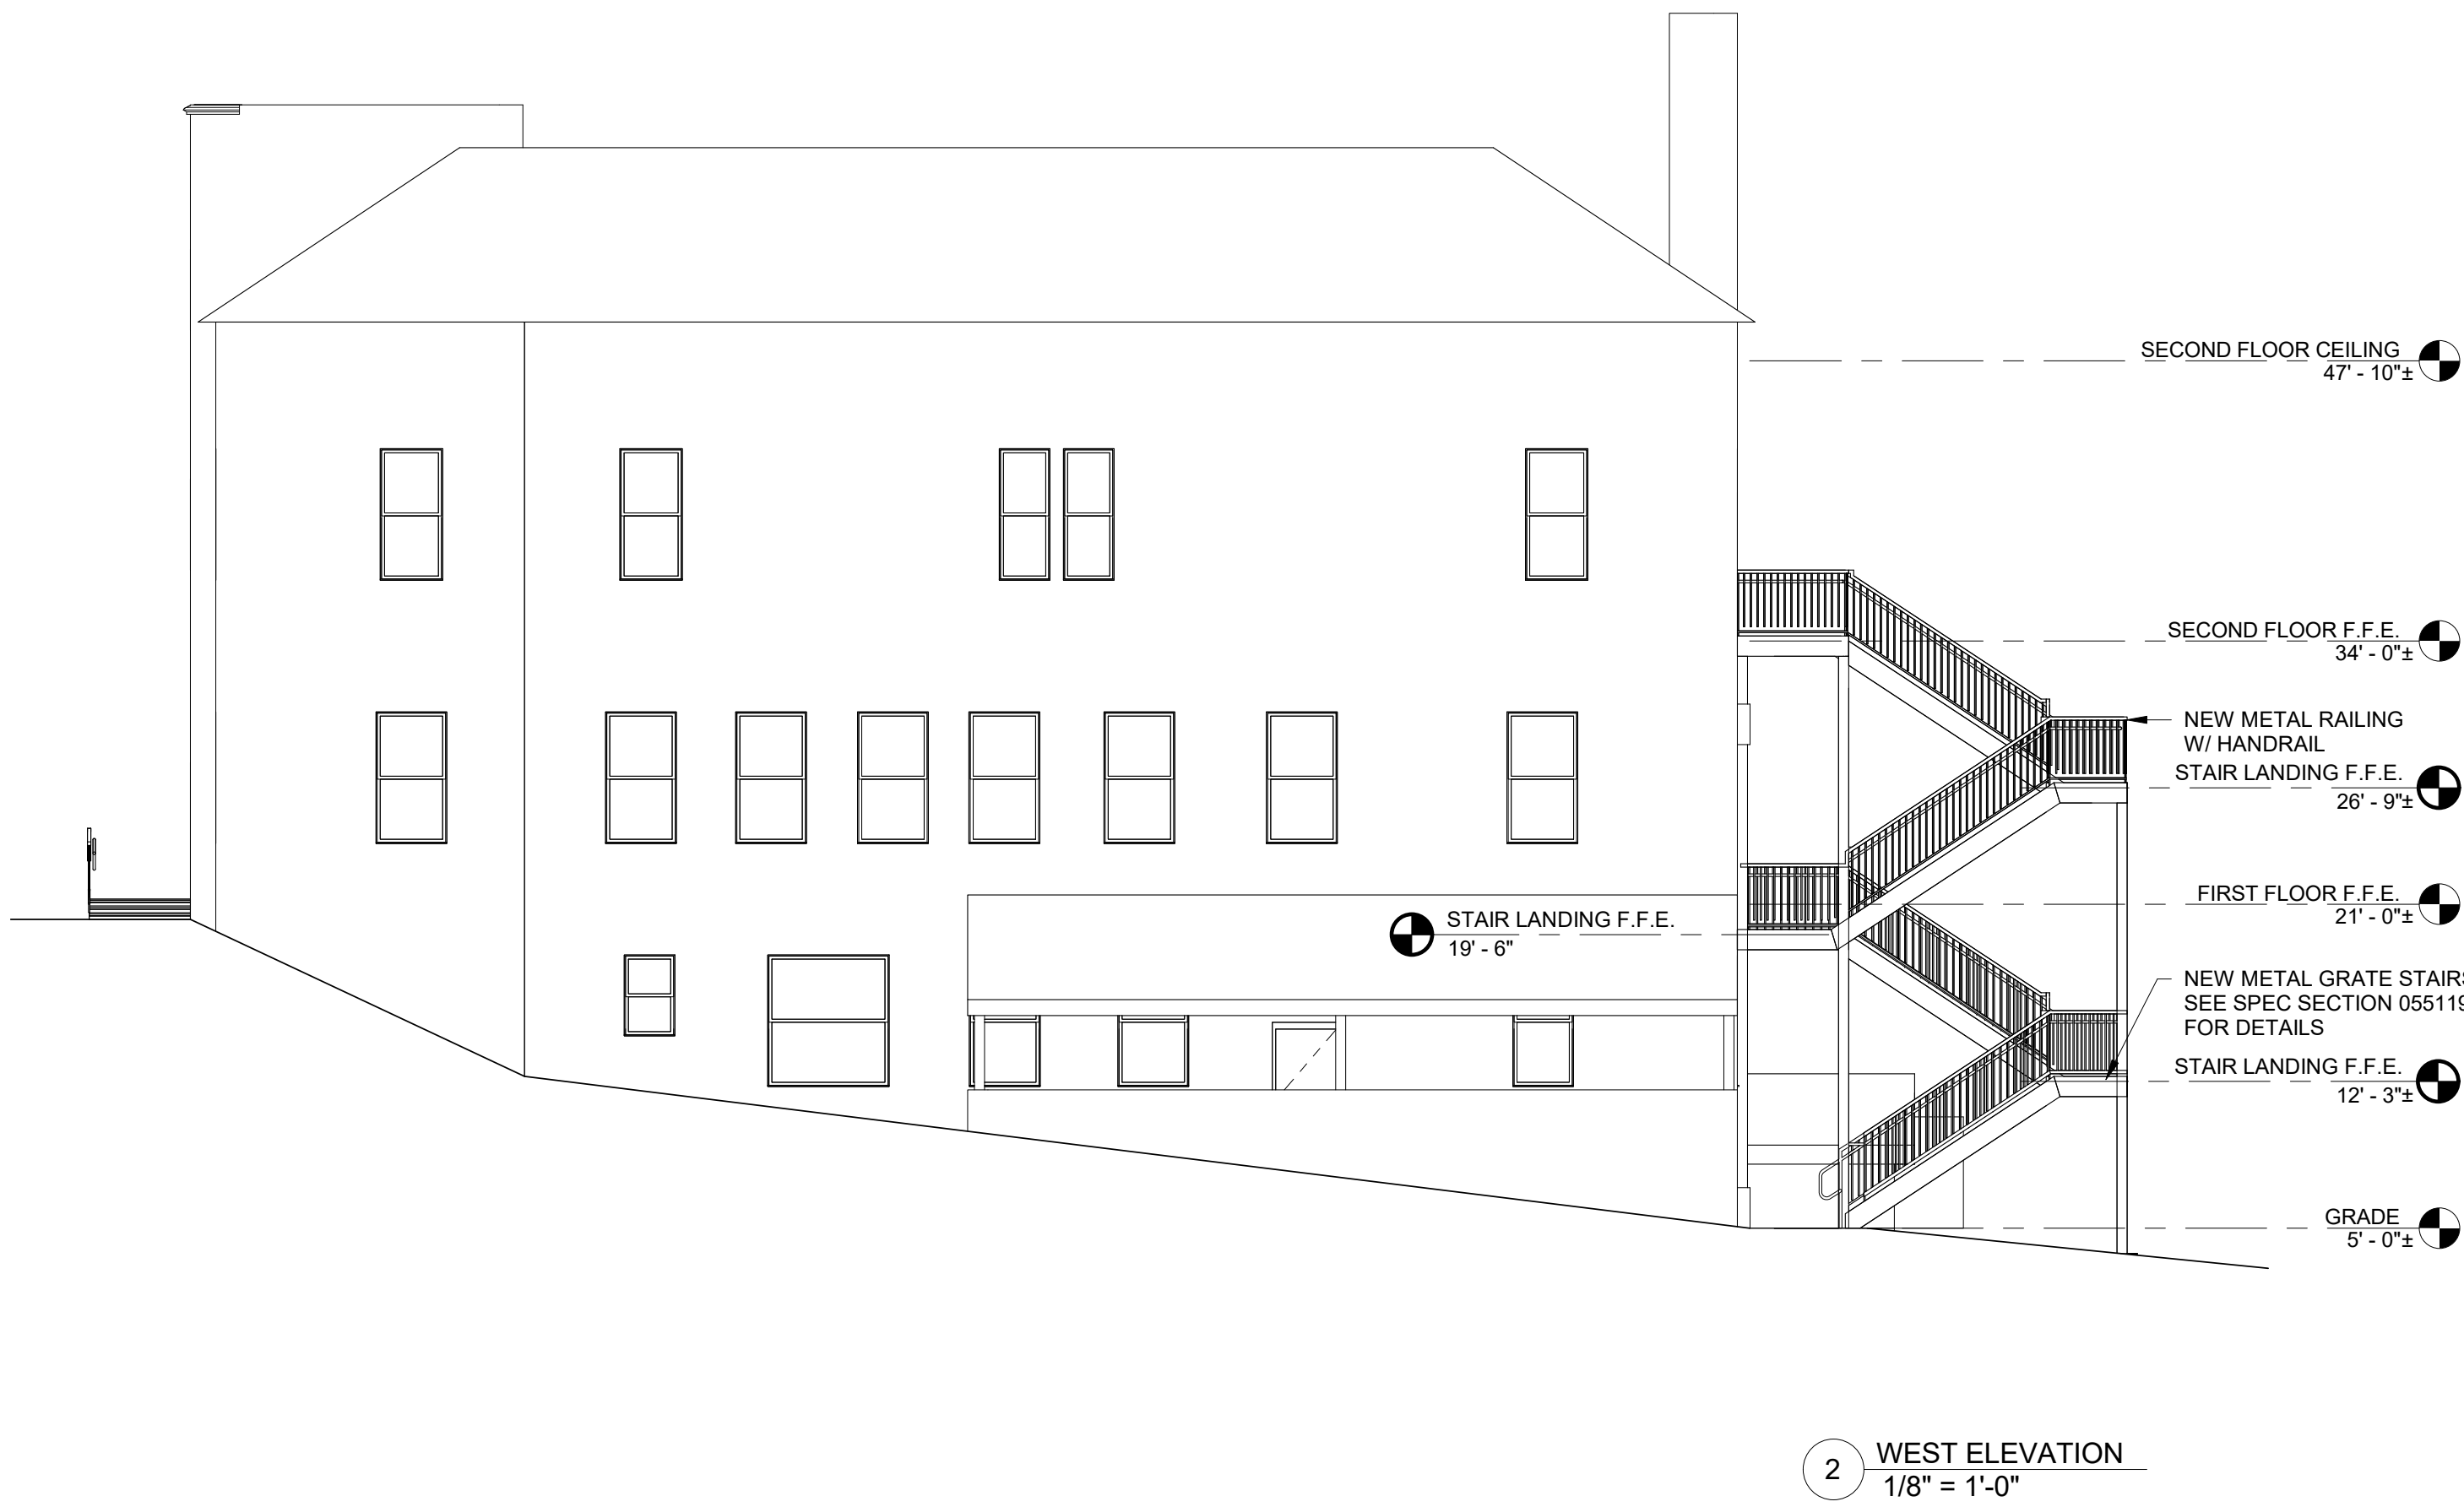
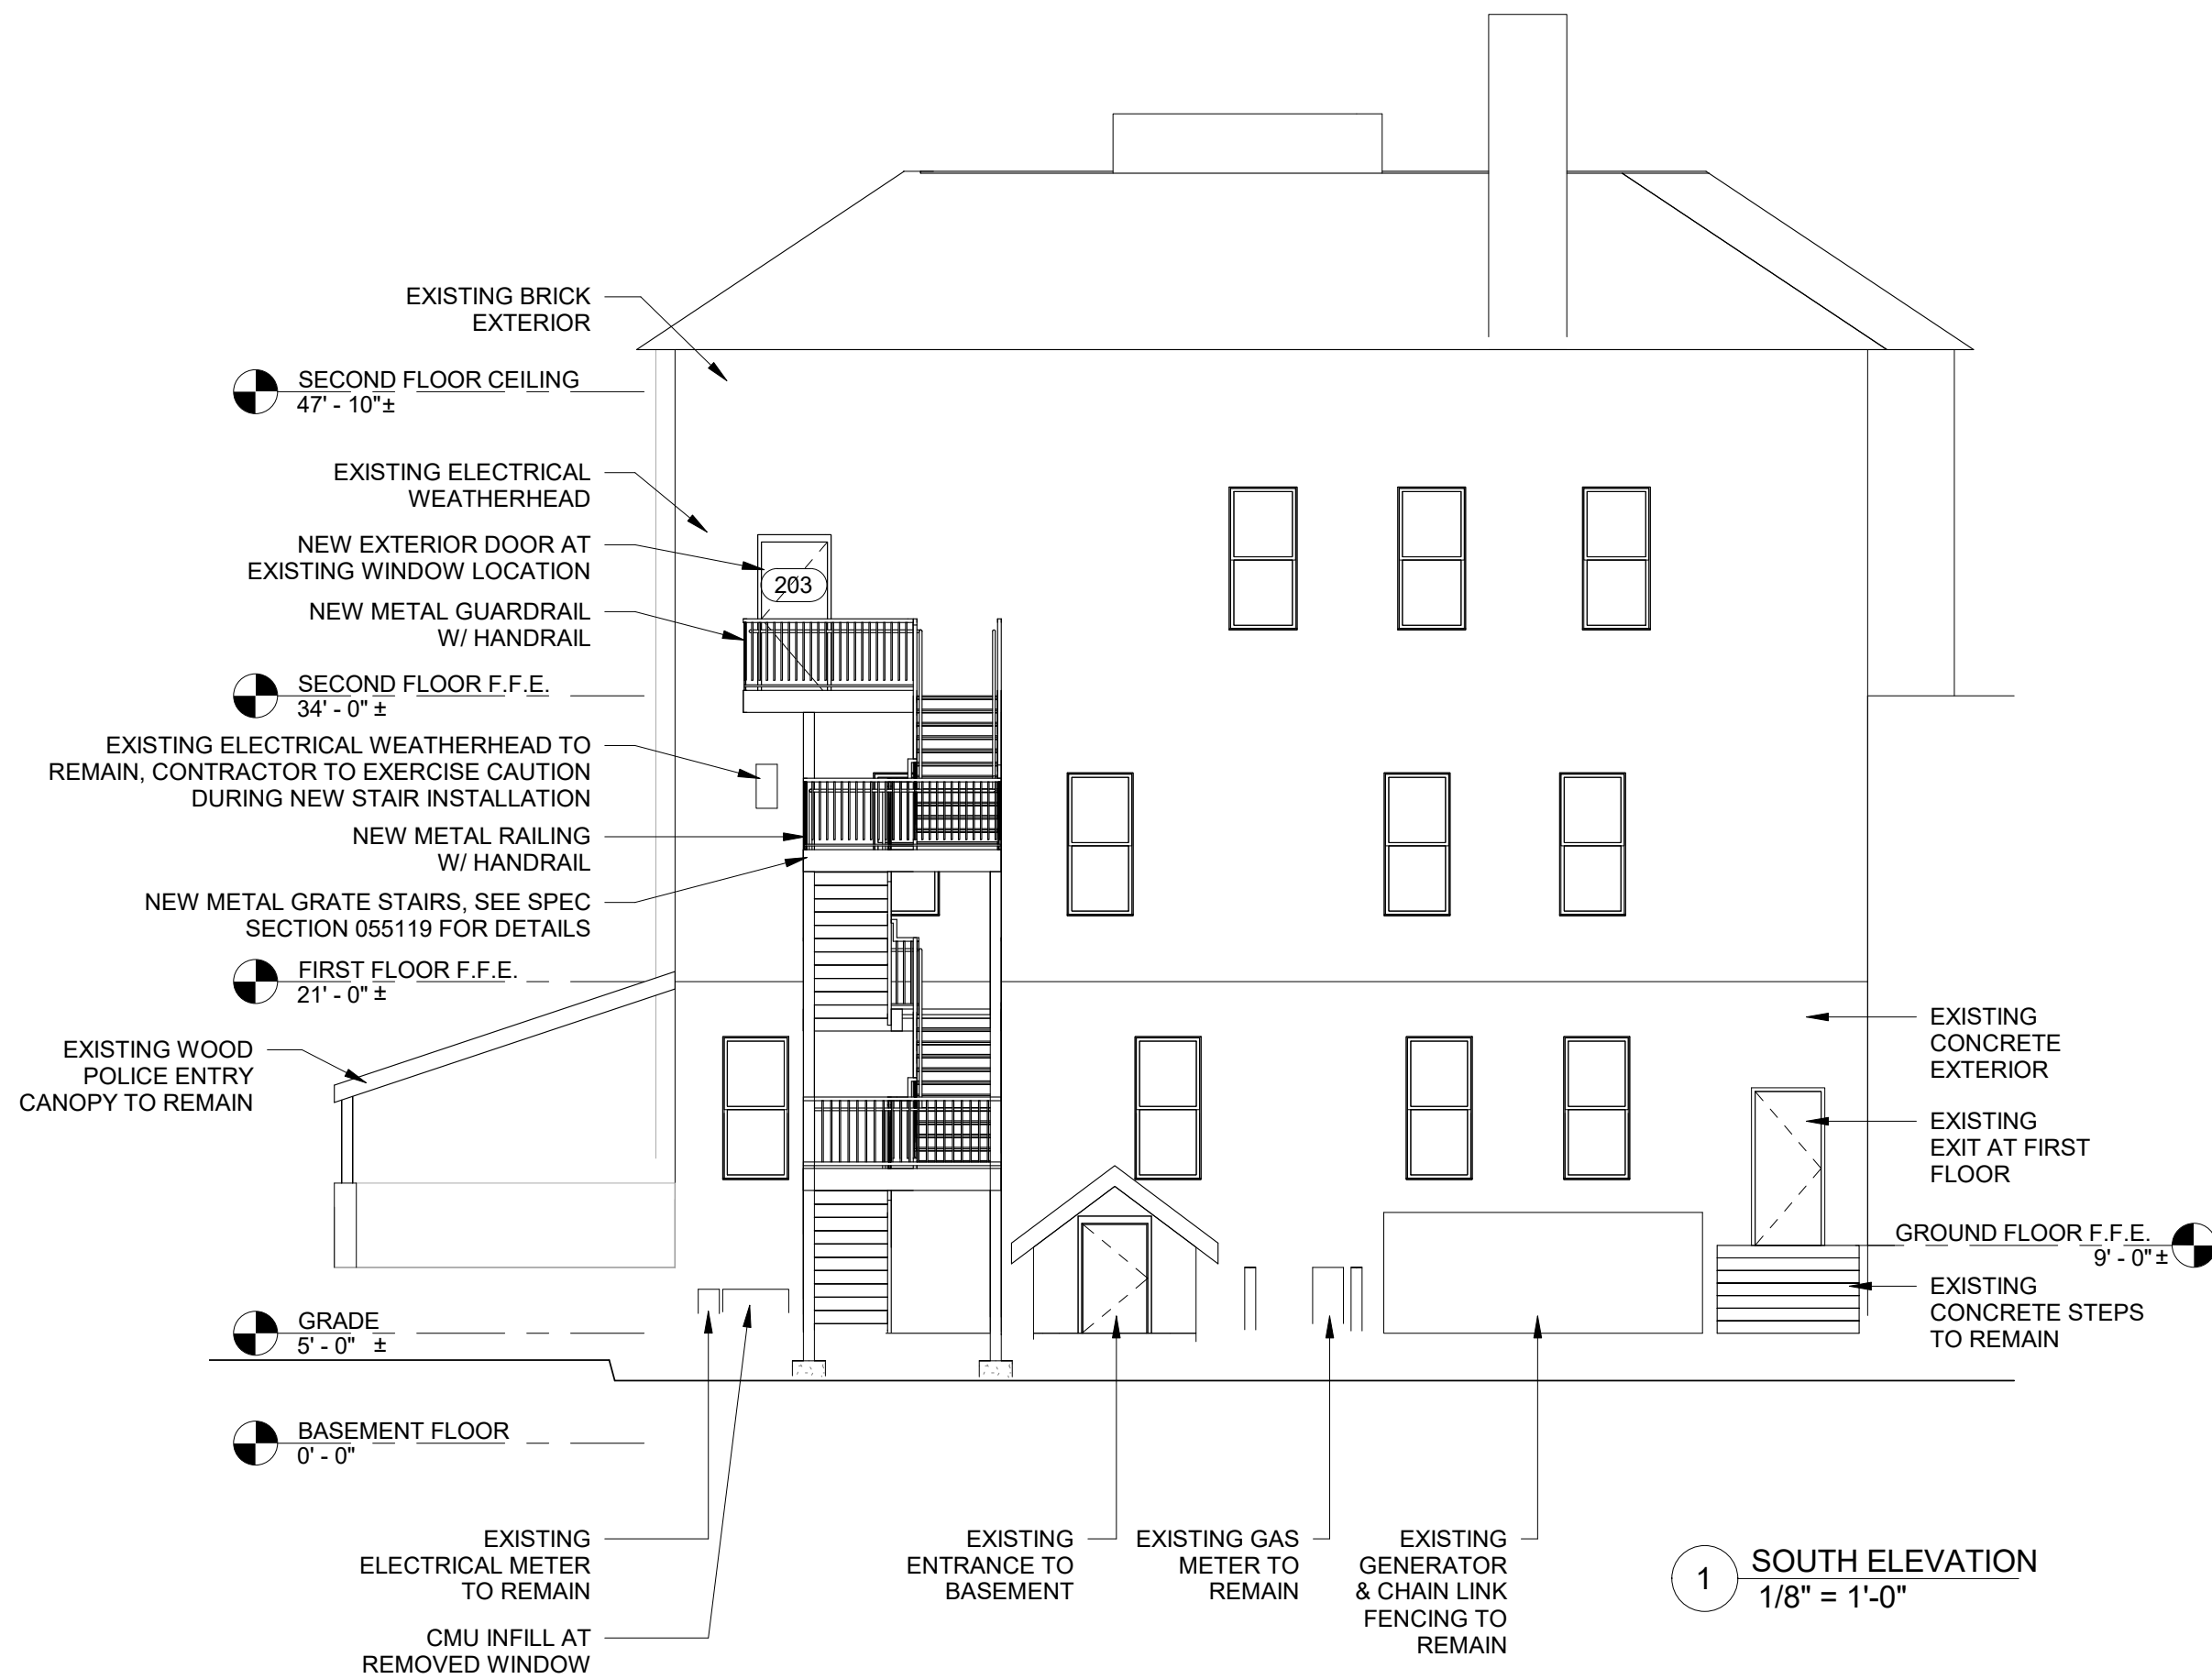
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Drawn By: MB Checked By: MM, LM

Drawing Title  
**FIRST AND SECOND FLOOR  
PLANS**

Drawing Number

**A1-02**



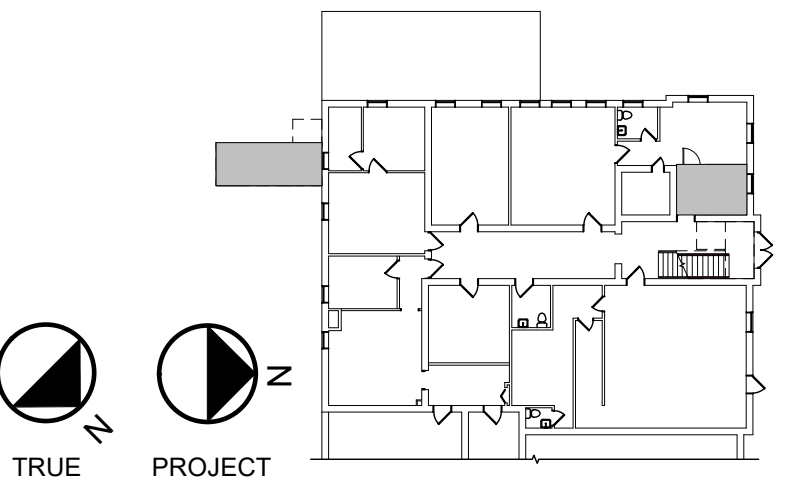
**LEGEND**

BASE BID WINDOWS

ADDITIONAL WINDOWS TO BE POTENTIALLY REPLACE, PROVIDE UNIT PRICE ON BID FORM



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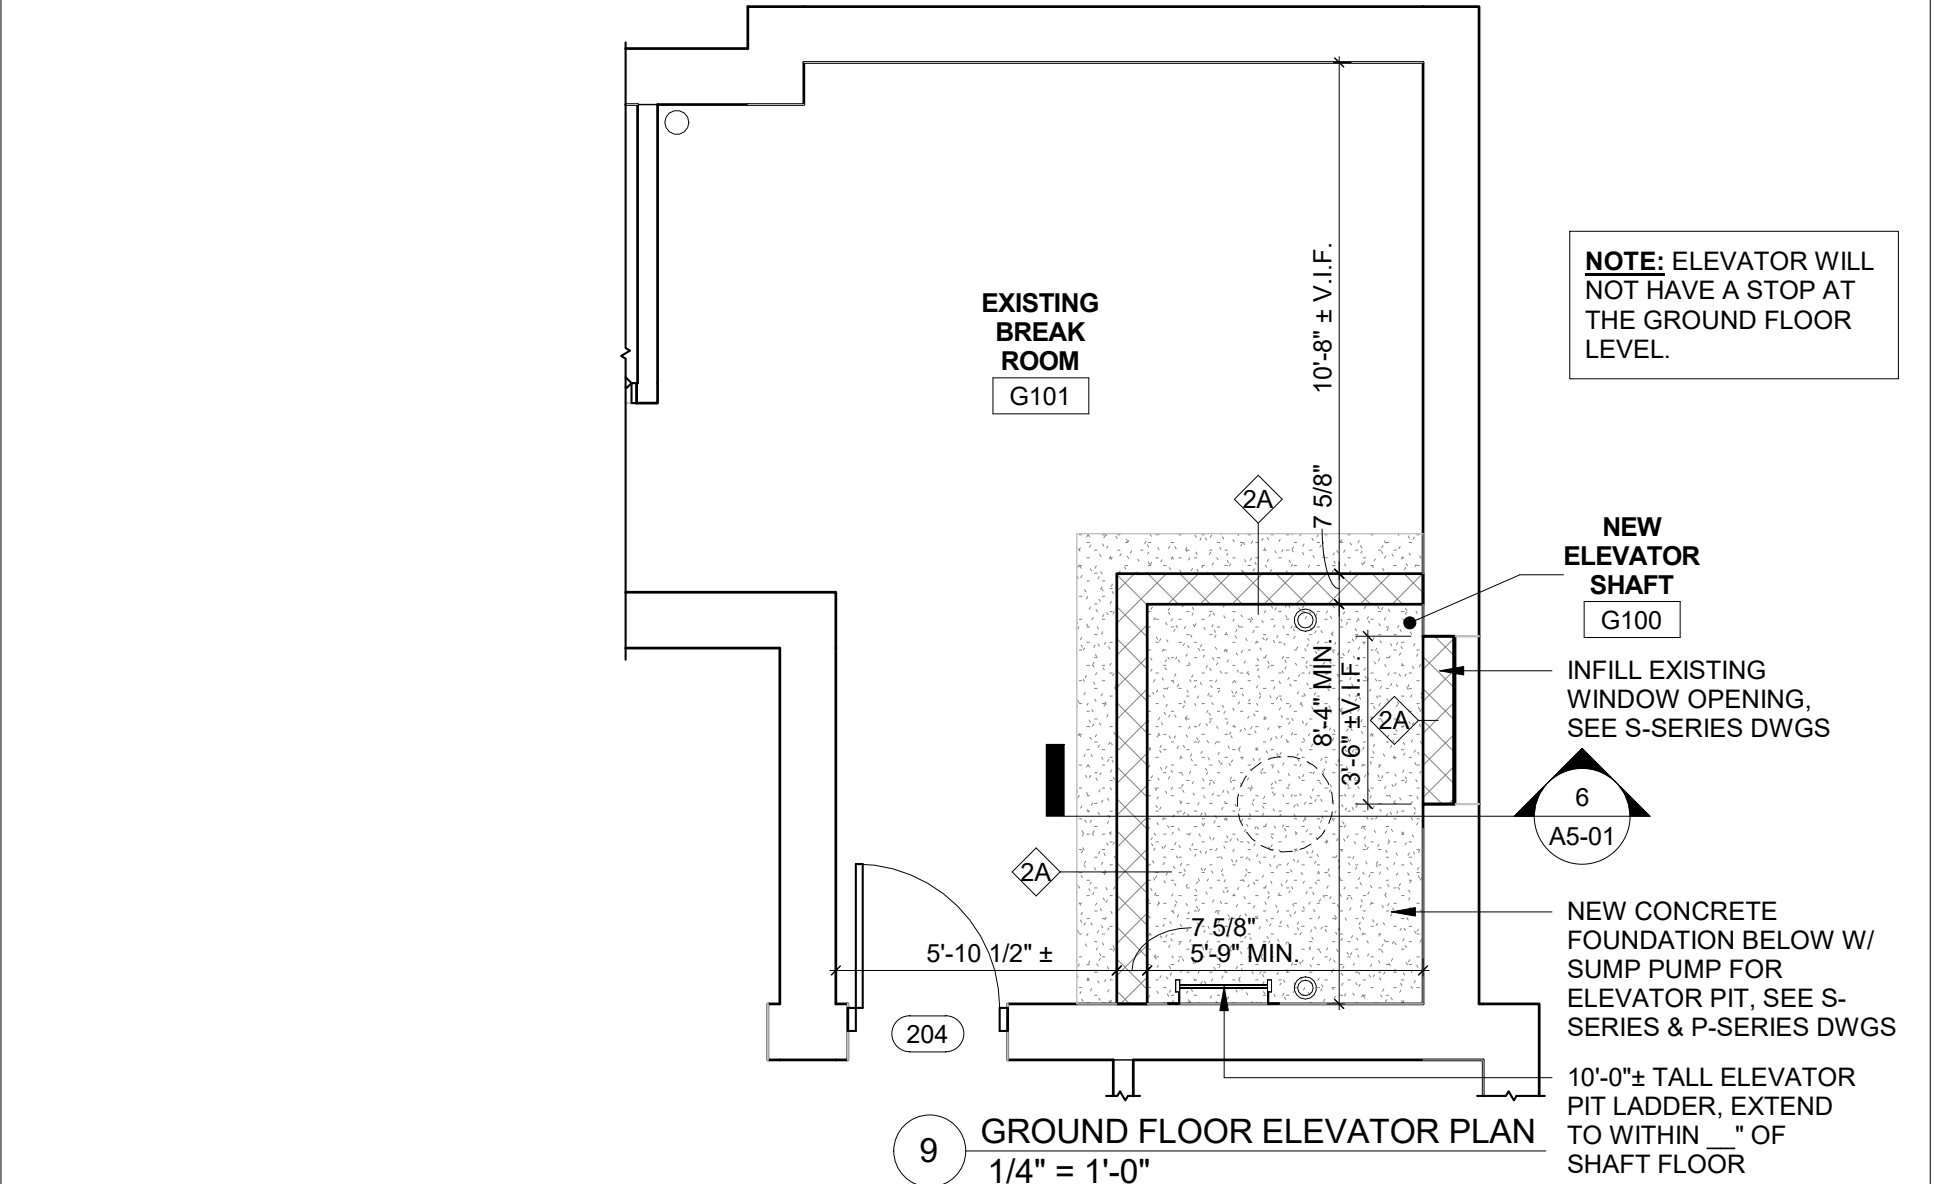
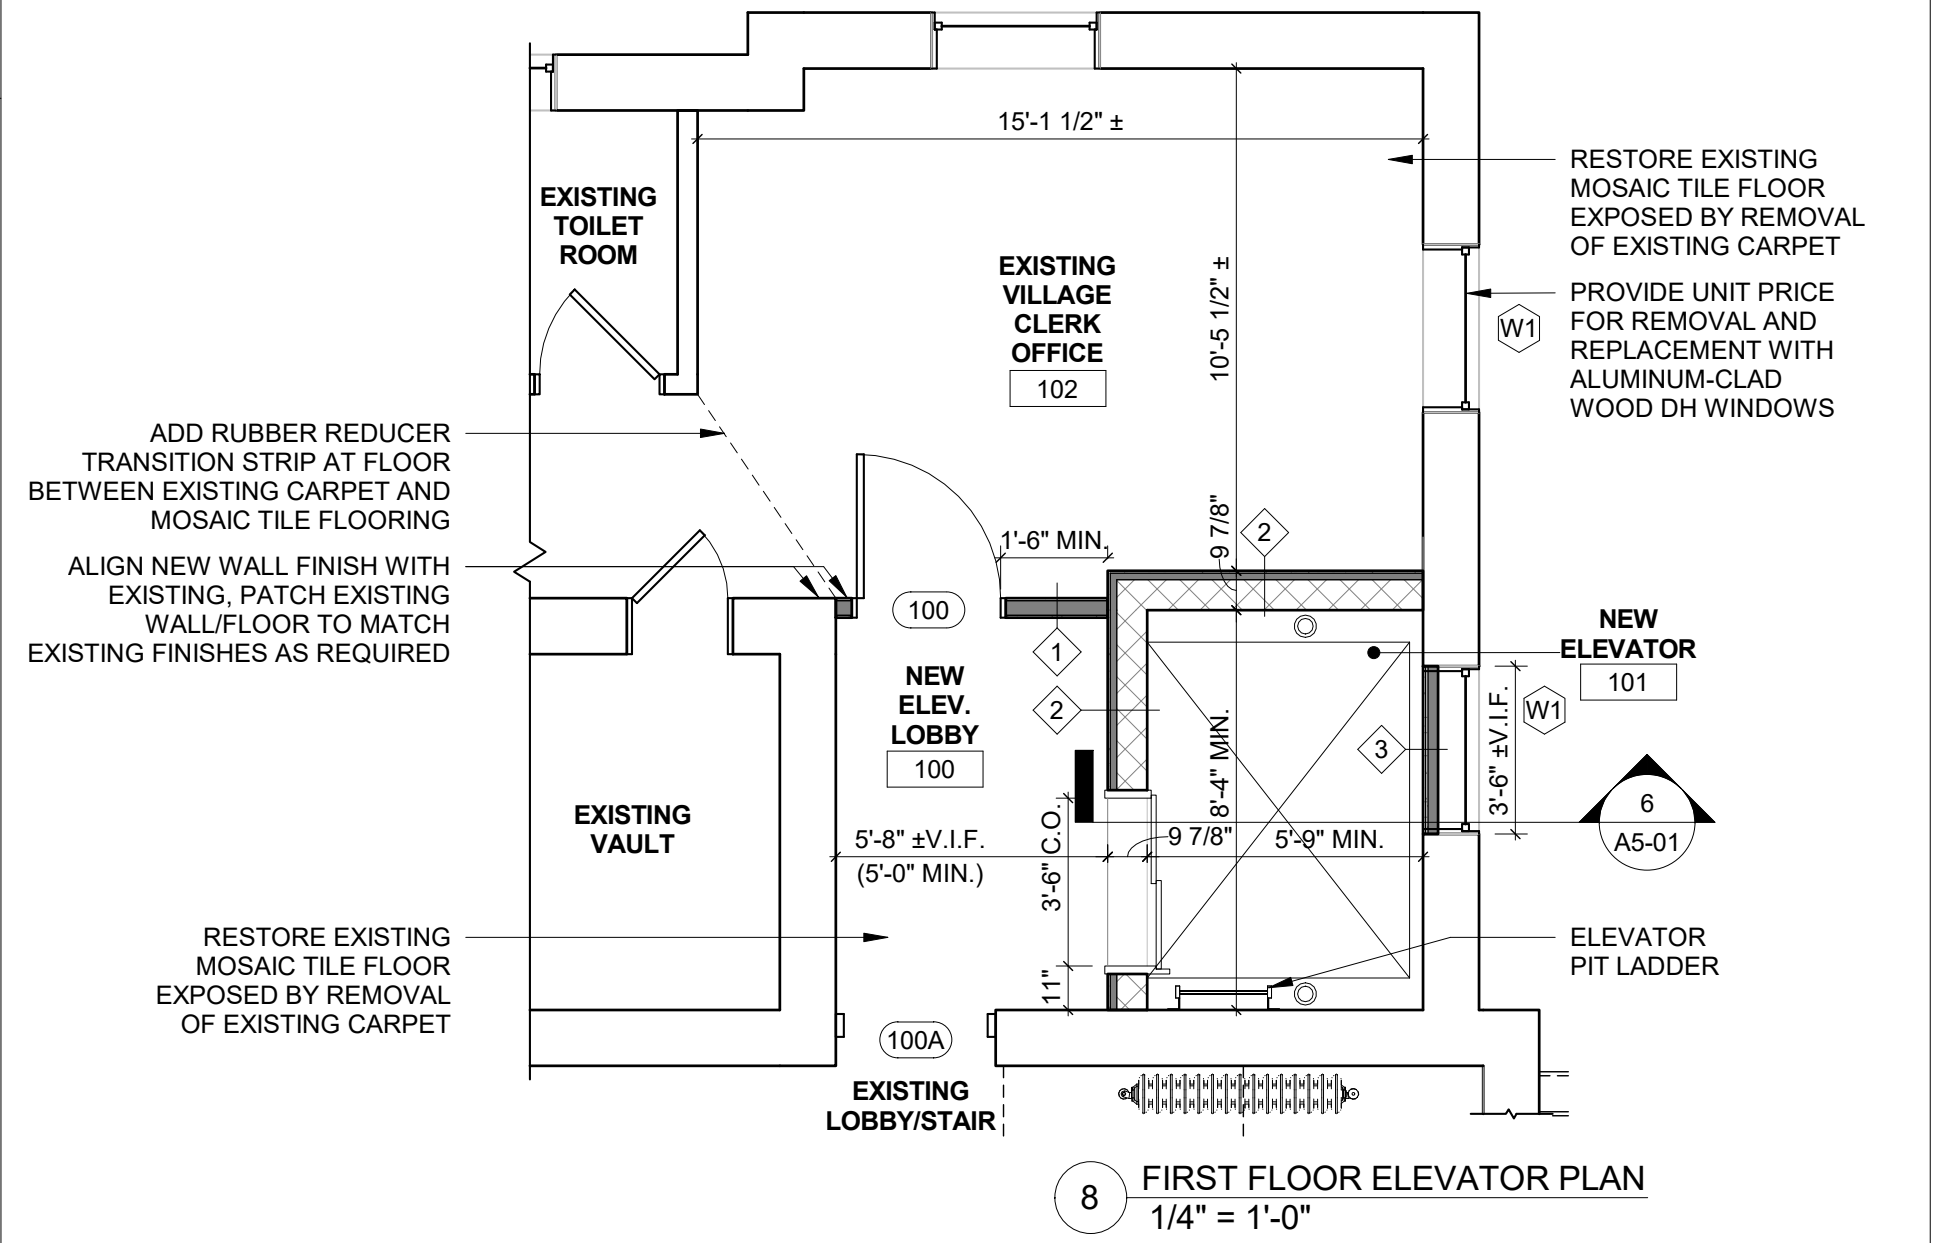
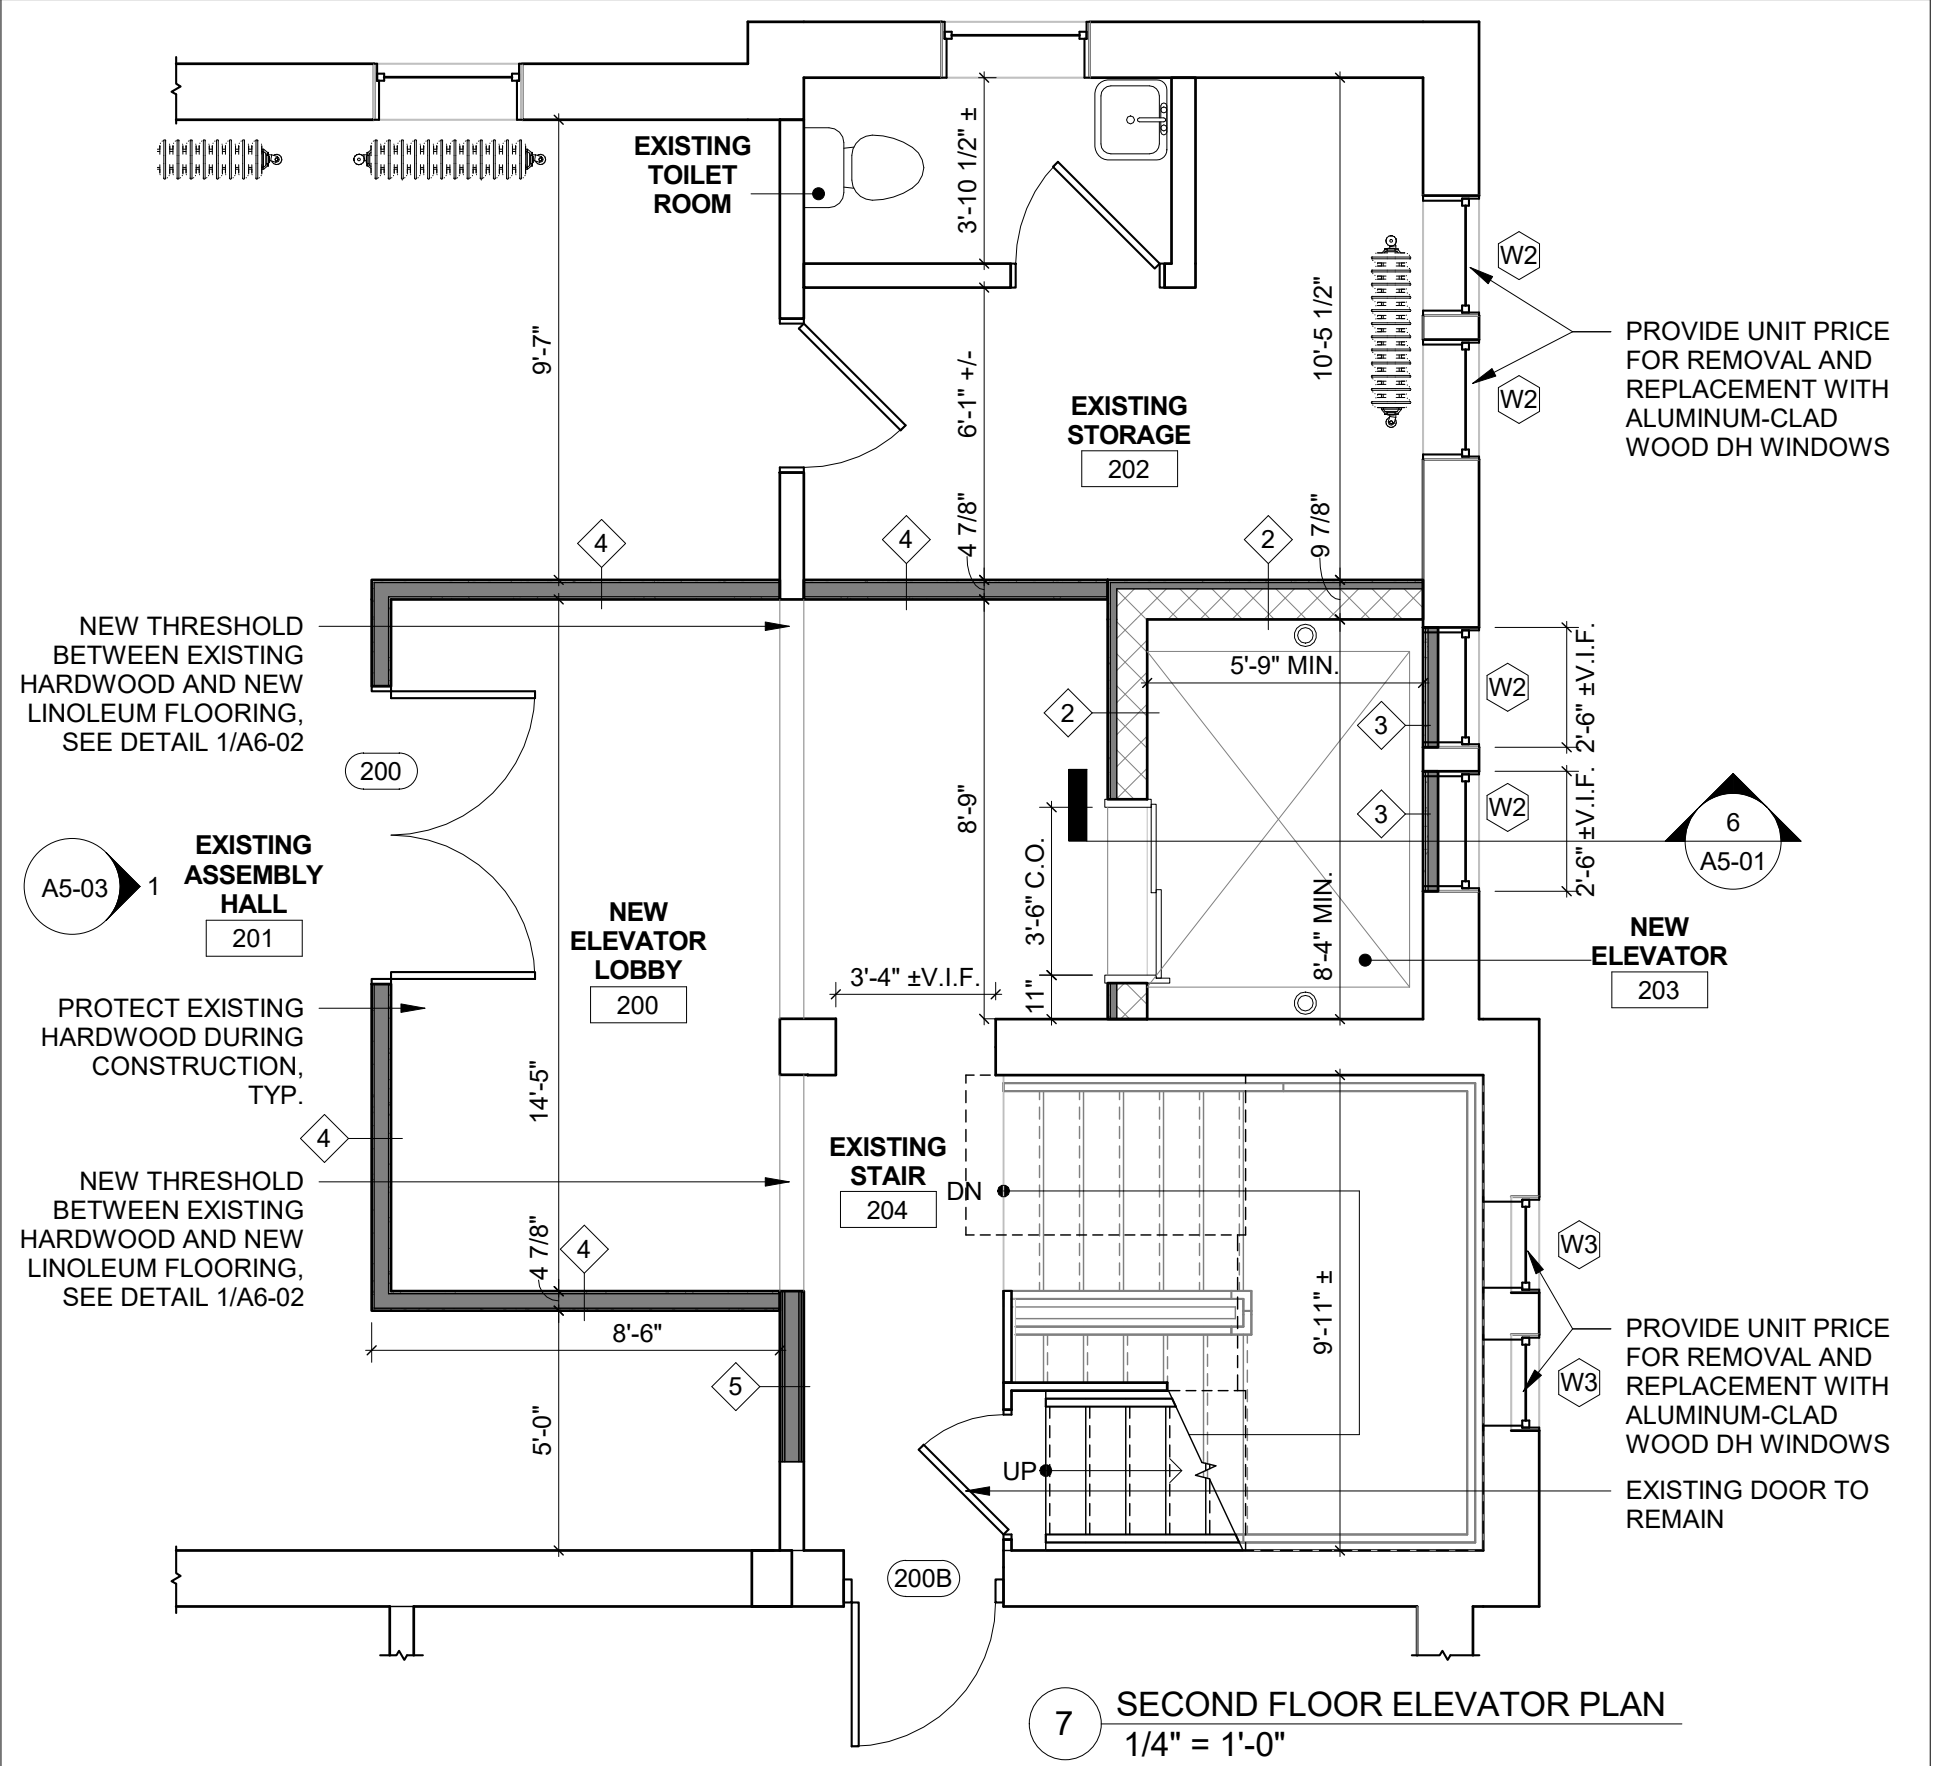
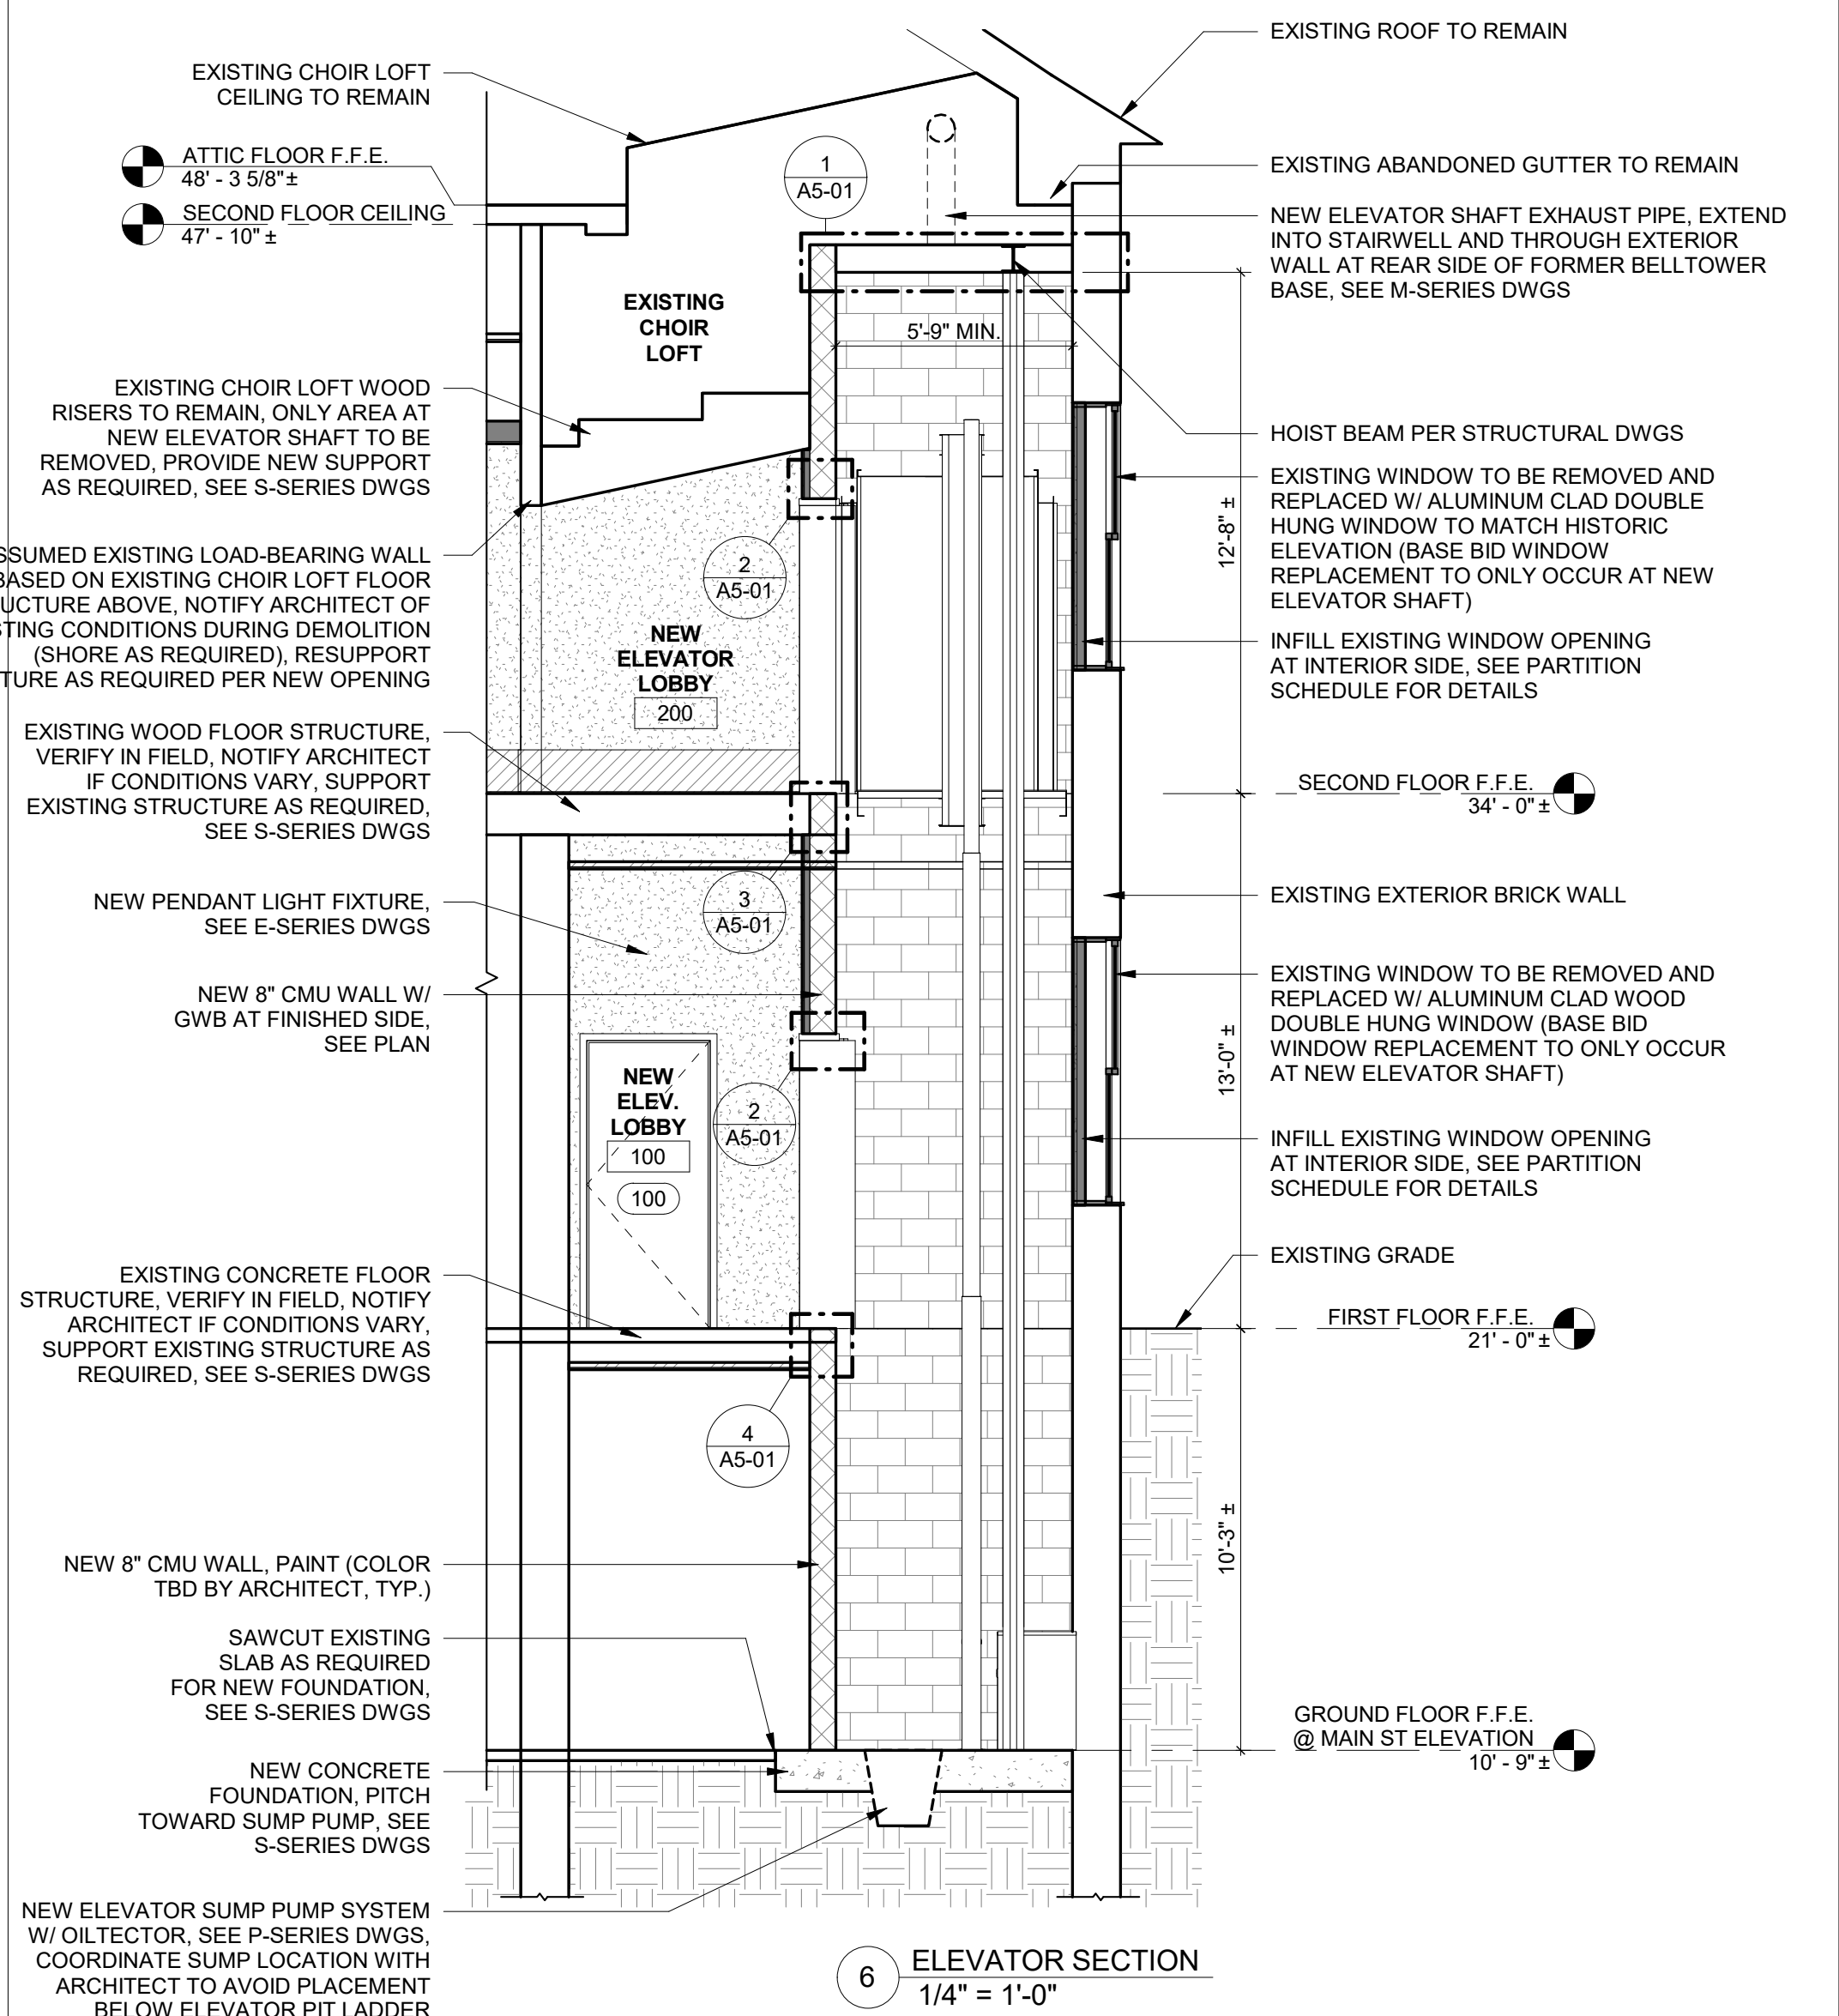
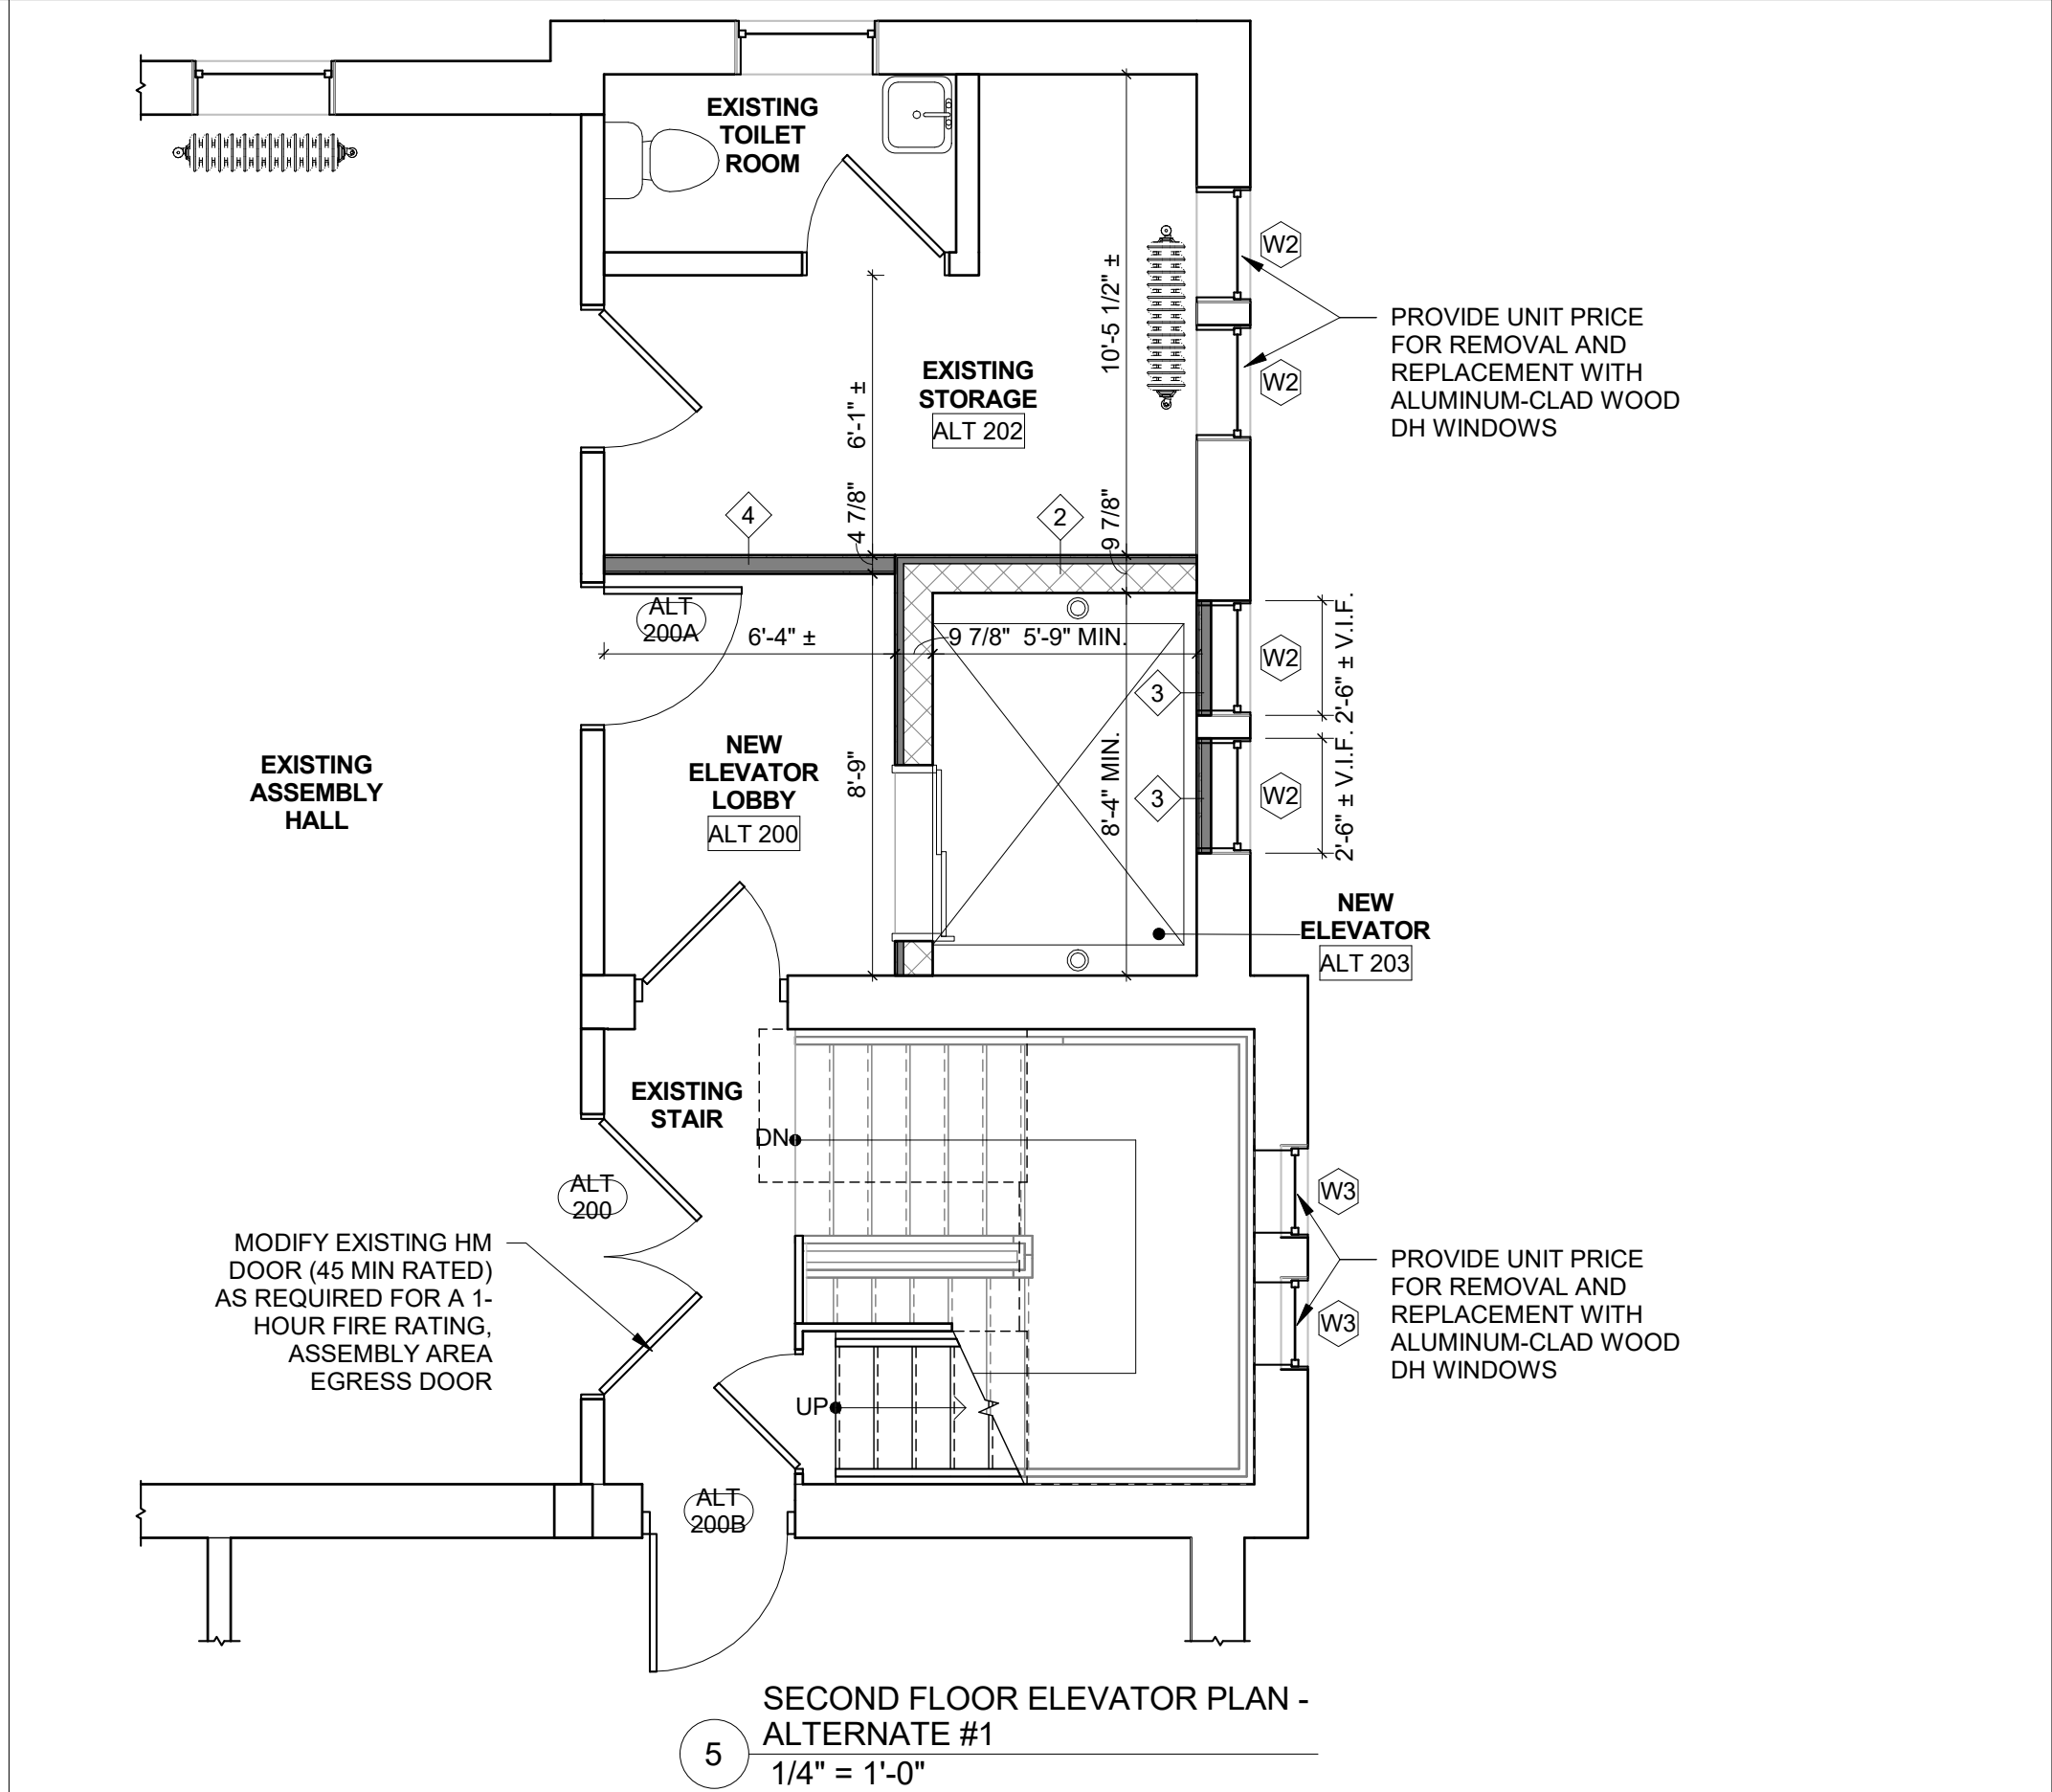
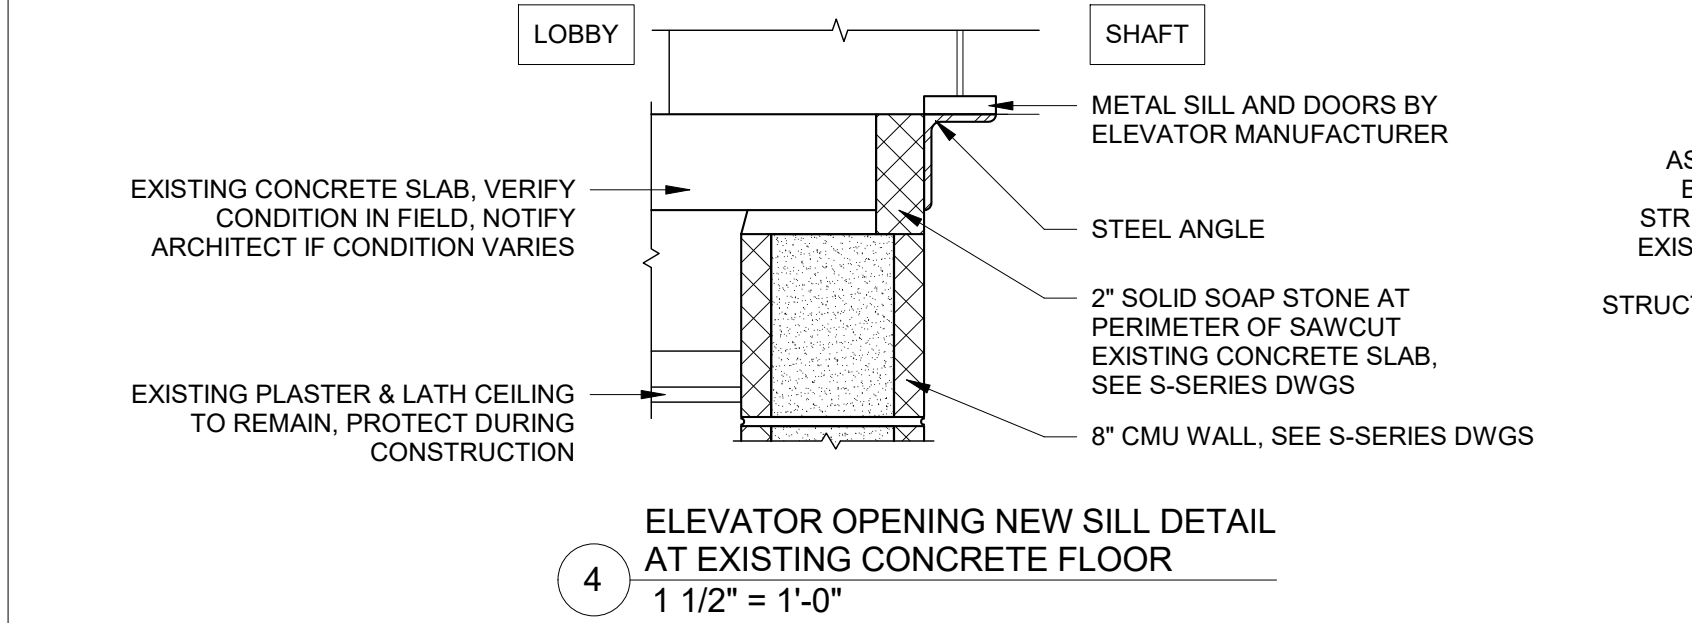
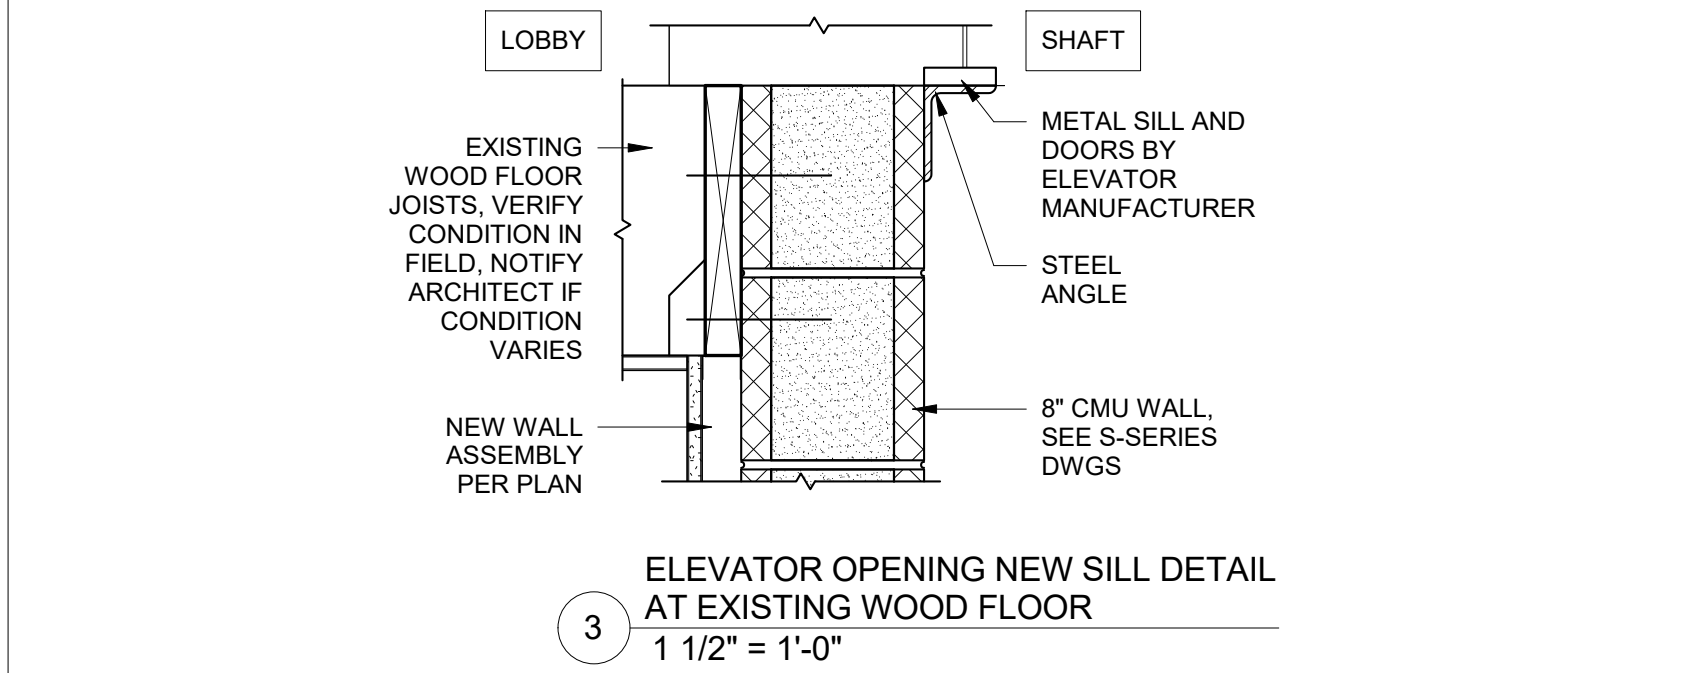
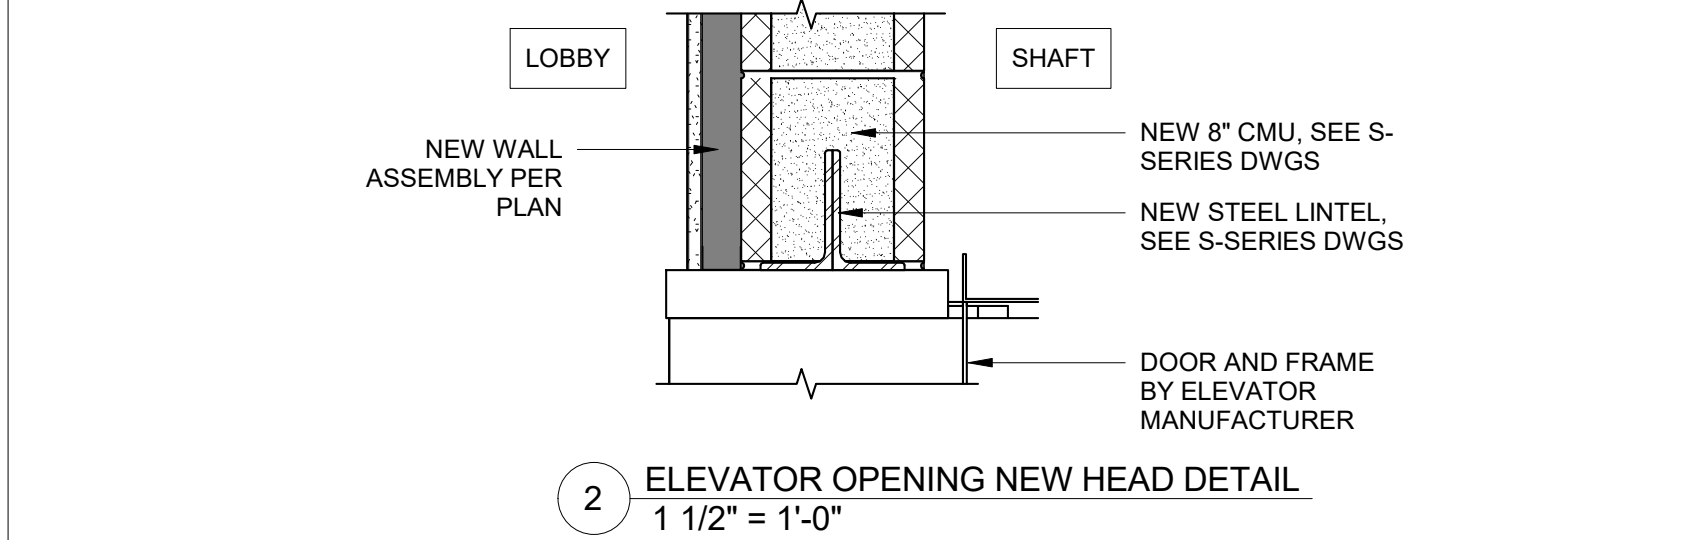
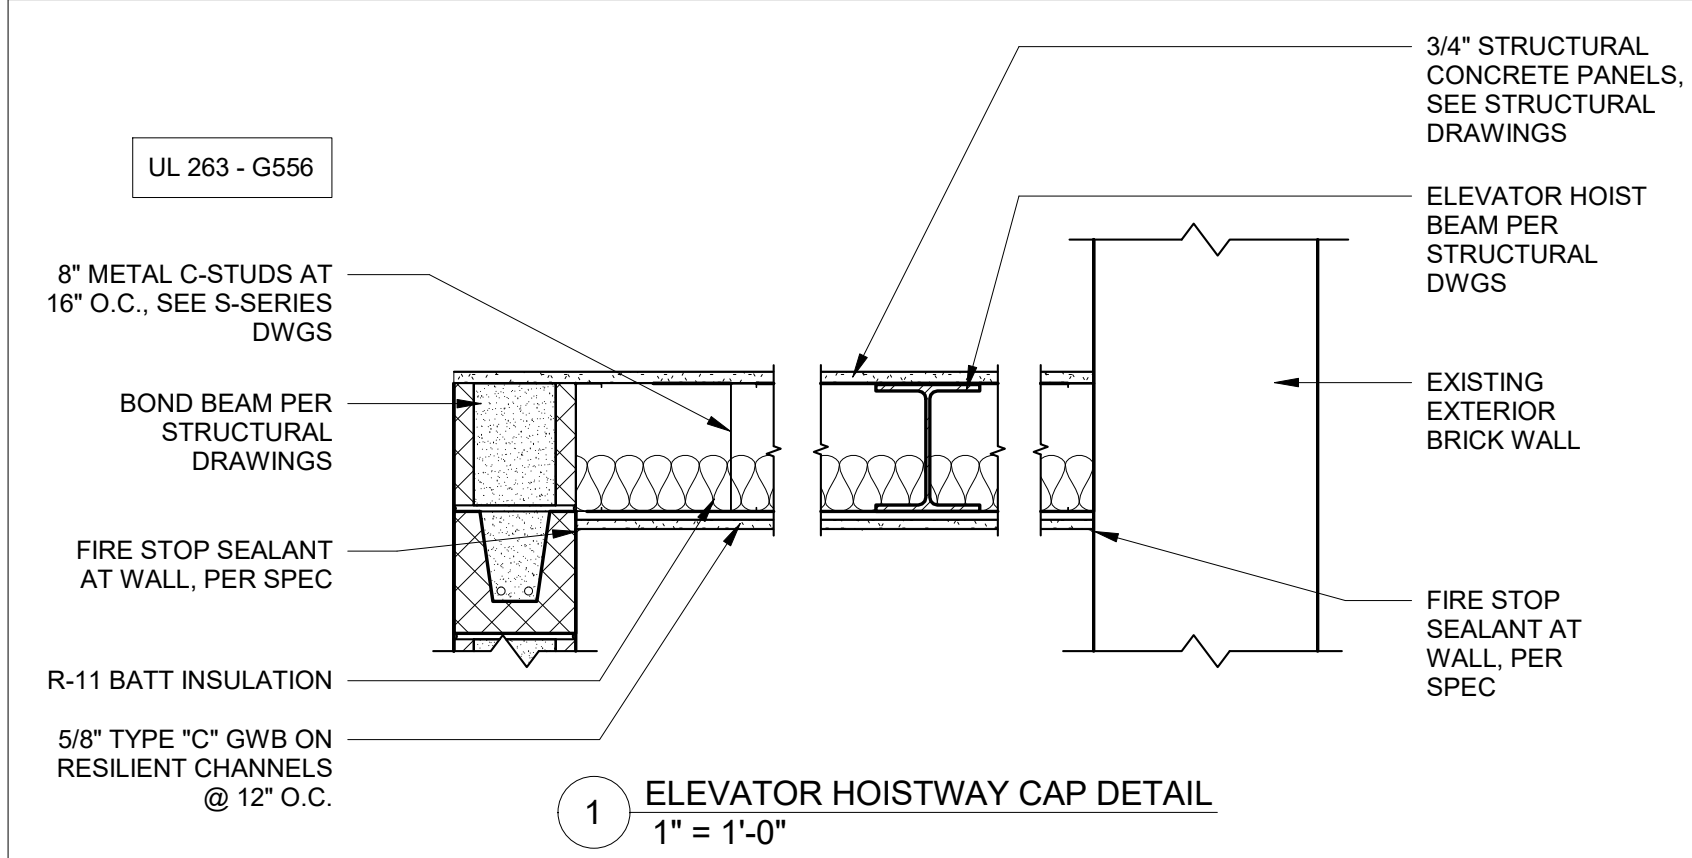
Revision Schedule		
Revision Number	Date	Description

DRAWING ISSUED:	APRIL 5, 2021
Project Number:	Scale:
00370	As indicated
Drawn By:	Checked By:
MB	MM, LM

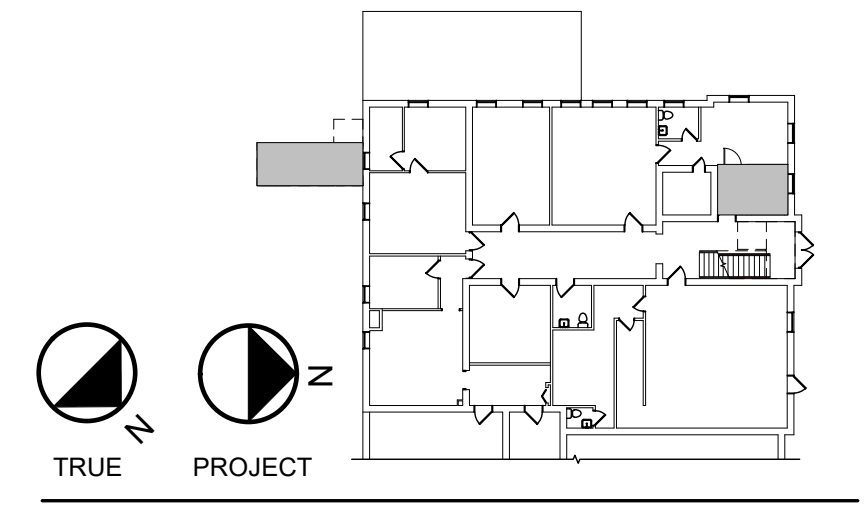
Drawing Title  
**ELEVATIONS**

Drawing Number

# A2-01



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**PERRY VILLAGE HALL  
ADA IMPROVEMENTS**

**VILLAGE OF PERRY  
46 N. MAIN ST.  
PERRY, NY 14530**

**100% CONSTRUCTION  
DOCUMENT BID SET**

NOTES & REVISIONS:

Revision Schedule		
Revision Number	Date	Description

DRAWING ISSUED: APRIL 5, 2021

Project Number: 00370 Scale: As indicated

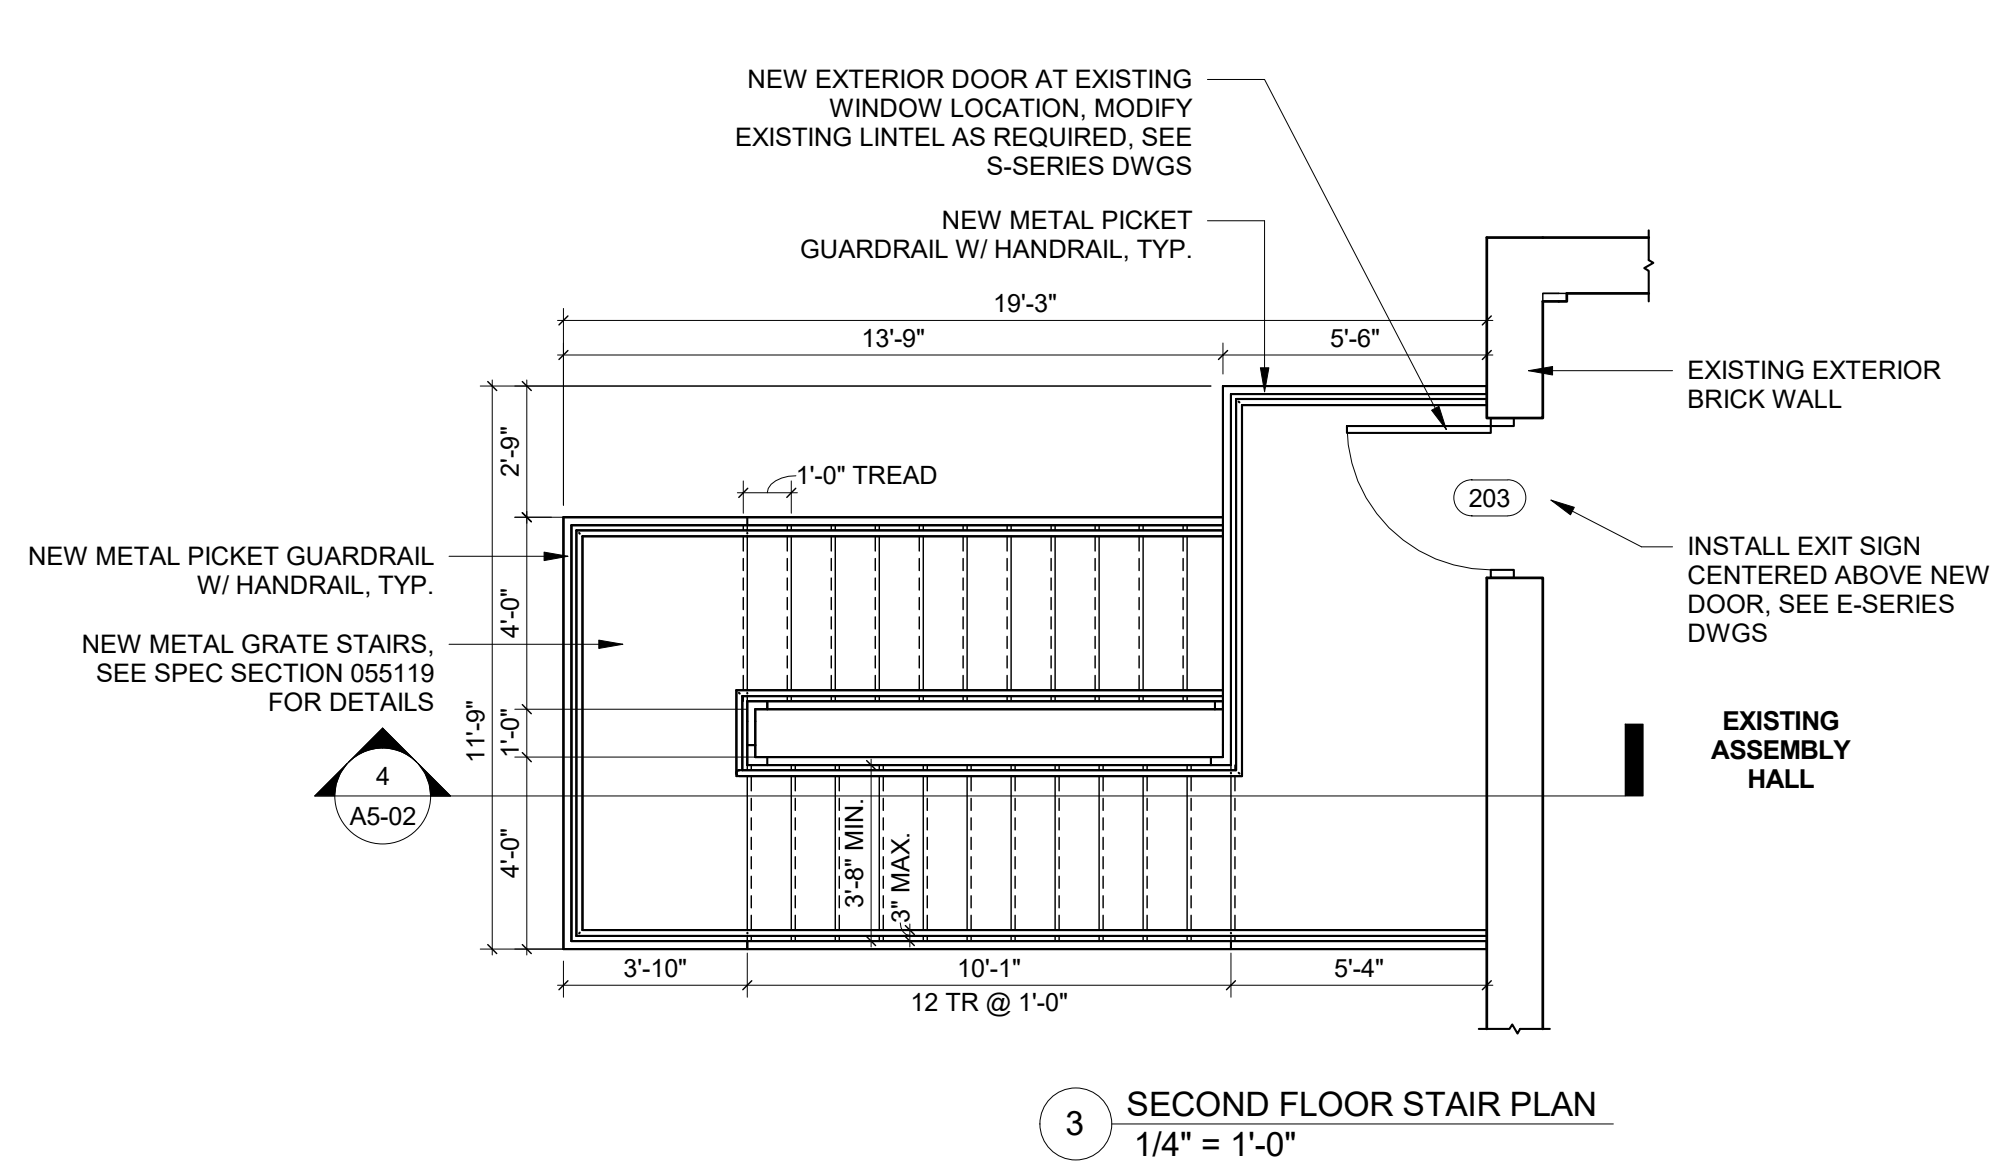
Drawn By: MB Checked By: MM, LM

Drawing Title

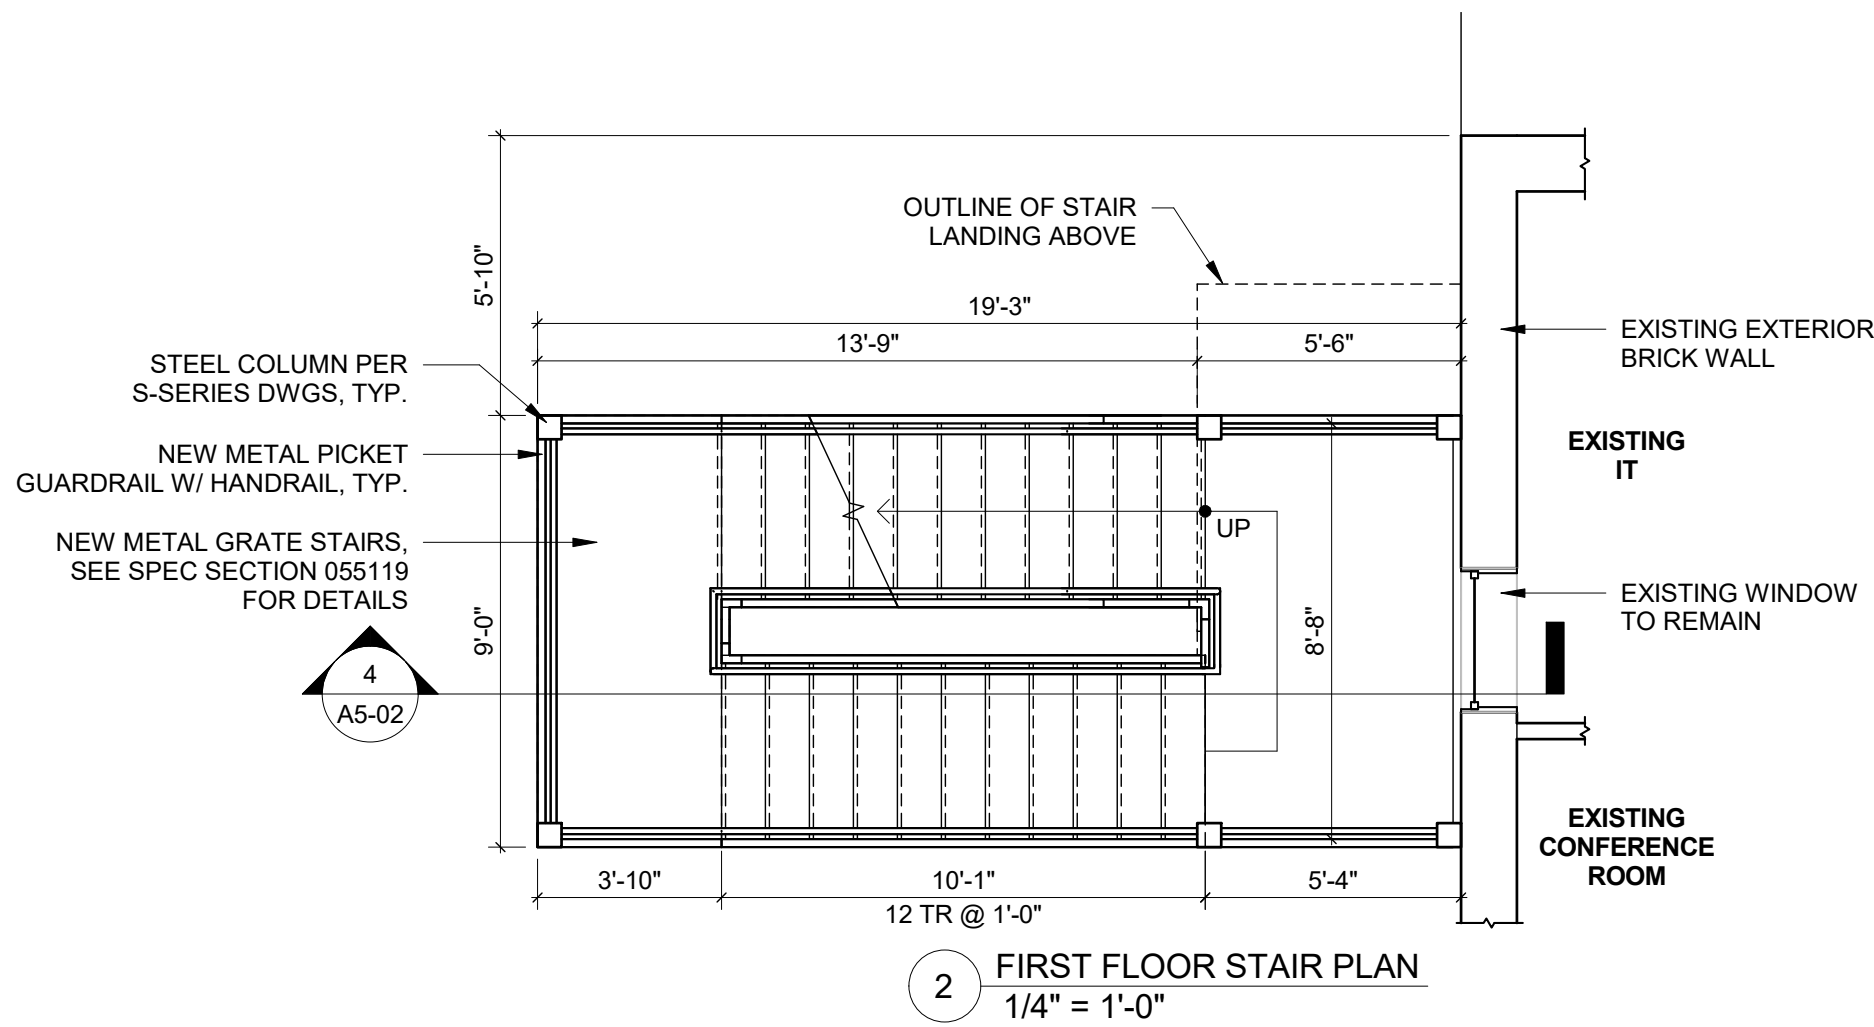
**ELEVATOR PLANS, SECTION & DETAILS**

Drawing Number

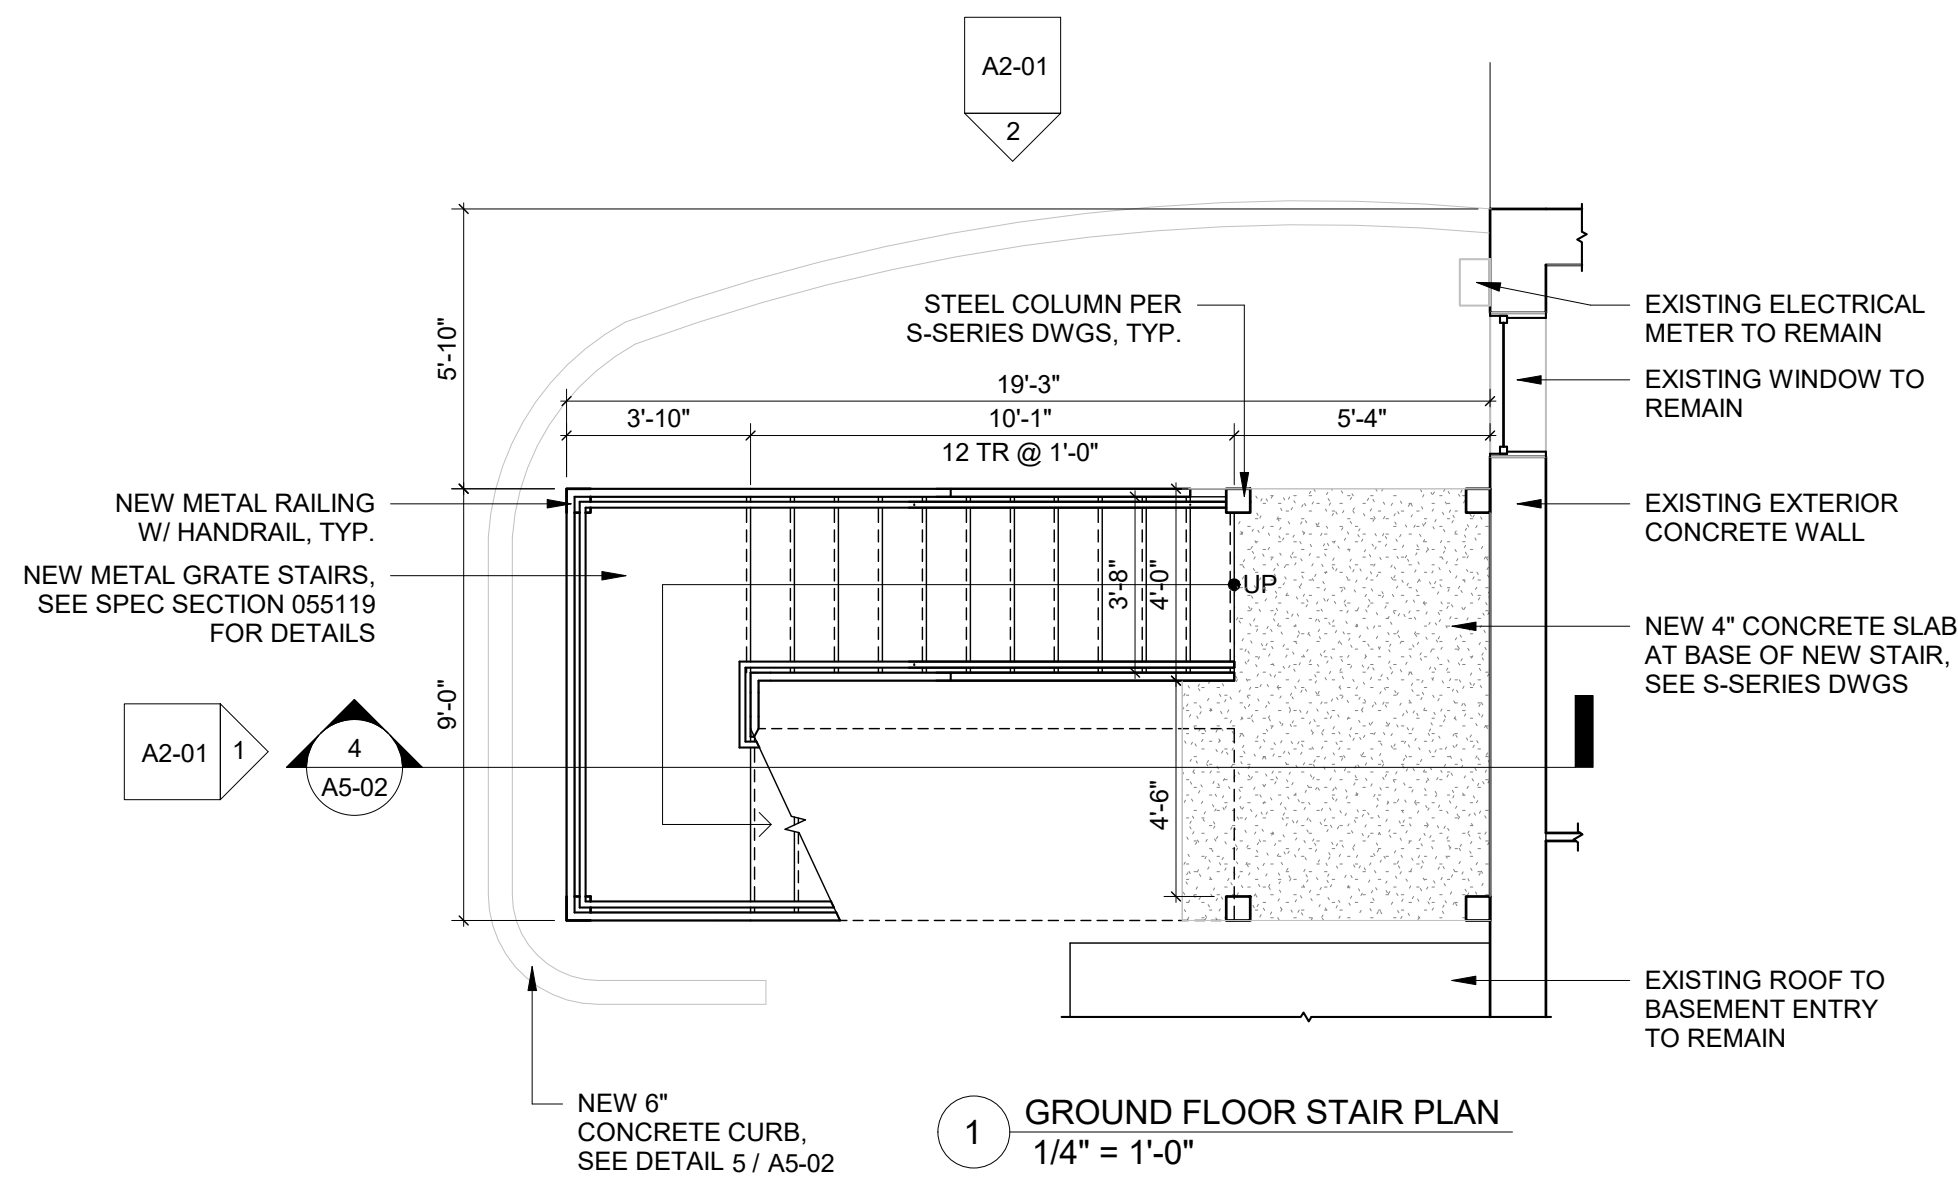
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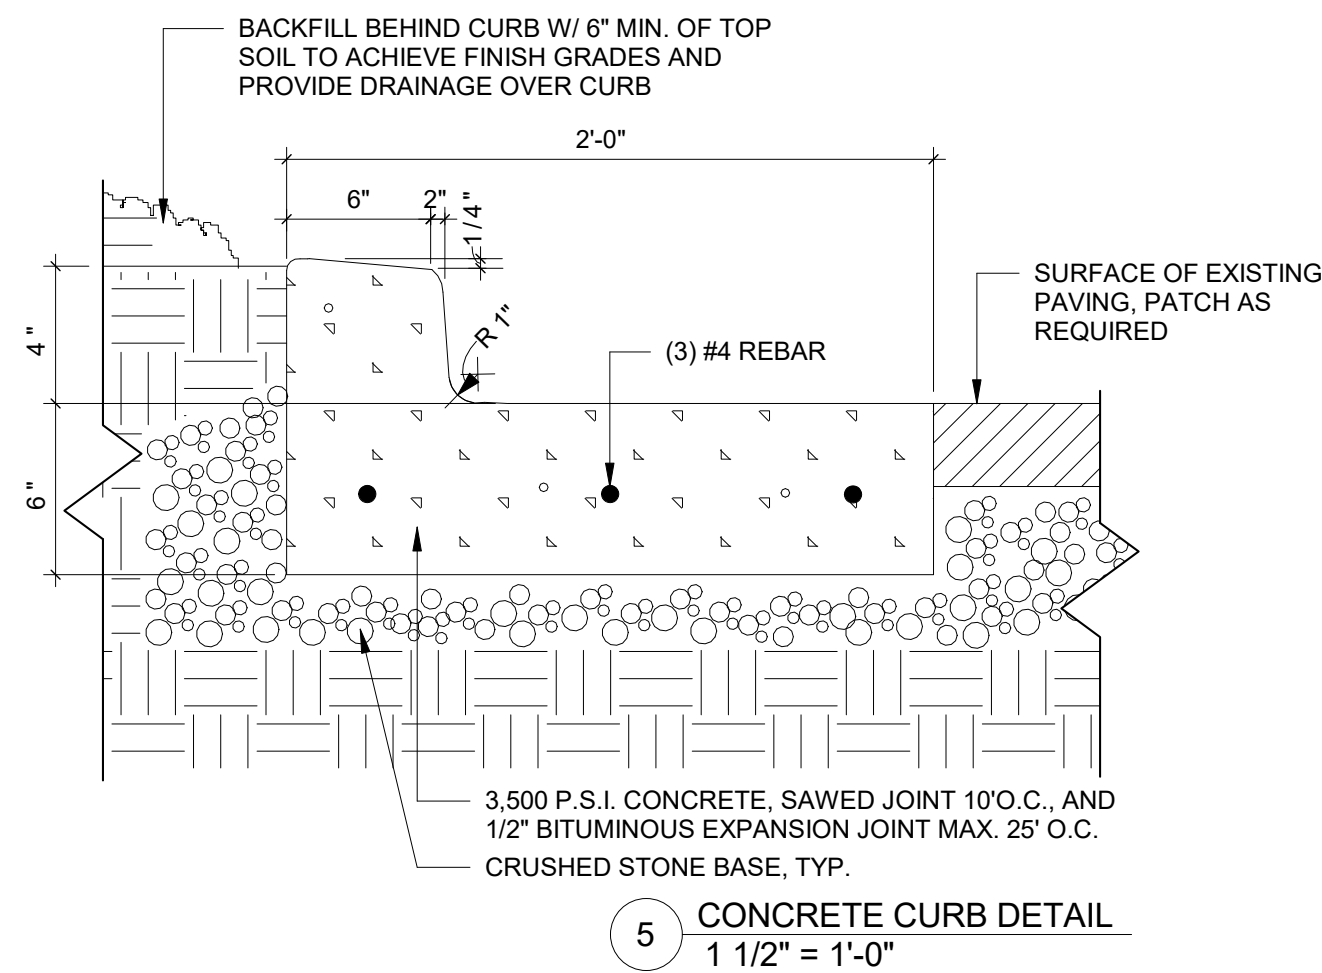
3 SECOND FLOOR STAIR PLAN  
1/4" = 1'-0"



2 FIRST FLOOR STAIR PLAN  
1/4" = 1'-0"

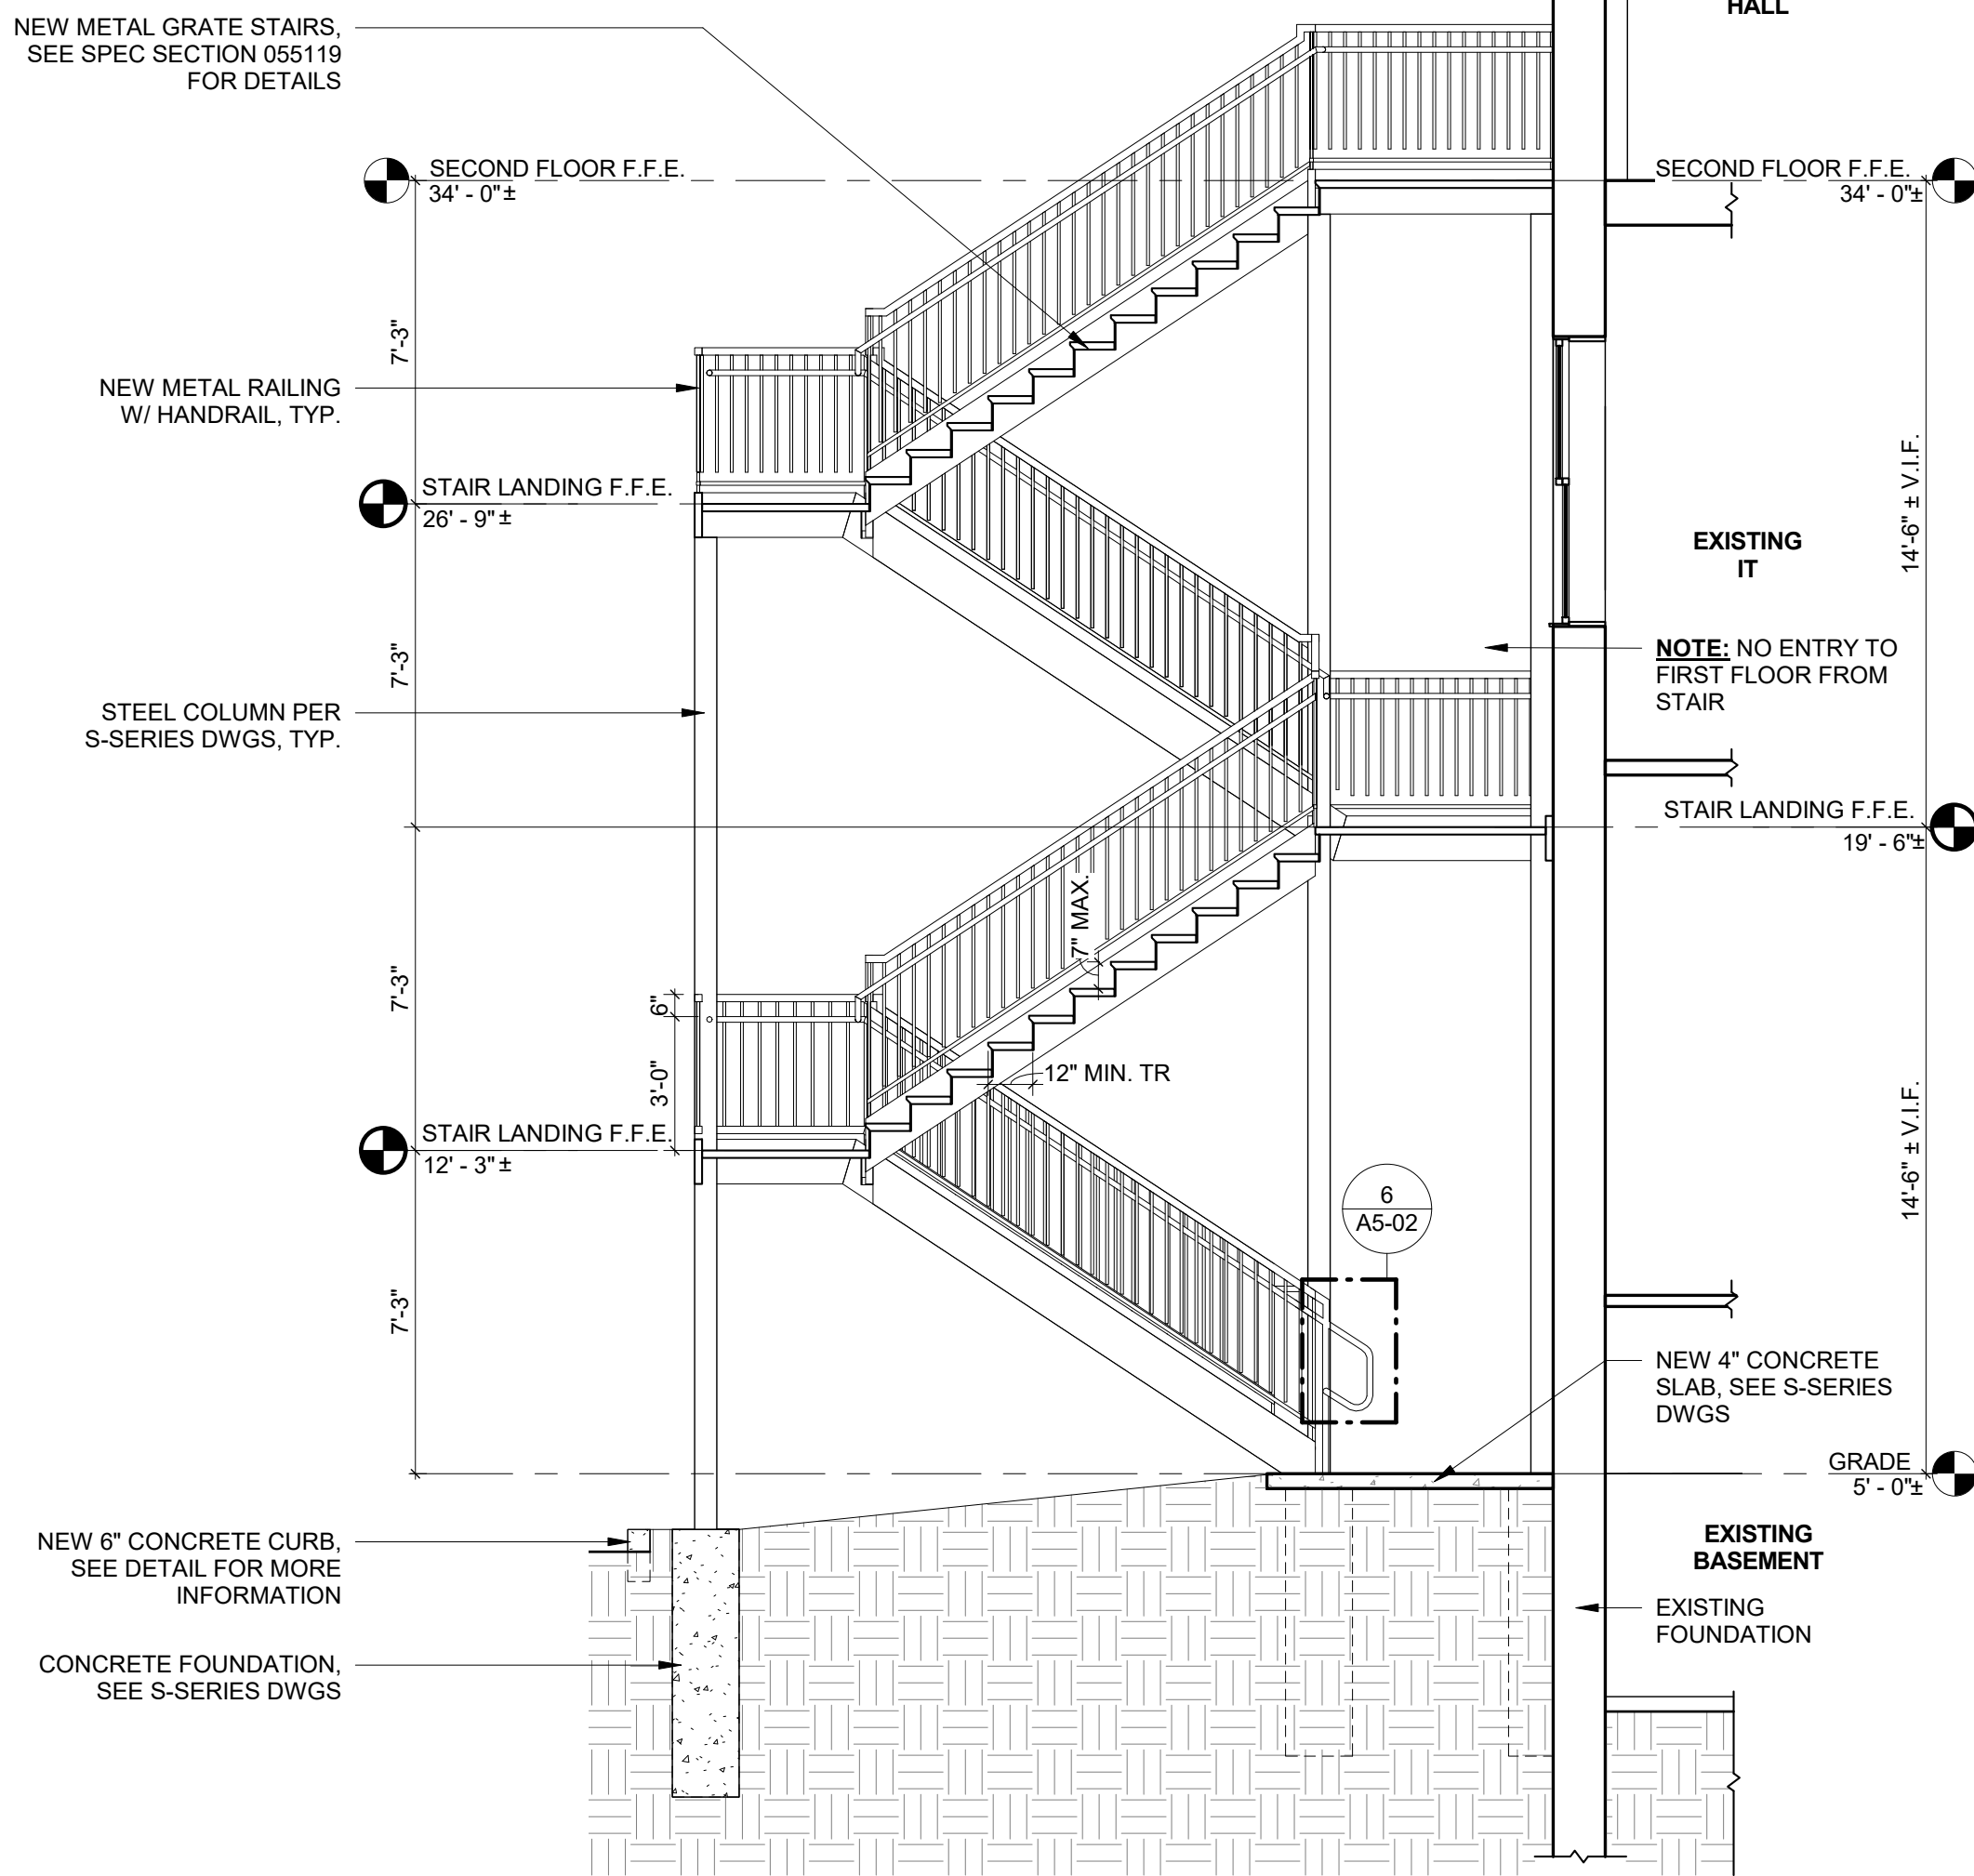


1 GROUND FLOOR STAIR PLAN  
1/4" = 1'-0"



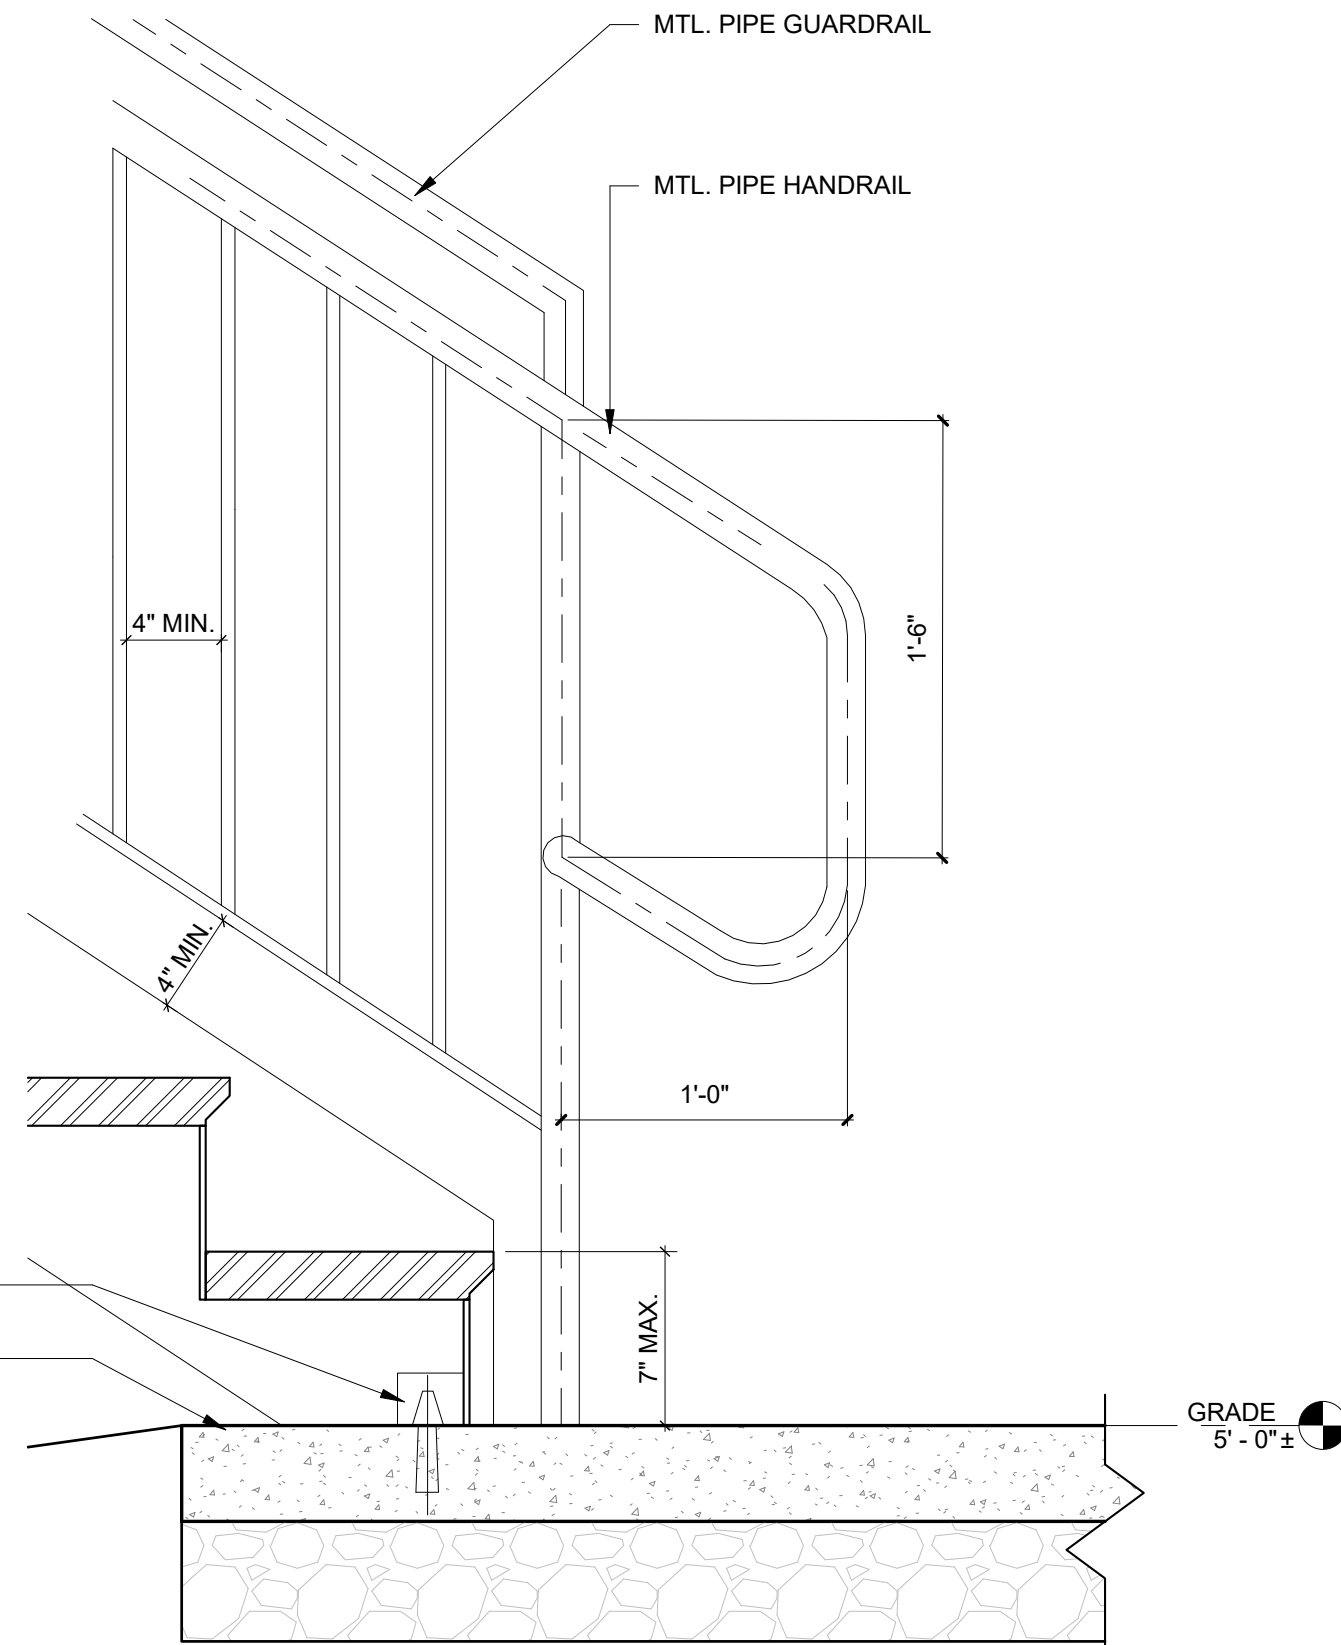
5 CONCRETE CURB DETAIL  
1 1/2" = 1'-0"

NOTE: ALL FASTENERS TO BE LOCATED AT MASONRY JOINTS.



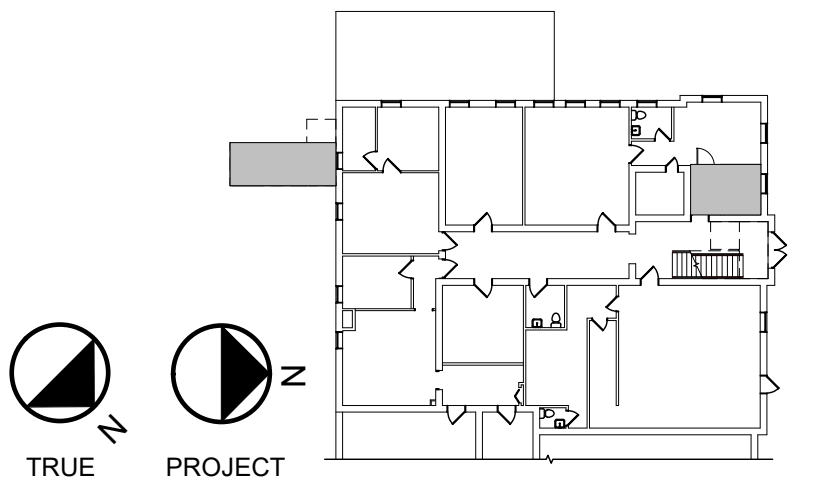
4 EXTERIOR STAIR SECTION  
1/4" = 1'-0"

STAIR STRINGER W/ STEEL ANGEL AND ANCHOR. SEE S-SERIES DWGS  
NEW 4" CONCRETE SLAB W/ 4" COMPACTED STONE BASE, SEE S-SERIES DWGS



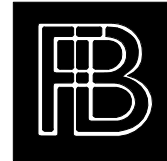
6 STAIR DETAIL  
1 1/2" = 1'-0"

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## PERRY VILLAGE HALL ADA IMPROVEMENTS

VILLAGE OF PERRY  
46 N. MAIN ST.  
PERRY, NY 14530

100% CONSTRUCTION  
DOCUMENT BID SET

NOTES & REVISIONS:

Revision Schedule		
Revision Number	Date	Description

DRAWING ISSUED: APRIL 5, 2021

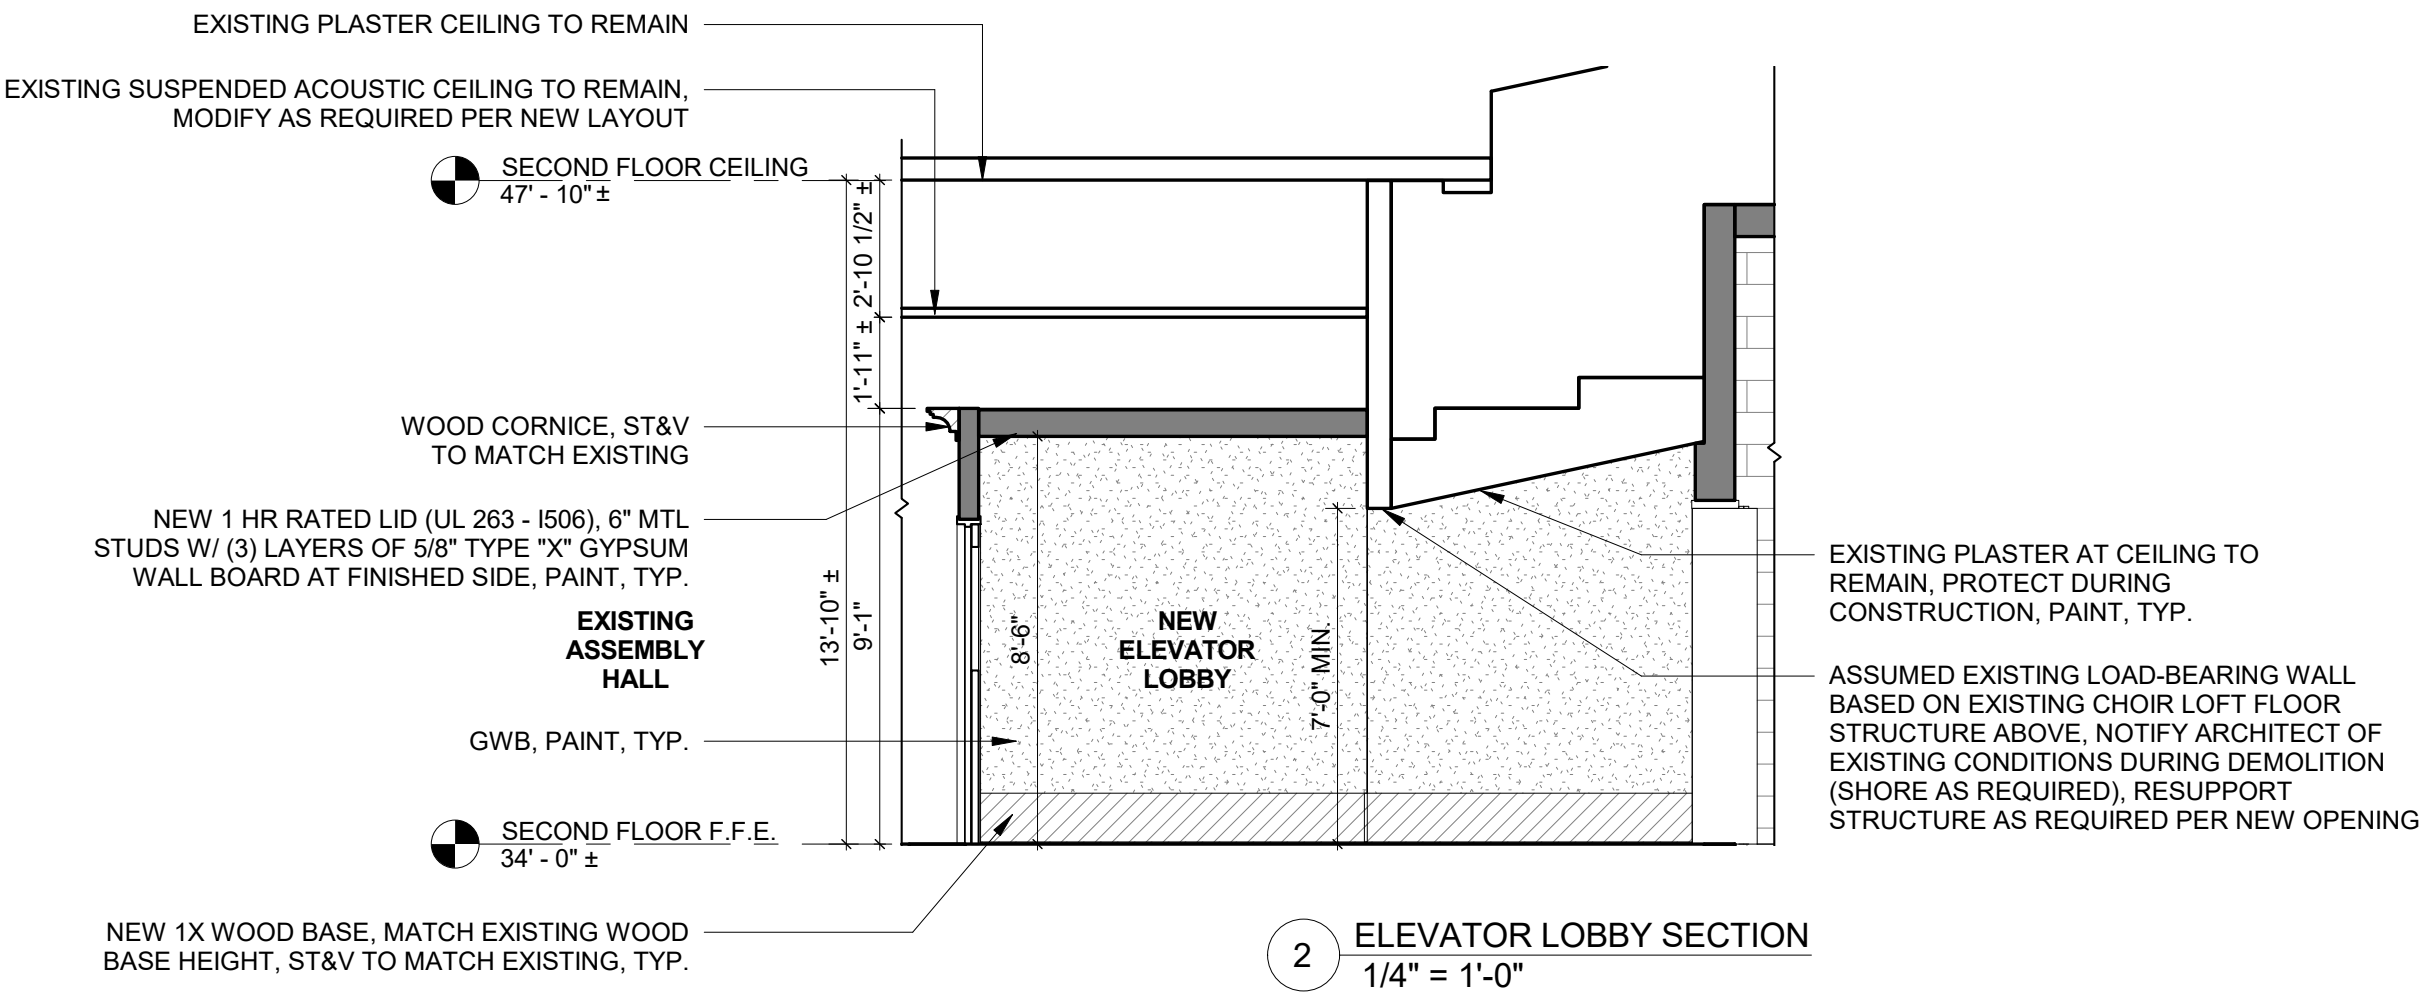
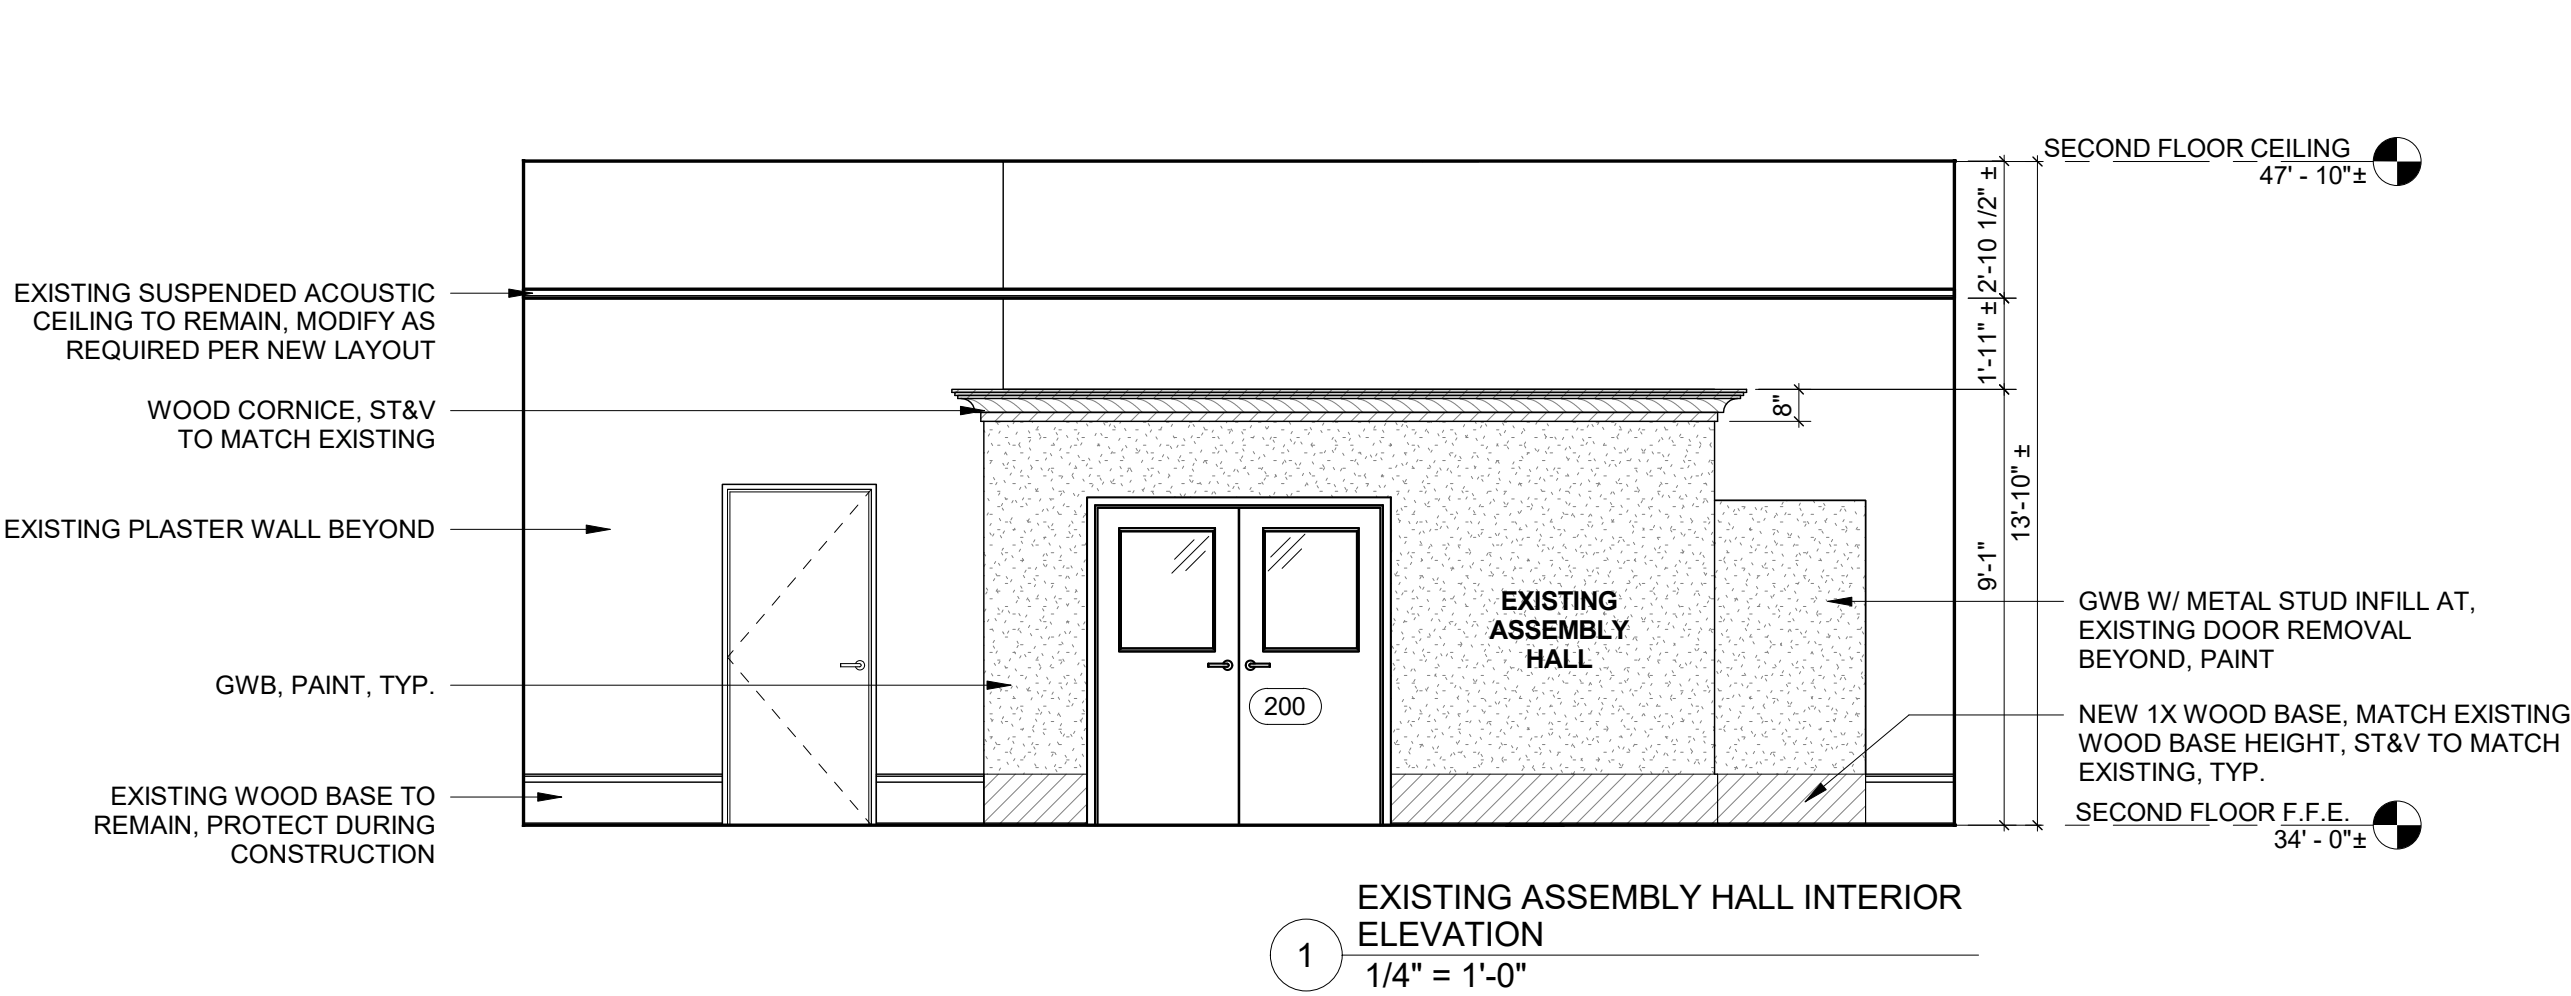
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Scale: As indicated

Drawn By: MB  
Checked By: MM, LM

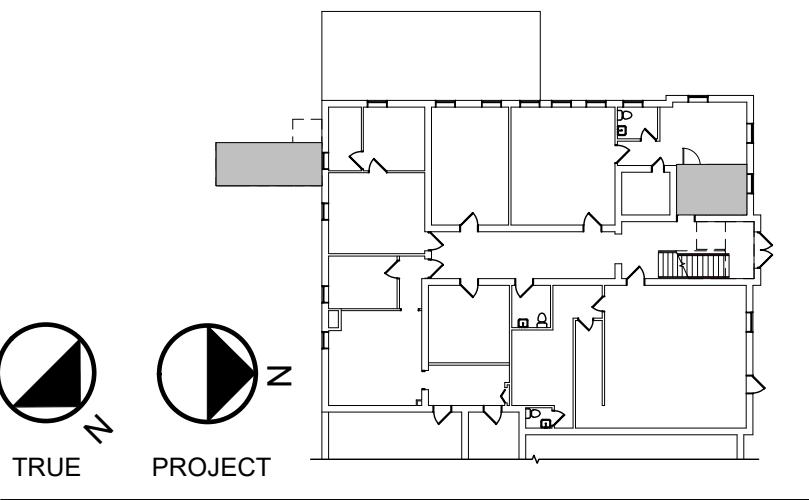
Drawing Title  
STAIR PLANS, SECTION & DETAILS

Drawing Number

A5-02



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## PERRY VILLAGE HALL ADA IMPROVEMENTS

VILLAGE OF PERRY  
46 N. MAIN ST.  
PERRY, NY 14530

100% CONSTRUCTION  
DOCUMENT BID SET

NOTES & REVISIONS:

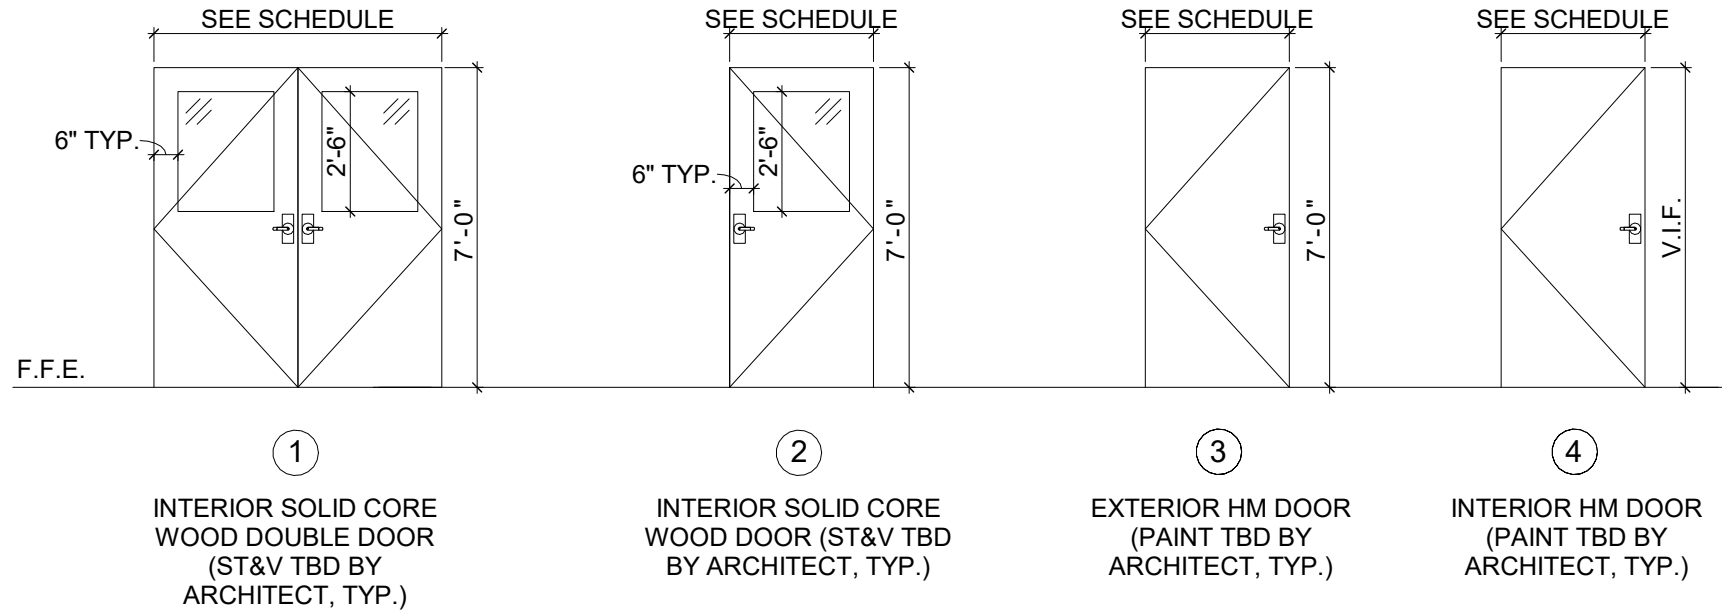
Revision Schedule		
Revision Number	Date	Description

DRAWING ISSUED:	APRIL 5, 2021
Project Number:	Scale:
00370	1/4" = 1'-0"
Drawn By:	Checked By:
MB	MM, LM

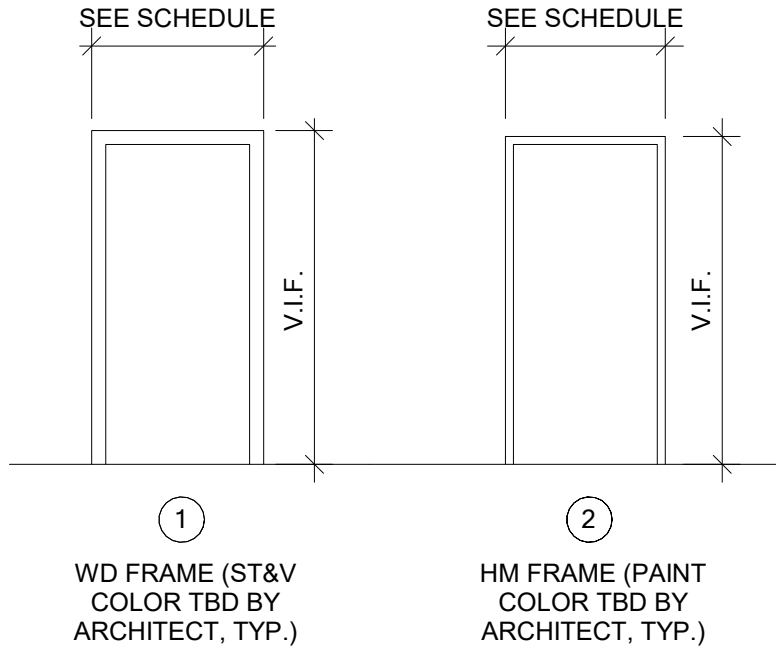
Drawing Title  
INTERIOR ELEVATIONS

Drawing Number  
**A5-03**

DOOR SCHEDULE													
Mark	Door Type	Door Width	Door Height	Door Thickness	Door Material	Door Finish	Hardware Type	Door Fire Rating	Frame Type	Frame Material	Frame Finish	Frame Fire Rating	Comments
ALT 200	EXISTING	(2) 36"±	84"±	--	EXISTING	PNT		45 MIN	EXISTING	EXISTING	PNT	45 MIN	EXISTING DOOR TO REMAIN, MODIFY AS REQUIRED FOR FIRE RATING
ALT 200A	2	36"	84"	1 3/4"	WD	ST&V		45 MIN	2	HM	PNT	45 MIN	
ALT 200B	4	36"±	84"±	1 3/4"	HM	PNT		90 MIN	2	HM	PNT	90 MIN	
100	EXISTING	36"±	84"±	--	WD	EXISTING		--	1	WD	ST&V	--	LOCKABLE FROM CLERK SIDE, REUSE EXISTING DOOR & FRAME FROM EXISTING VILLAGE CLERK OFFICE
100A	--	36"	84"	--	--	--		--	1	WD	ST&V	--	NEW WD CASING AT EXISTING OPENING, STAIN TO MATCH EXISTING
200	1	72"	84"	2 1/4"	WD	ST&V		45 MIN	2	HM	PNT	45 MIN	PANIC HARDWARE, LOCKED FROM EXTERIOR, W/ GLASS LITE
200B	4	36"±	84"±	1 3/4"	HM	PNT		90 MIN	2	HM	PNT	90 MIN	LOCKABLE FROM LOBBY/STAIR SIDE W/ KEYPAD
203	3	36"	84"	1 3/4"	HM	PNT		--	2	HM	PNT	--	EXTERIOR DOOR, PANIC HARDWARE
204	EXISTING	36"±	84"±	--	WD	EXISTING	EXISTING	--	EXISTING	EXISTING	EXISTING	--	REINSTALL EXISTING DOOR AFTER CONSTRUCTION IS COMPLETE

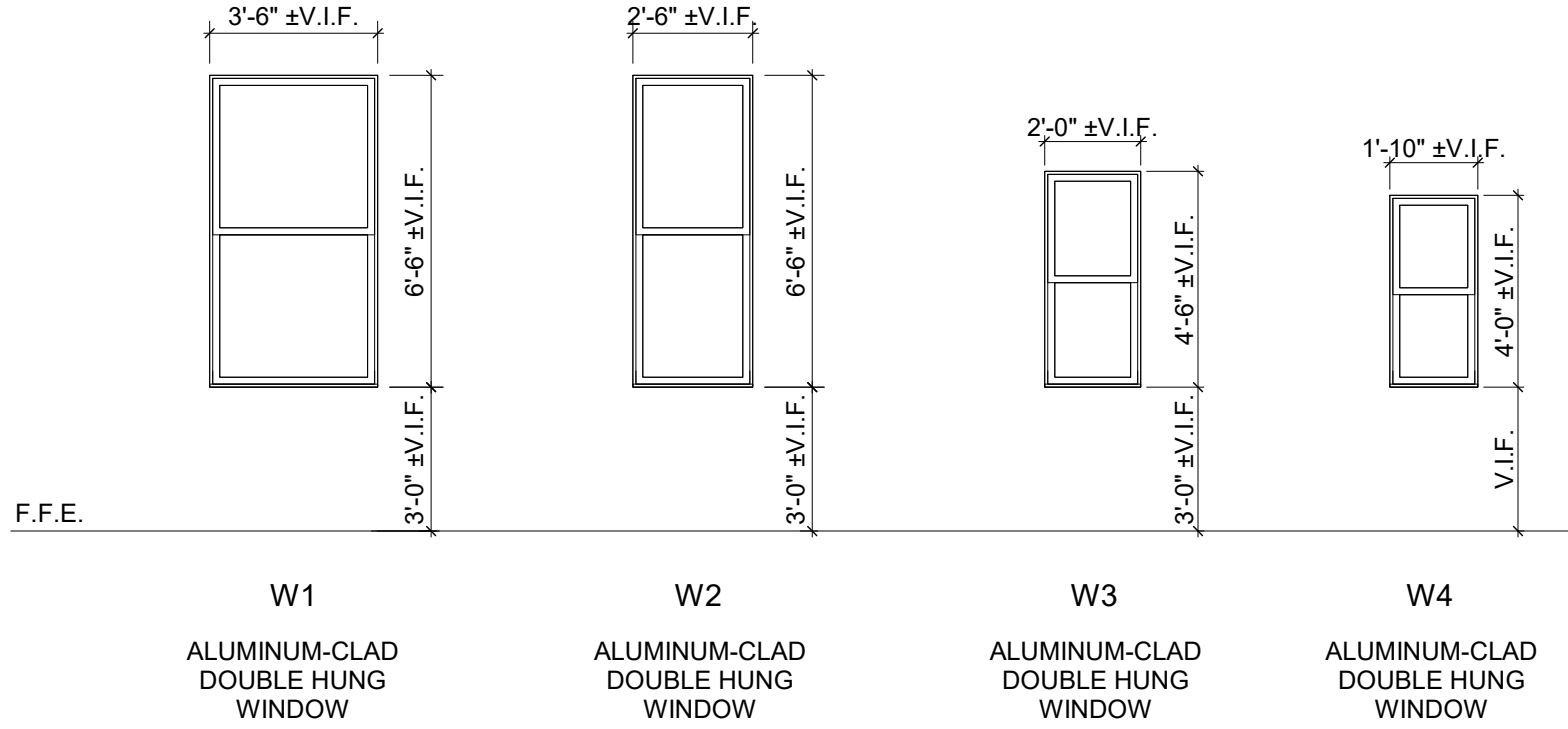


1 DOOR TYPES  
1/4" = 1'-0"



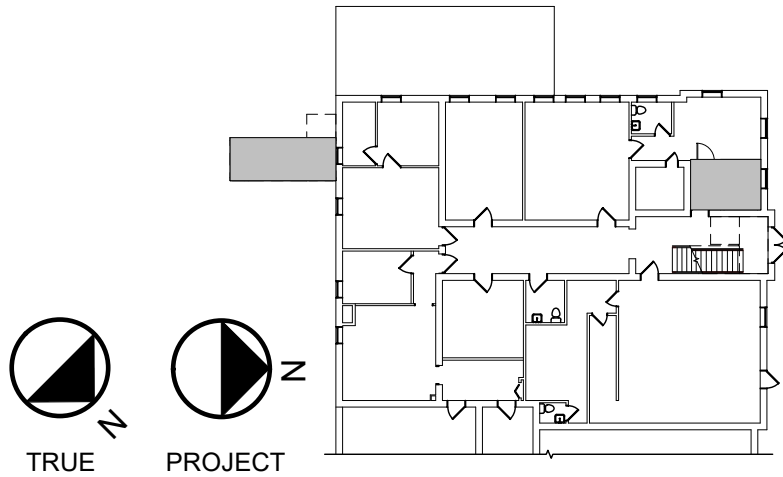
2 DOOR FRAME TYPES  
1/4" = 1'-0"

WINDOW SCHEDULE					
Type Mark	Size W x H	Material	Section #	Remarks	Sill Height
W1	3'-6" X 6'-6"± V.I.F.	ALUM-CLAD		EXISTING TRANSOM WINDOW ABOVE TO REMAIN, PROTECT DURING CONSTRUCTION	3'-0"± V.I.F.
W2	2'-6" X 6'-6"± V.I.F.	ALUM-CLAD			3'-0"± V.I.F.
W3	2'-0" X 4'-6"± V.I.F.	ALUM-CLAD			3'-0"± V.I.F.
W4	1'-10" X 4'-0"± V.I.F.	ALUM-CLAD			V.I.F.



3 WINDOW TYPES  
1/4" = 1'-0"

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## PERRY VILLAGE HALL ADA IMPROVEMENTS

VILLAGE OF PERRY  
46 N. MAIN ST.  
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100% CONSTRUCTION  
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NOTES & REVISIONS:

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Revision Number	Date	Description

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Project Number: 00370 Scale: 1/4" = 1'-0"

Drawn By: MB Checked By: MM, LM

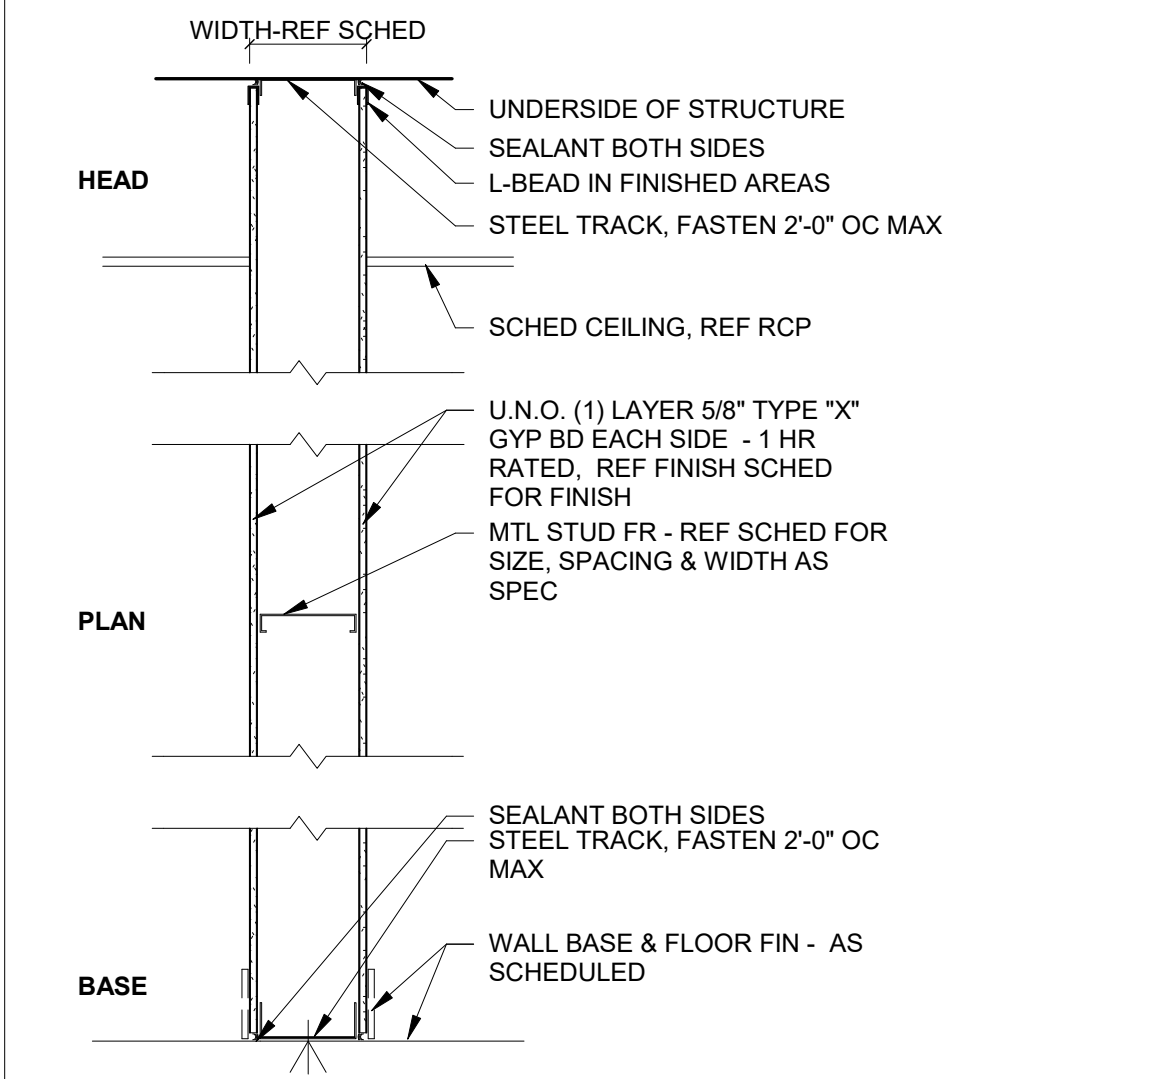
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WINDOW & DOOR SCHEDULES,  
TYPES & DETAILS

Drawing Number

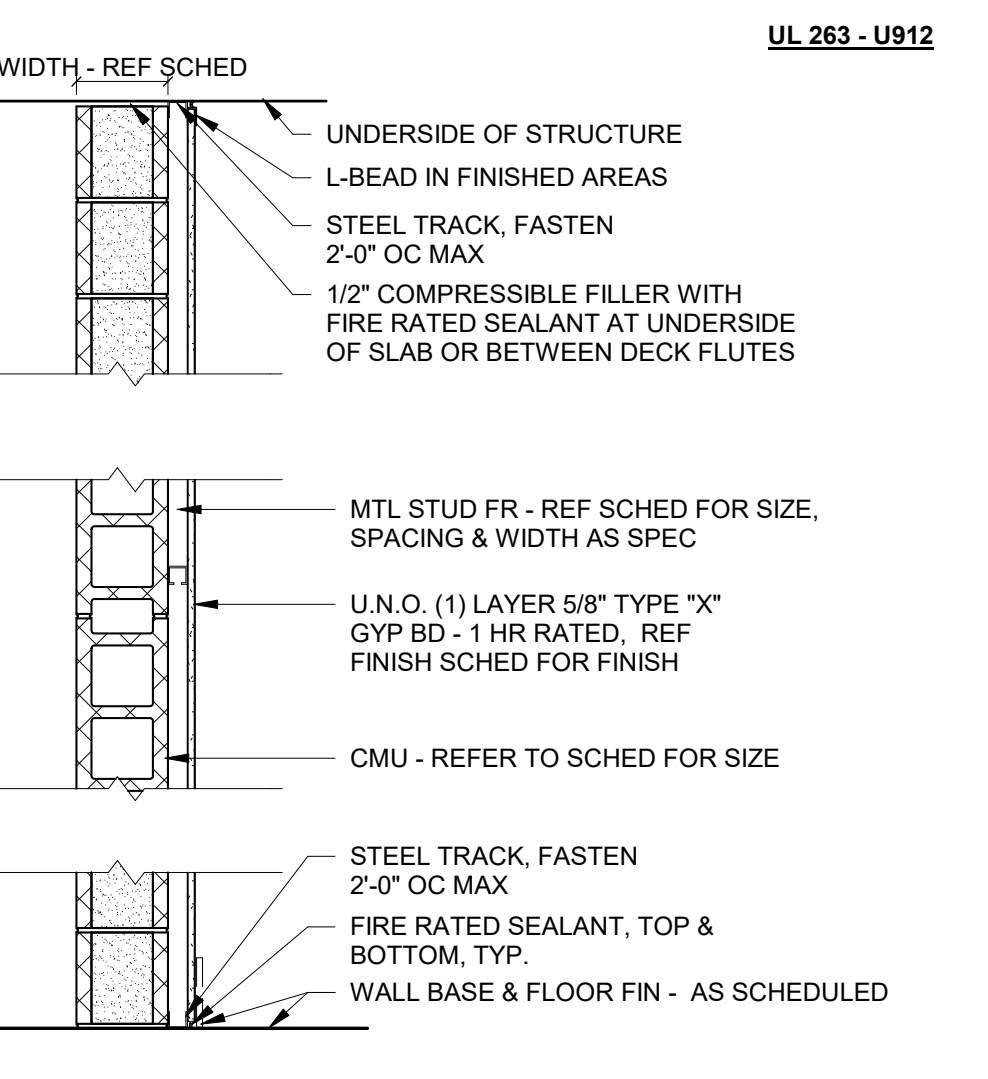
A6-01

TYPES 1 & 5 - FULL HEIGHT GWB PARTITION



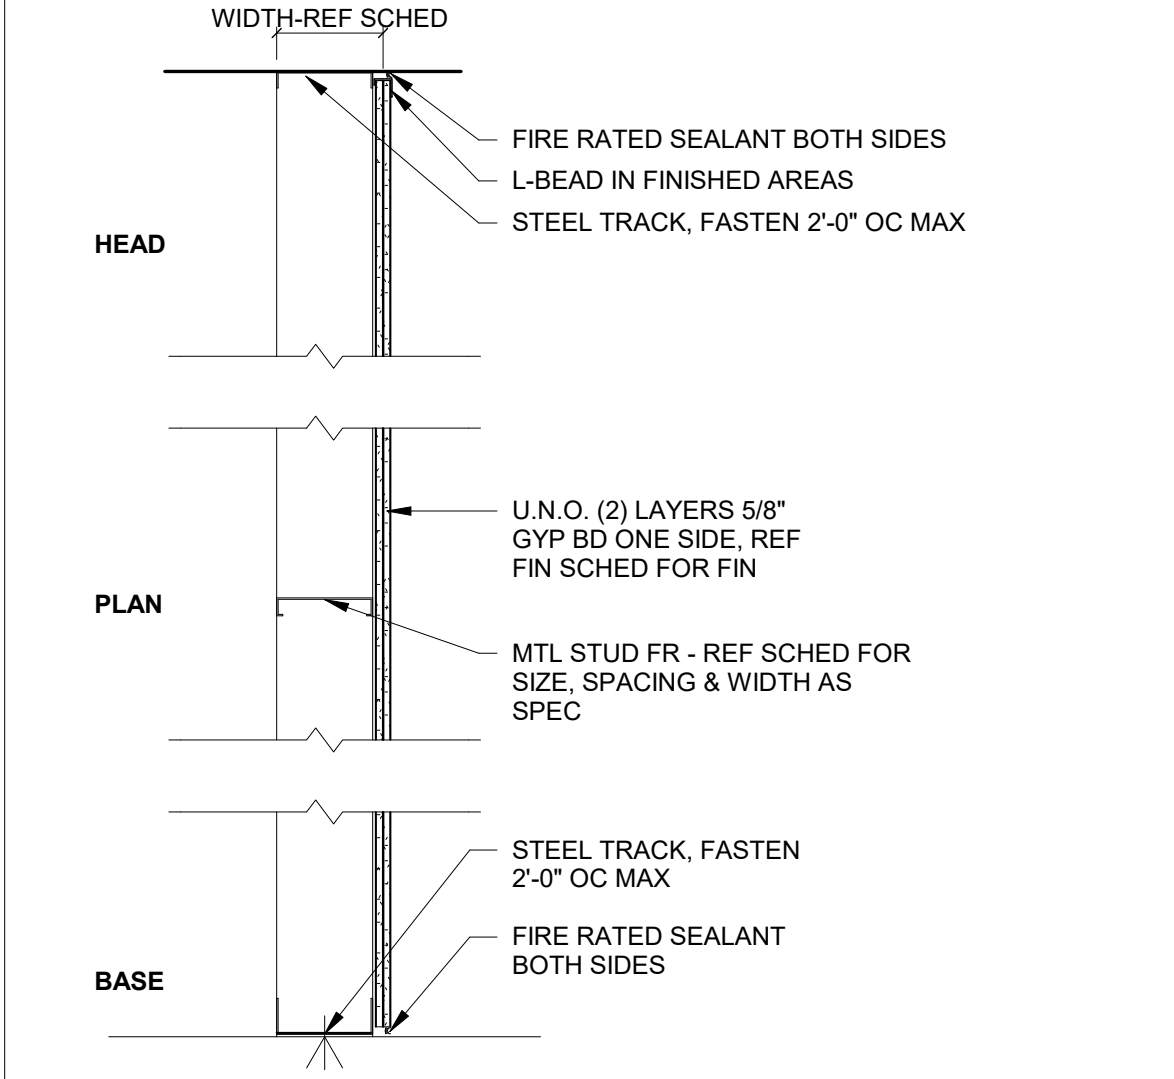
TYPE	WIDTH	INSULATION	FIRE RATING	COMMENTS
1	4 7/8"			

TYPE 2 - FULL HT. CMU WALL



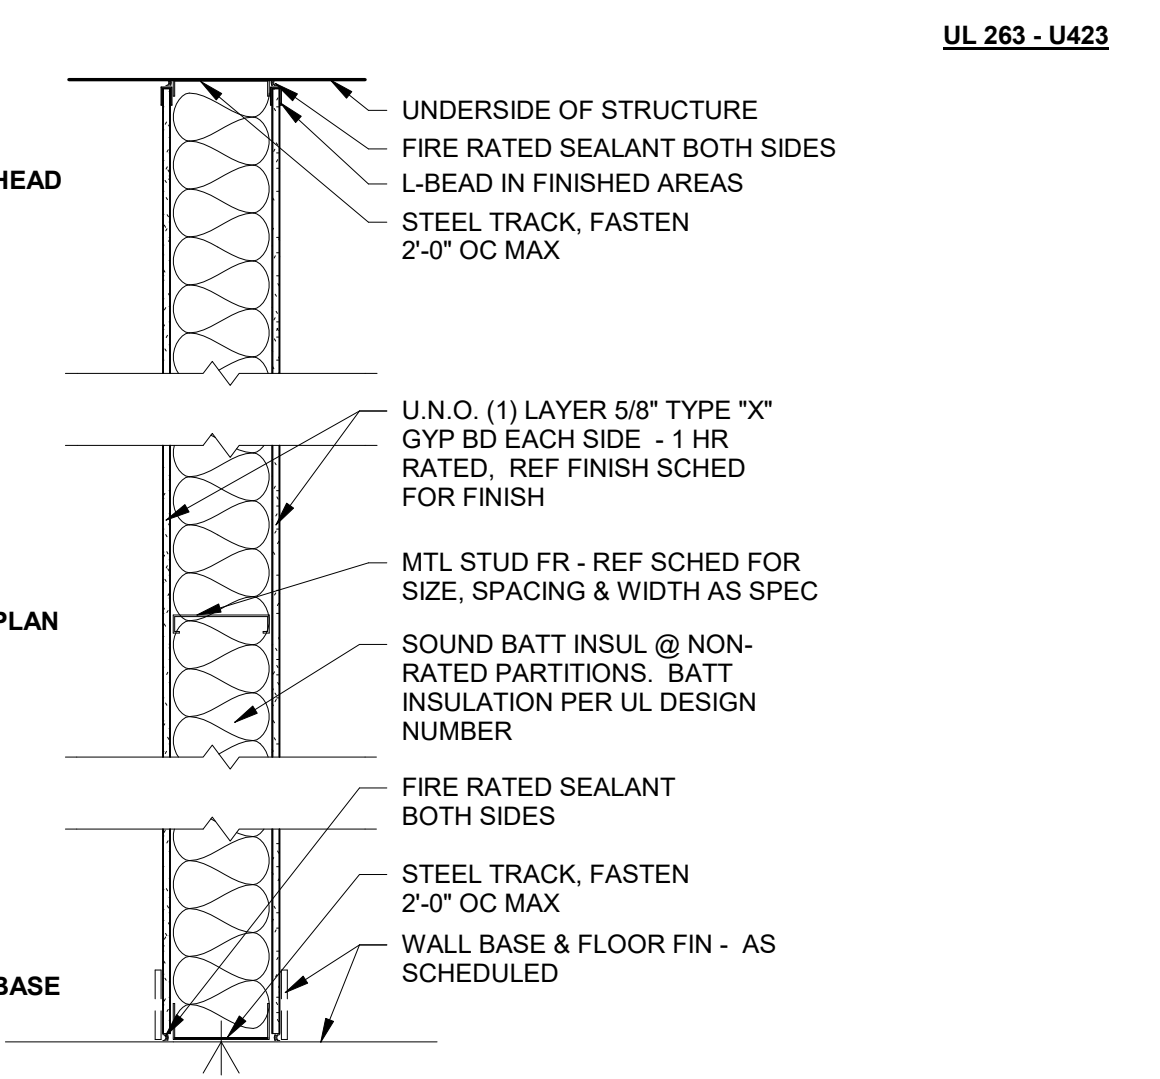
TYPE MARK	WIDTH	INSULATION	FIRE RATING	COMMENTS
2	9 7/8"		1 HR	FUR OUT W/ MTL STUDS & GWB AS SHOWN
2A	7 5/8"		1 HR	CMU BLOCK ONLY

TYPE 3 - SINGLE SIDED PARTITION



TYPE	WIDTH	INSULATION	FIRE RATING	COMMENTS
3	3 3/4"			

TYPES 4 & 5 - 1 HR RATED GWB PARTITION

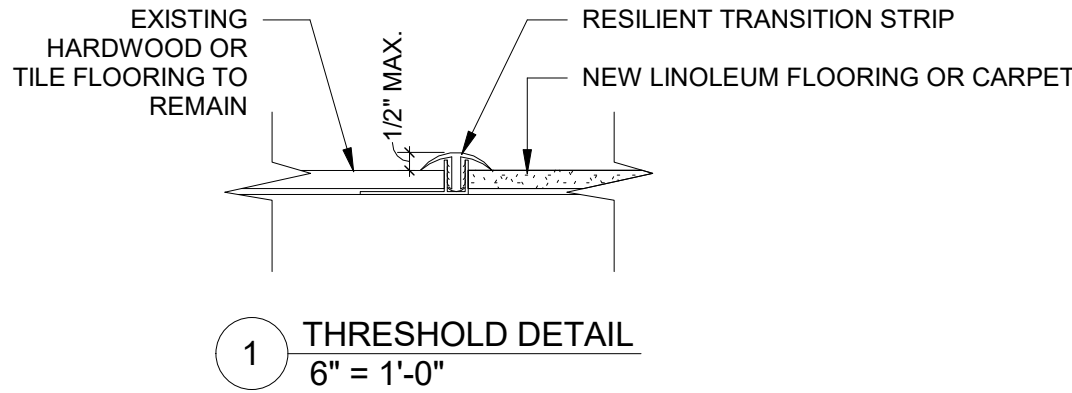


TYPE	WIDTH	INSULATION	FIRE RATING	COMMENTS
4	4 7/8"	Yes	1 HR	MIN. STC RATING 45
5	6"	Yes	1 HR	MATCH EXISTING WALL WIDTH

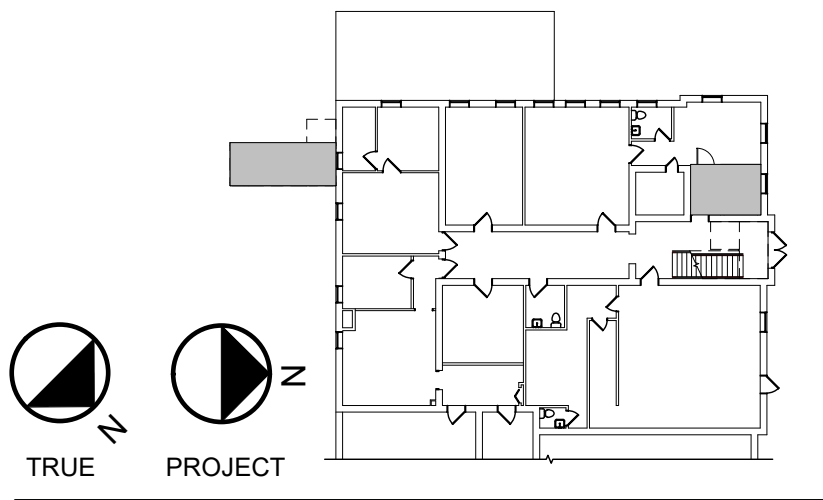
ROOM FINISH SCHEDULE						
NUMBER	ROOM	FLOOR	BASE	WALL	CEILING	Comments
G101	EXISTING BREAK ROOM	EXISTING CONCRETE	--	--	--	
100	NEW ELEV. LOBBY	EXISTING TILE	WD	EXISTING/PNT-1	EXISTING/PNT-2	
102	EXISTING VILLAGE CLERK OFFICE	EXISTING TILE	EXIST. WD	GWB/PNT-1	EXISTING/PNT-2	3
200	NEW ELEVATOR LOBBY	LINO-1	WD	PNT-1	PNT-2	
200A	NEW COAT CLOSET	EXIST. HARDWOOD	WD	GWB/PNT-1	GWB/PNT-2	
201	EXISTING ASSEMBLY HALL	EXISTING HARDWOOD	EXIST. WD	GWB/PNT-1	EXISTING	
202	EXISTING STORAGE	EXISTING CONCRETE	RB-1	GWB/PNT-1	EXISTING	1
204	EXISTING STAIR	LINO-1	WD	EXISTING/PNT-1	EXISTING/PNT-2	2

- ROOM FINISH SCHEDULE NOTES:
1. NEW GYPSUM WALL BOARD AT NEW WALL ADJACENT TO ELEVATOR SHAFT ONLY. PAINT ALL WALLS AND CEILING.
  2. PAINT WALLS AND CEILING SURROUNDING TOP LANDING ONLY
  3. RESTORE EXISTING MOSAIC TILE EXPOSED BY CARPET REMOVAL, SEE SPECIFIC NOTE #20/AD-02

ROOM FINISH KEY	
LINO-1	LINOLEUM FLOORING (SEE SPEC)
WD	WOOD
GWB/PNT	GYPSUM WALL BOARD PAINTED (SEE SPEC)
PNT	PAINT
RB-1	RUBBER BASE



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NOTES & REVISIONS:

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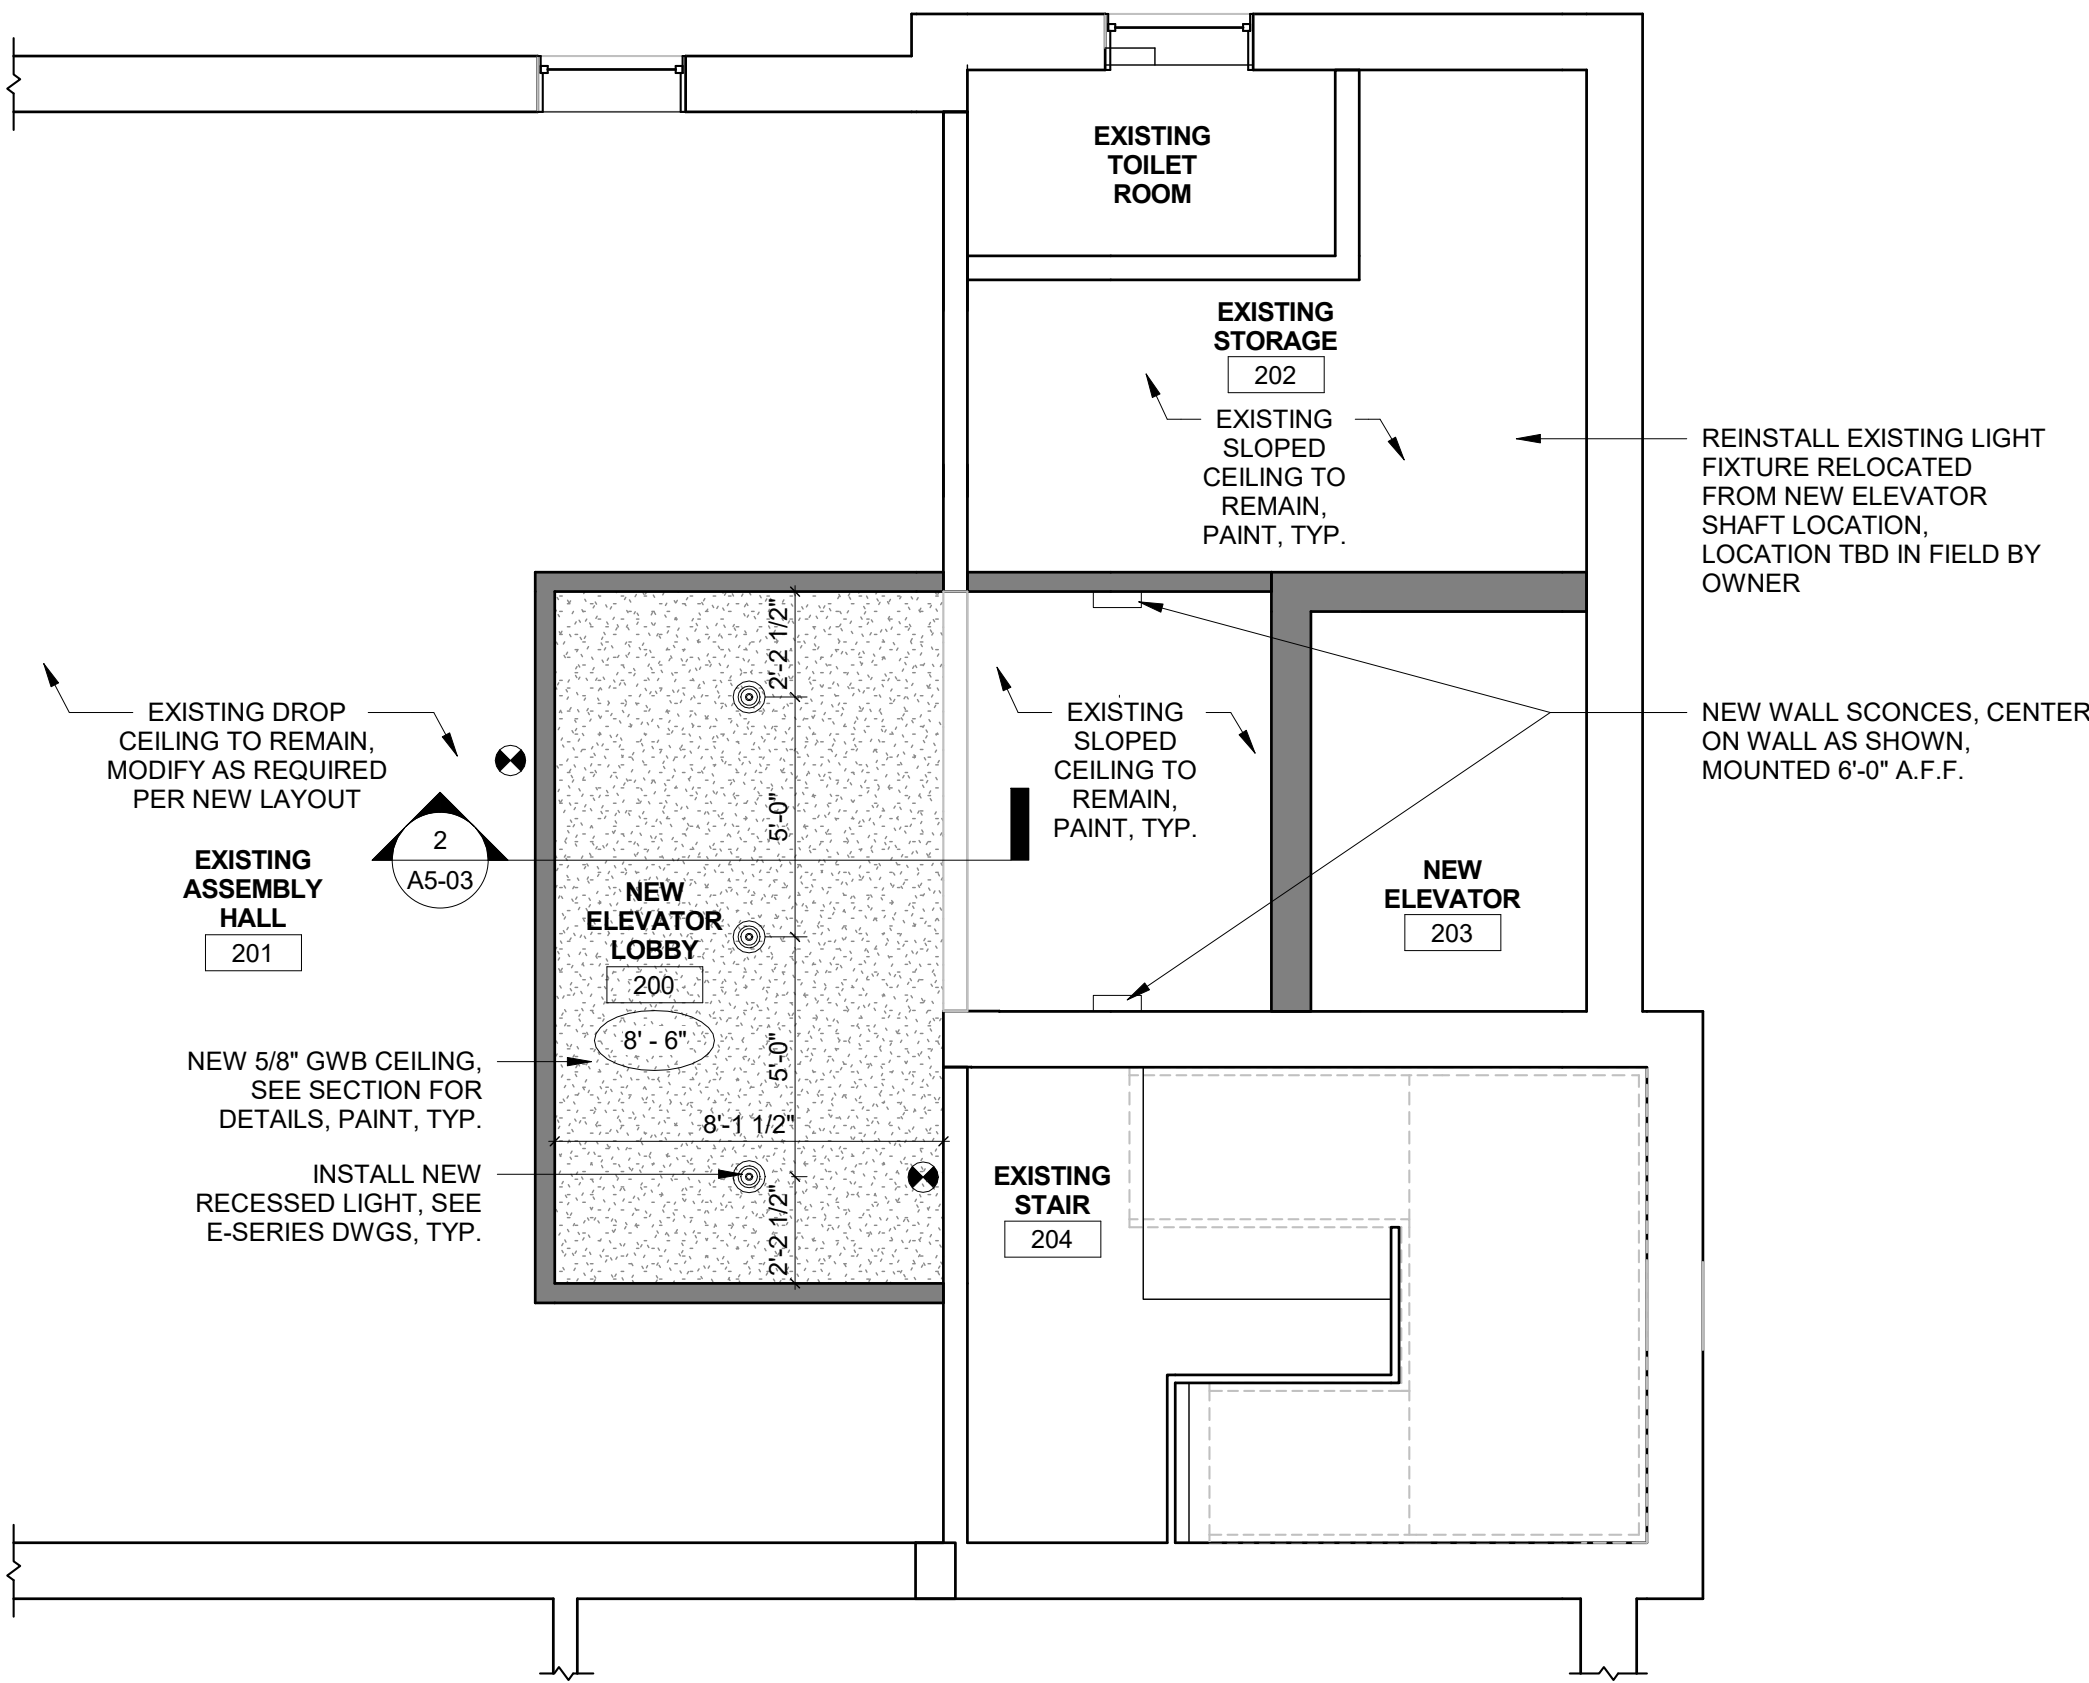
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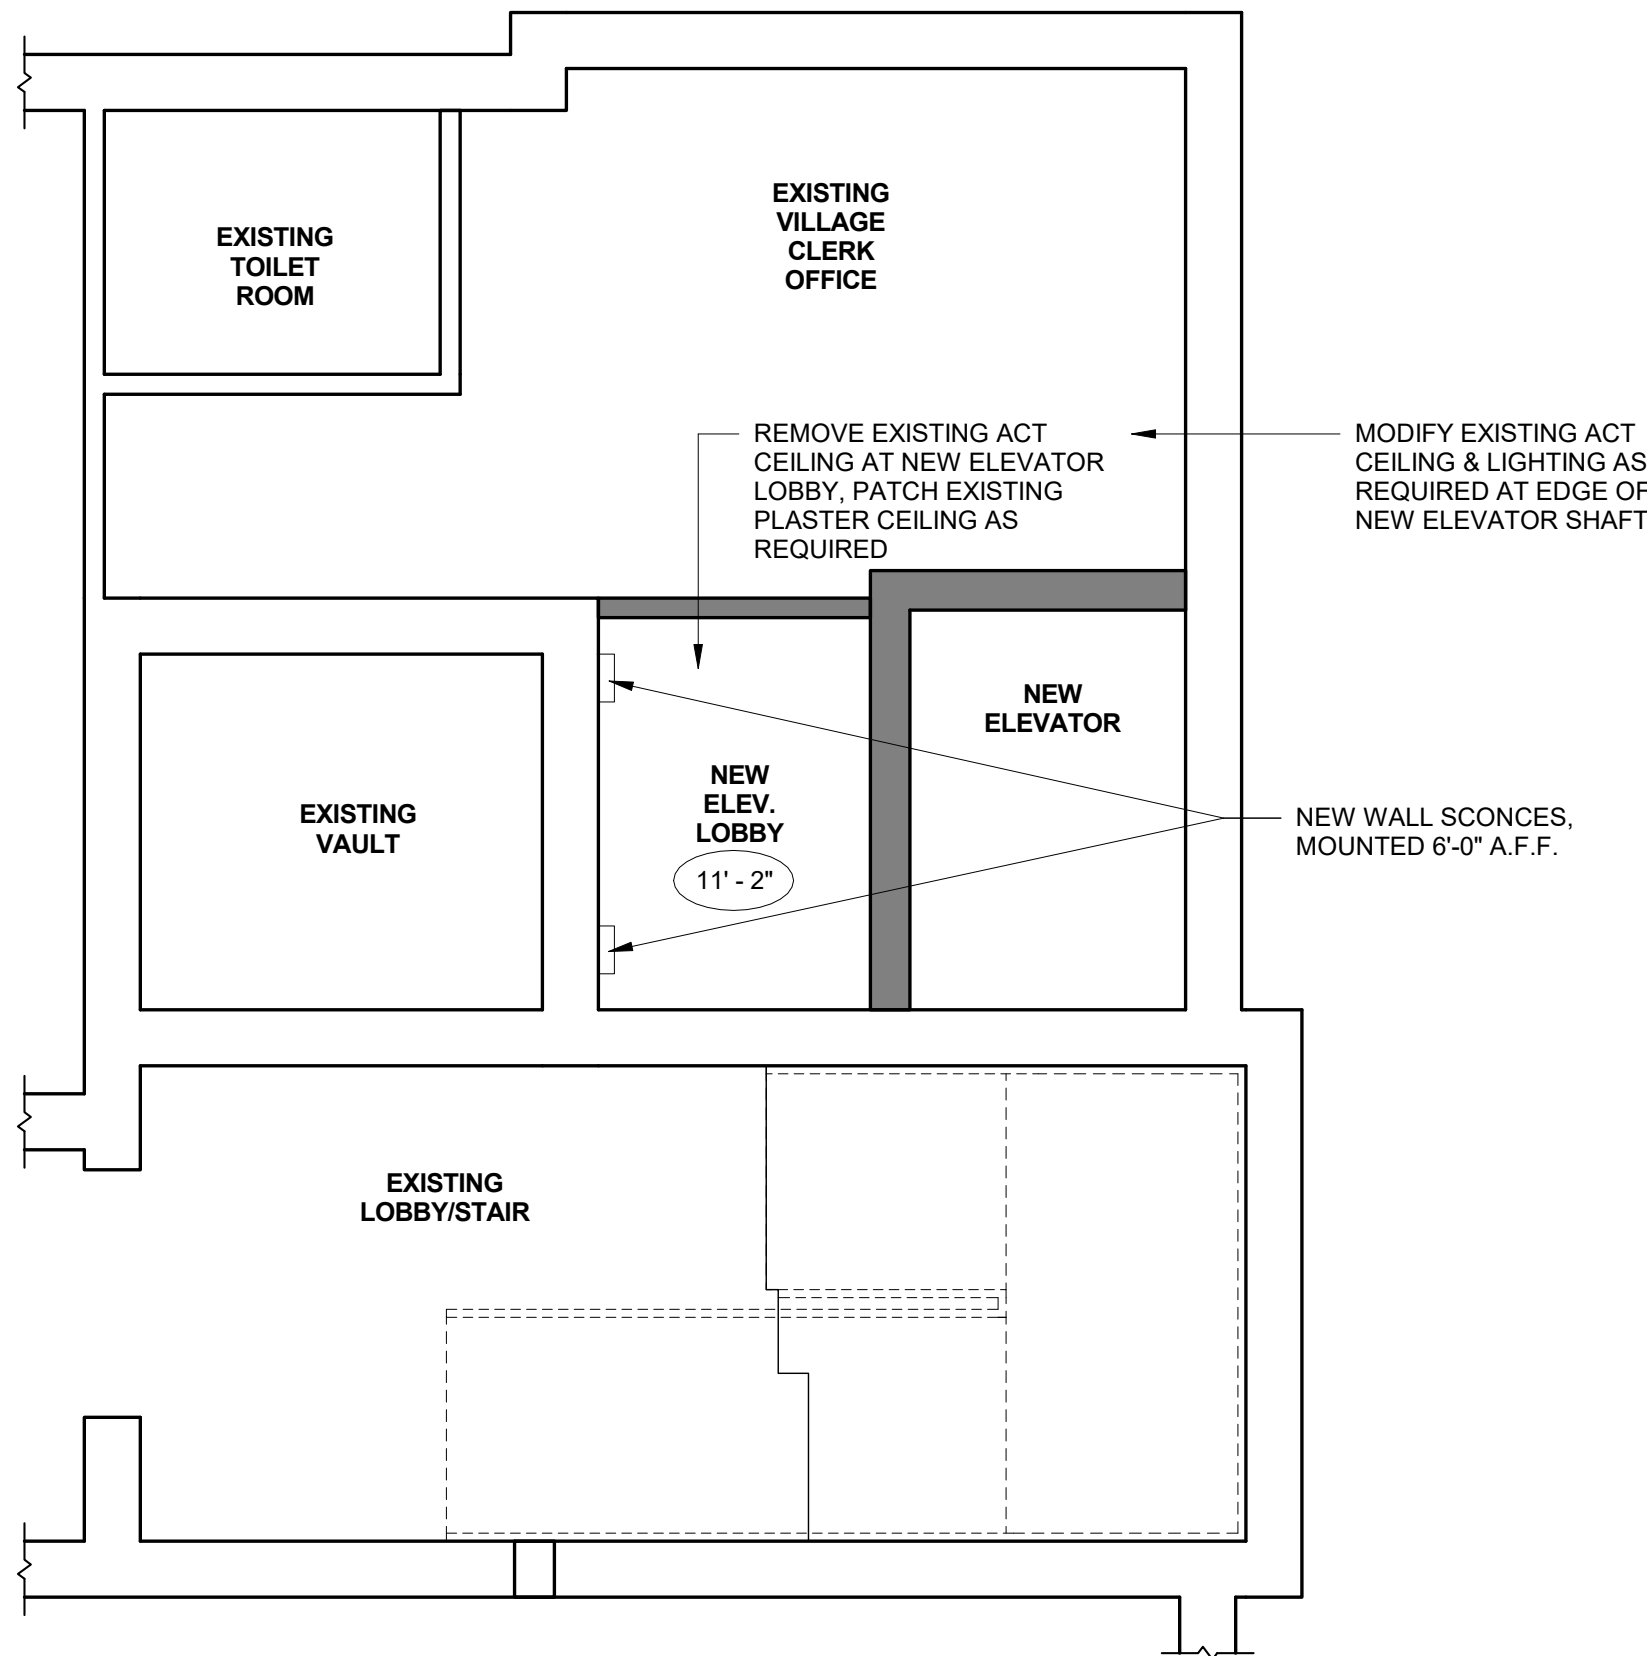
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PARTITION & FINISH SCHEDULES

Drawing Number

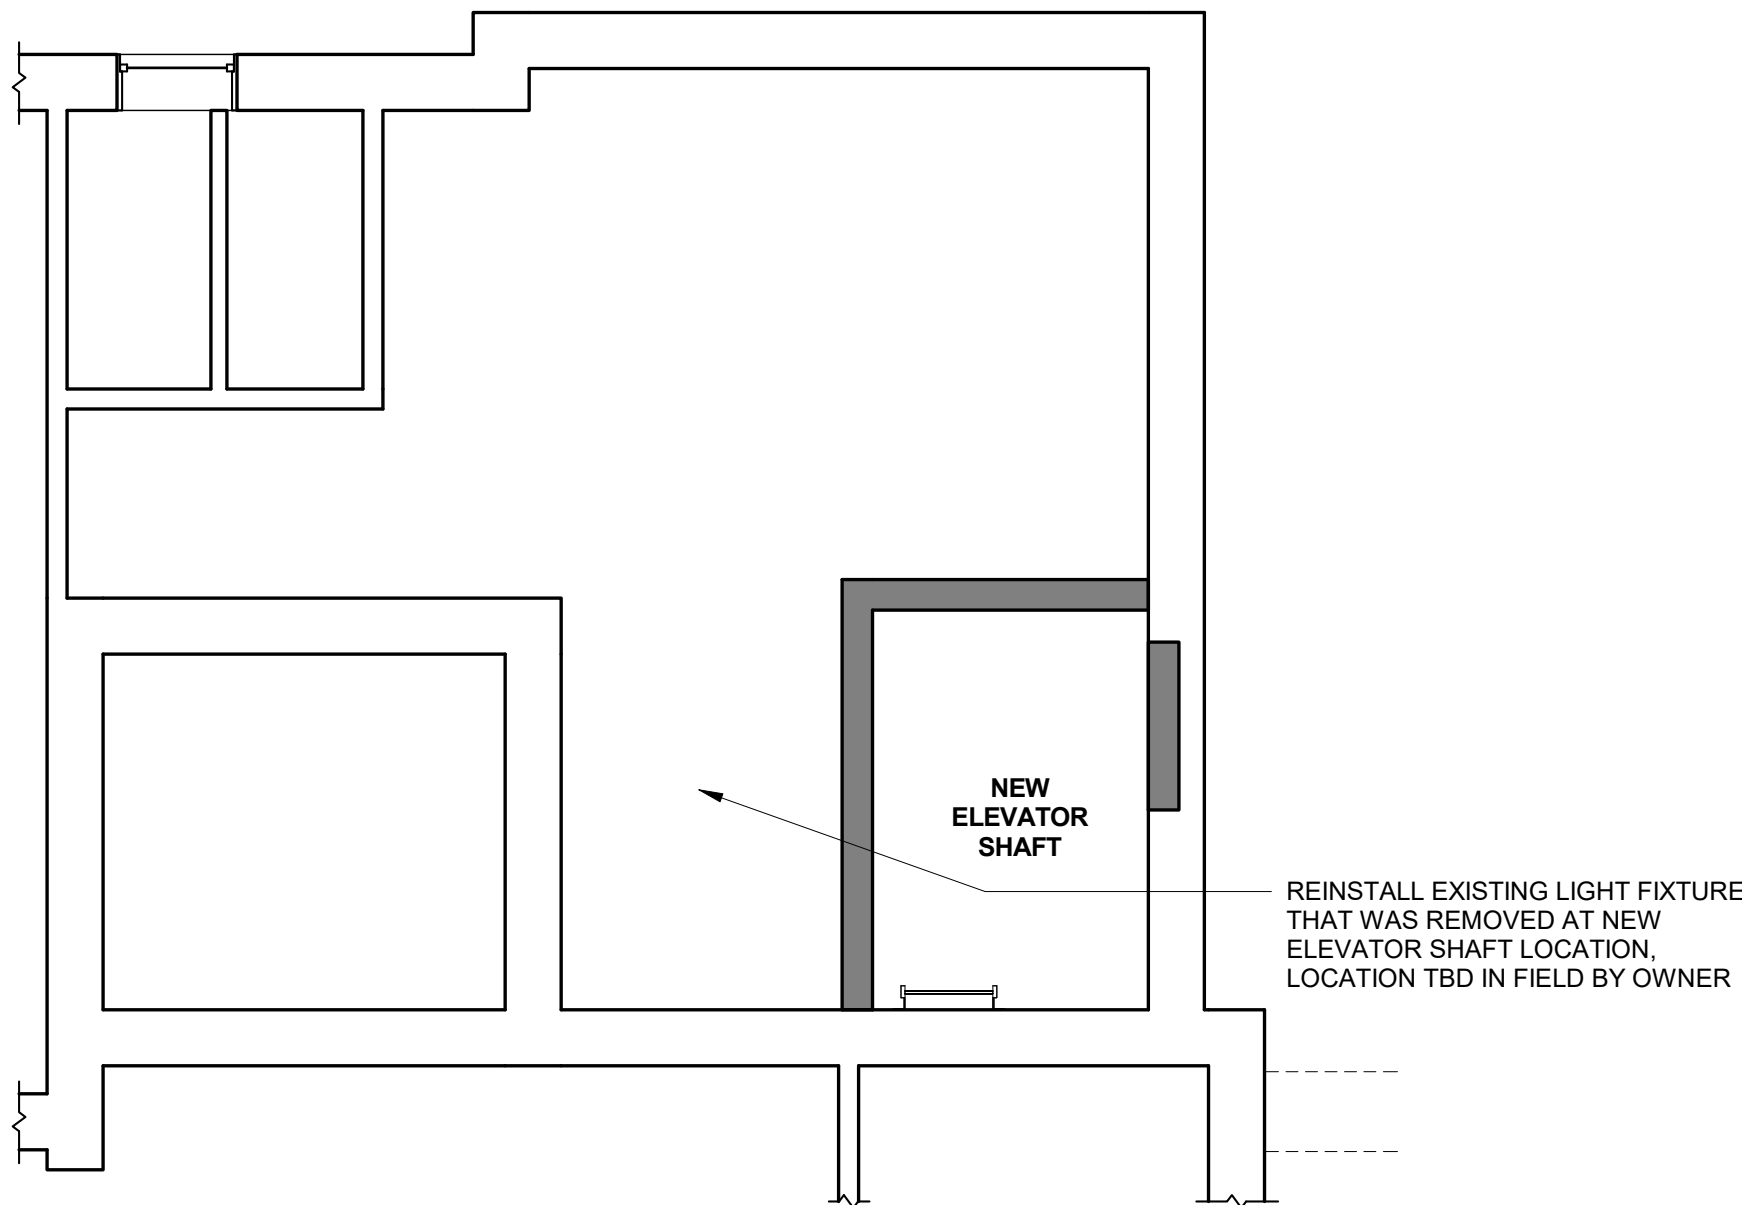
A6-02



1 PARTIAL SECOND FLOOR REFLECTED CEILING PLAN  
1/4" = 1'-0"



2 PARTIAL FIRST FLOOR REFLECTED CEILING PLAN  
1/4" = 1'-0"

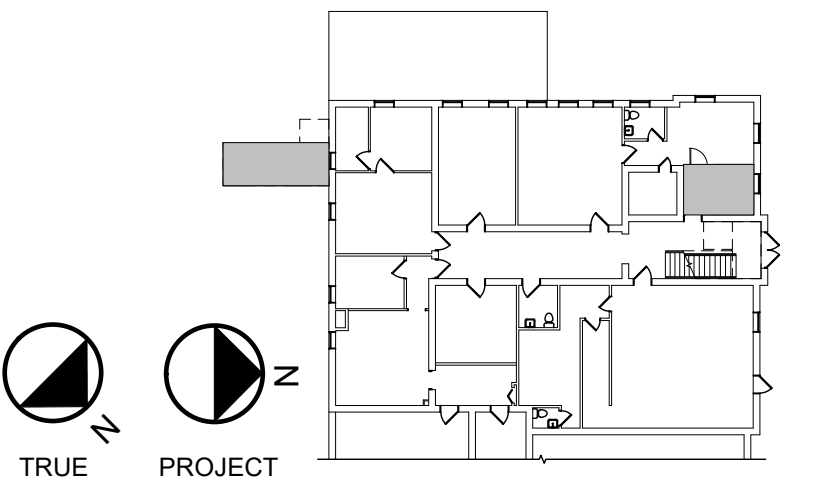


3 PARTIAL GROUND FLOOR REFLECTED CEILING PLAN  
1/4" = 1'-0"

LEGEND:

- CEILING EXHAUST FAN
- EXIT LIGHT
- EMERGENCY LIGHTING WALL PACK
- FIRE ALARM W/ STROBE LIGHT
- NEW CEILING

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PERRY VILLAGE HALL  
ADA IMPROVEMENTS

VILLAGE OF PERRY  
46 N. MAIN ST.  
PERRY, NY 14530

100% CONSTRUCTION  
DOCUMENT BID SET

NOTES & REVISIONS:

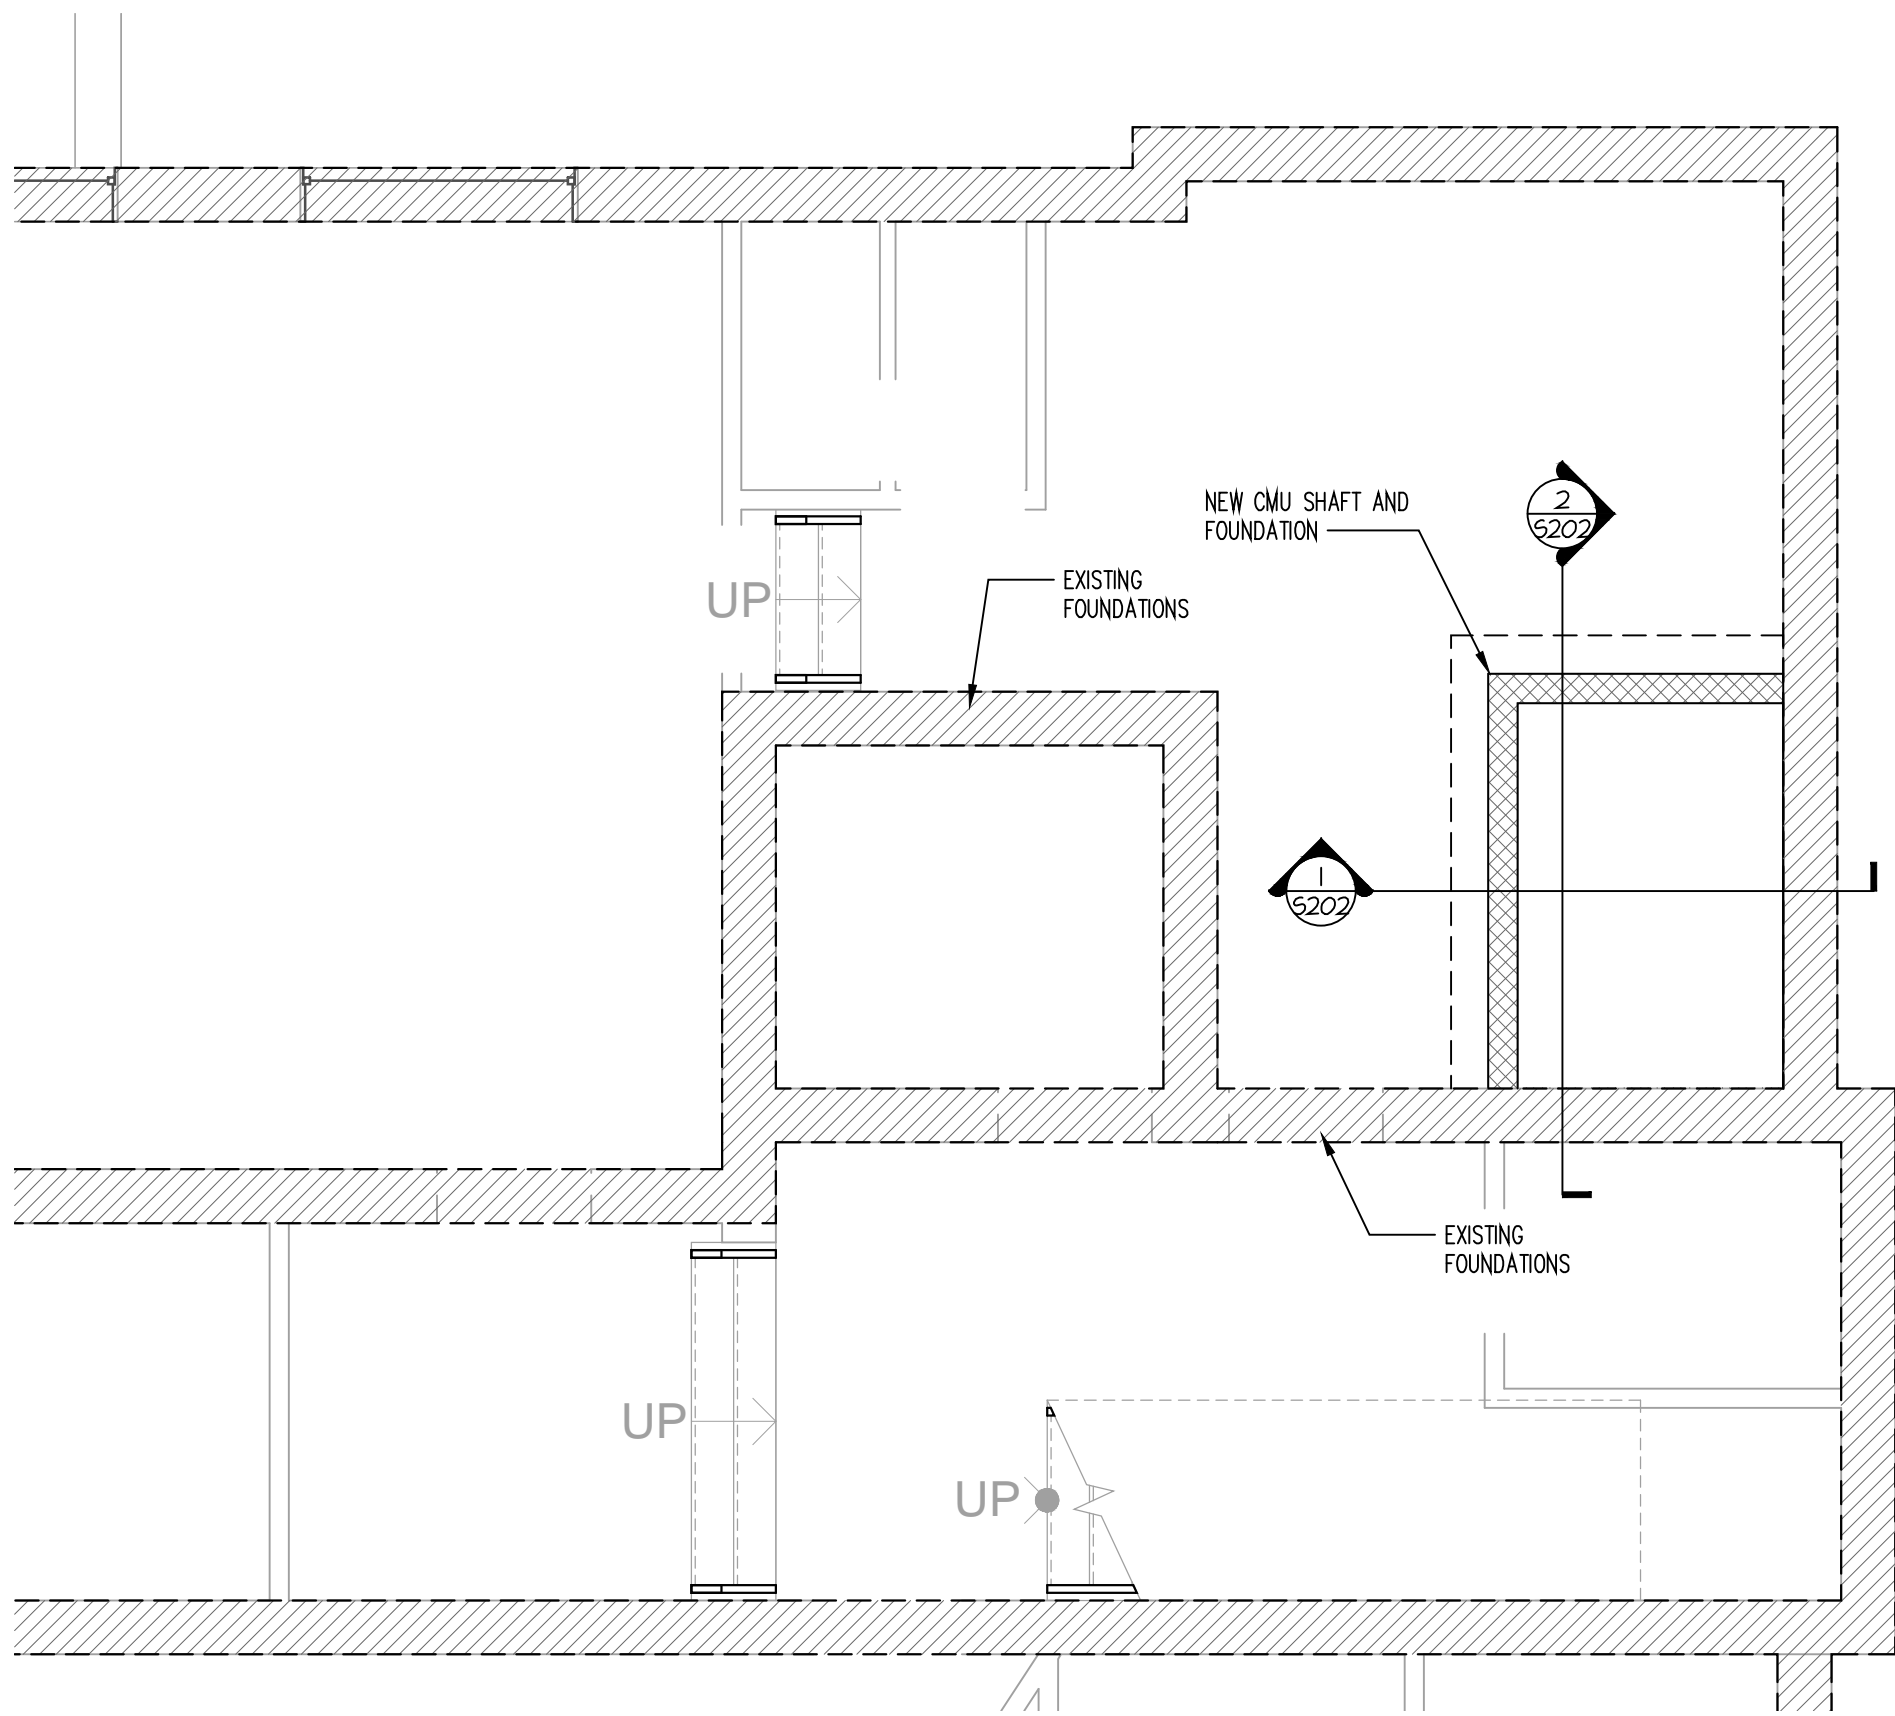
Revision Schedule		
Revision Number	Date	Description

DRAWING ISSUED:	APRIL 5, 2021
Project Number:	Scale:
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Drawn By:	Checked By:
MB	MM, LM

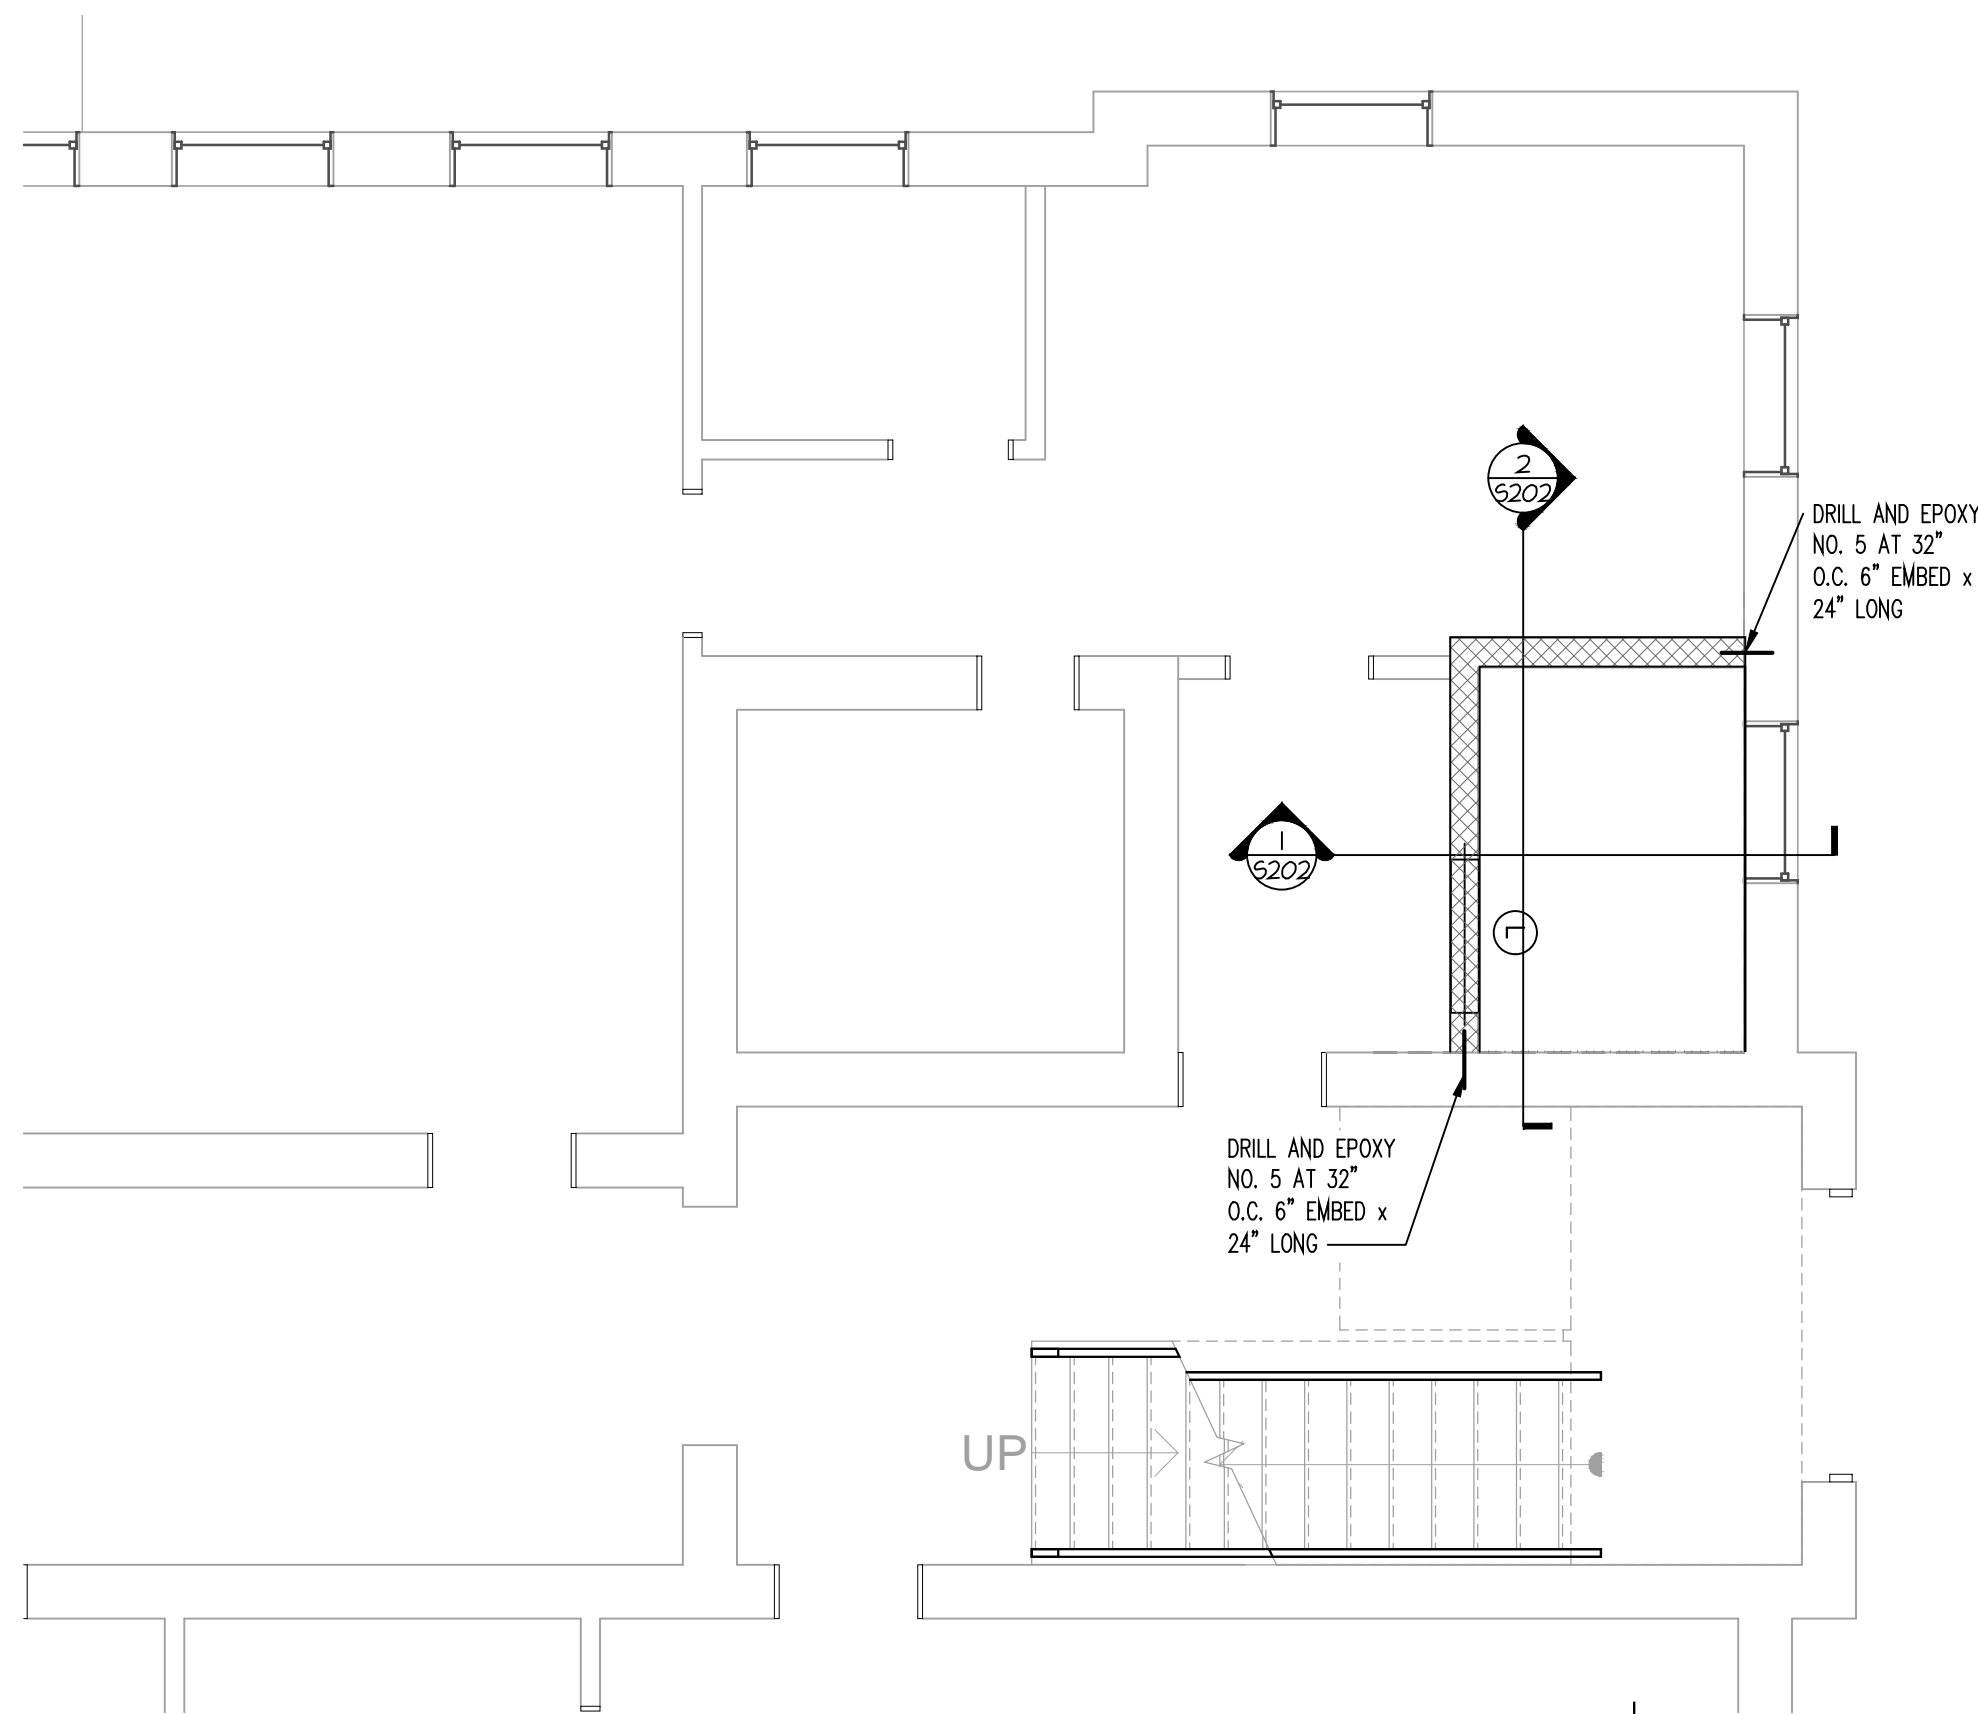
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REFLECTED CEILING PLANS

Drawing Number

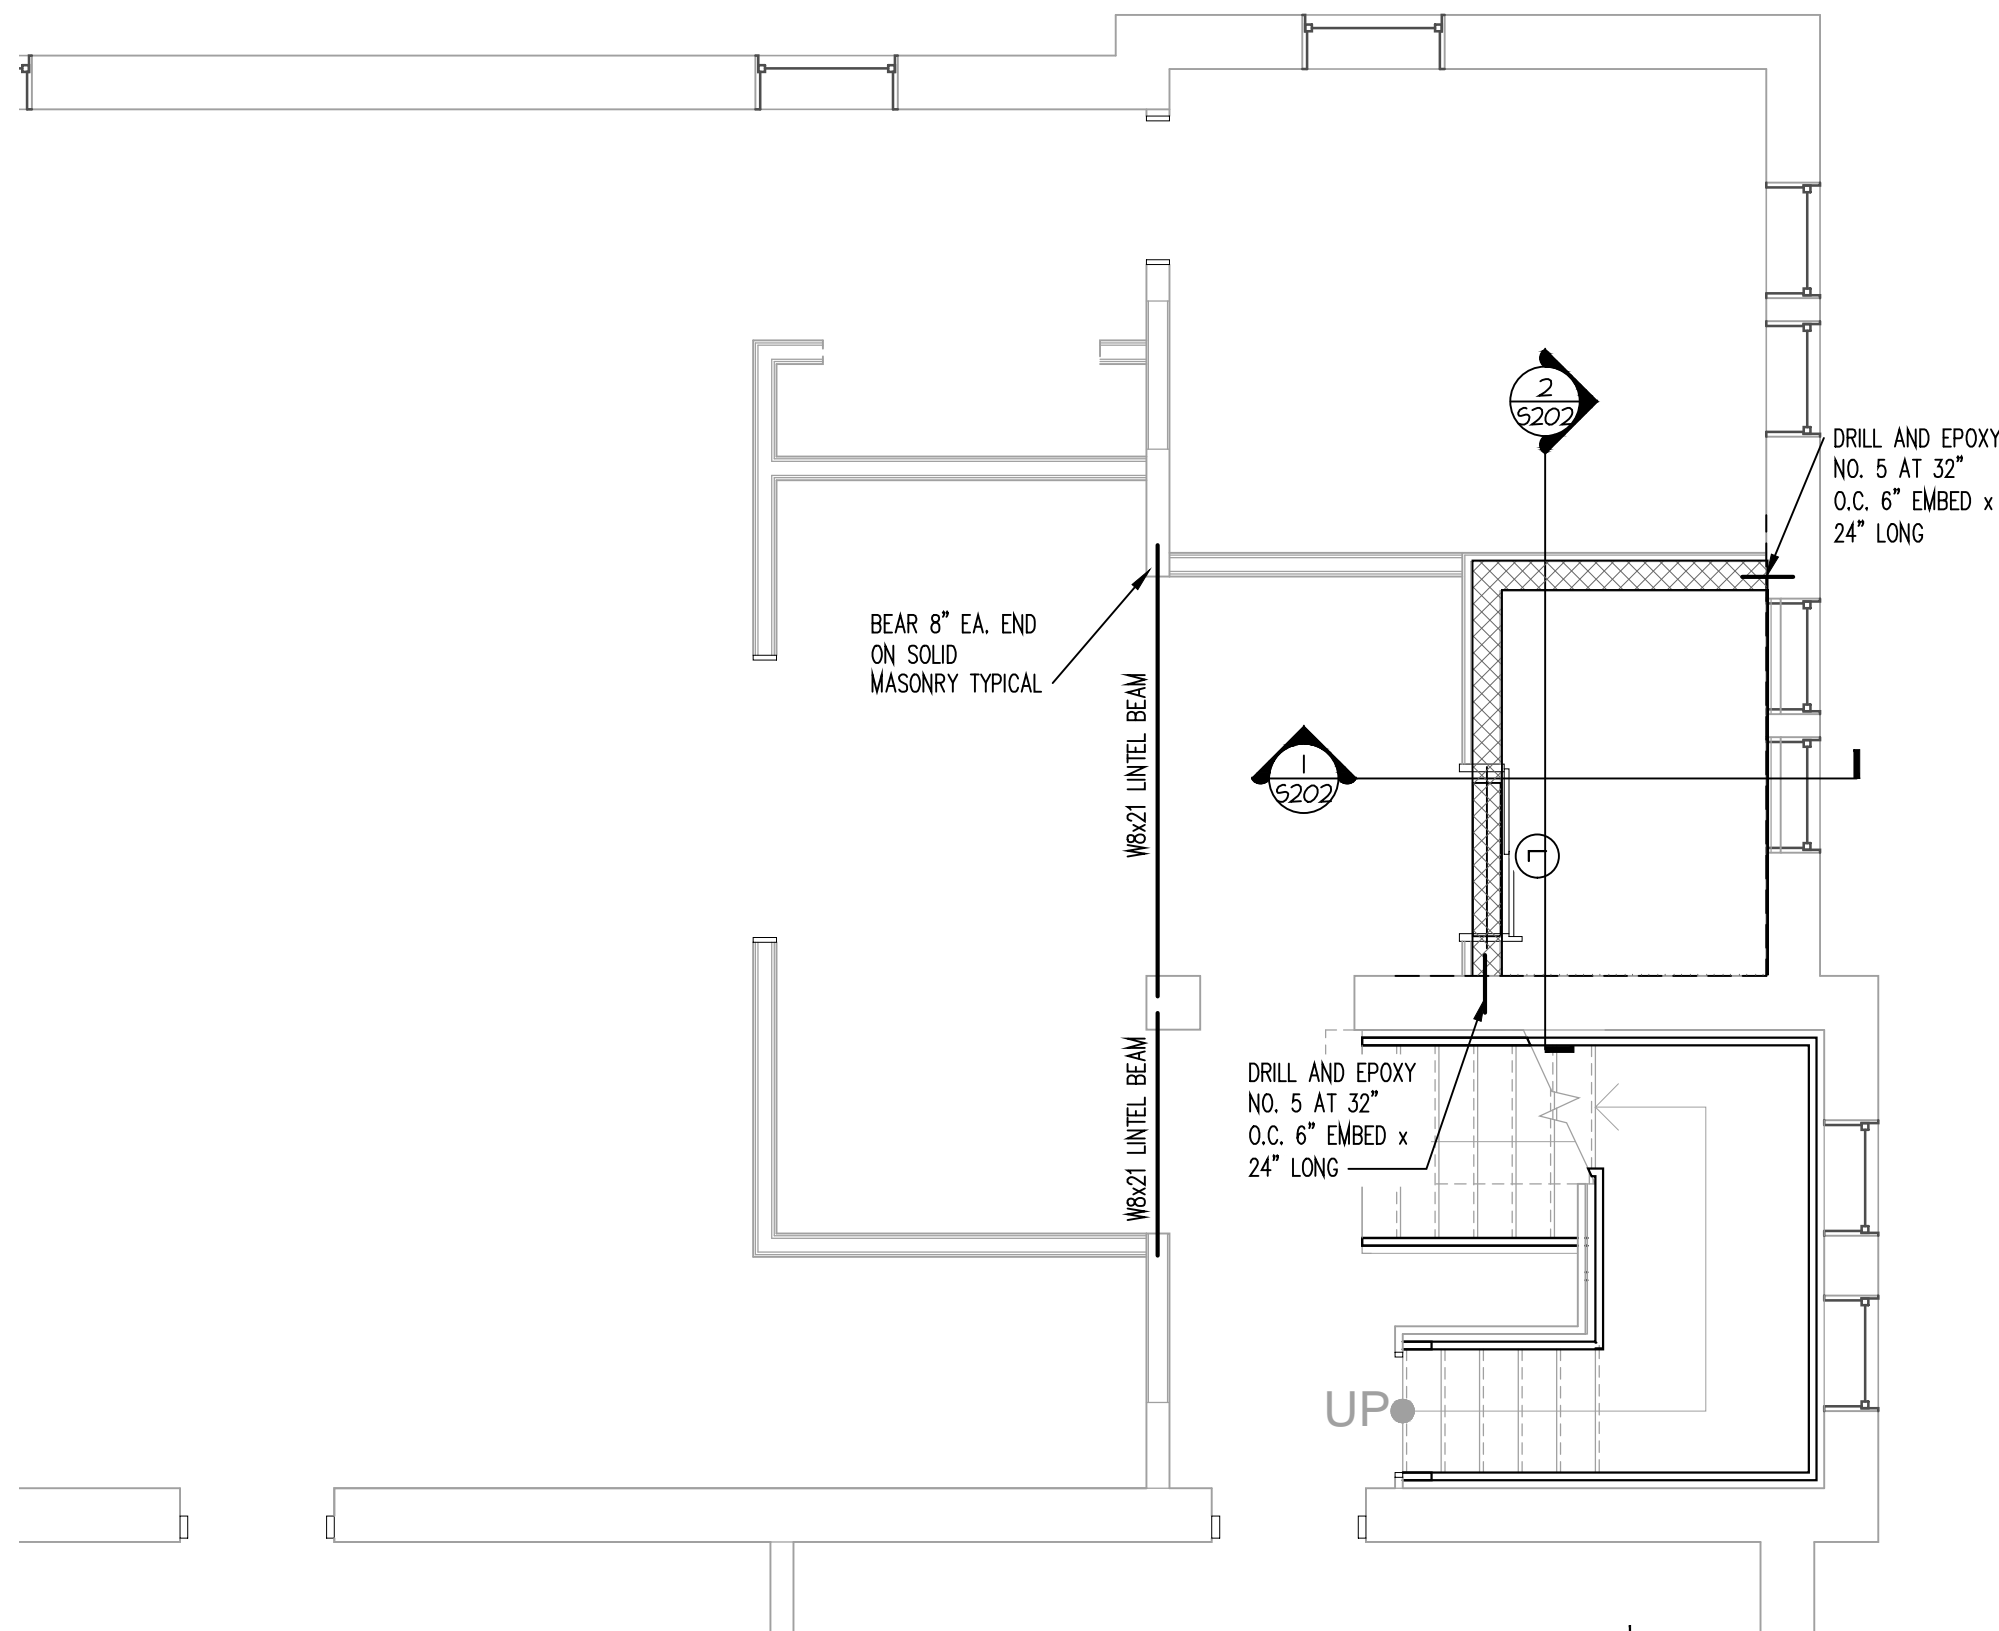
A7-01



1 BASEMENT FOUNDATION PLAN  
SCALE: 1/4" = 1'-0"

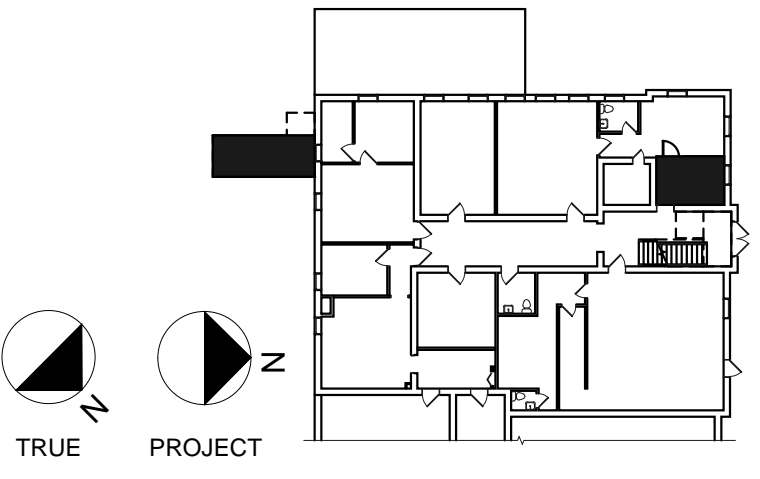


2 FIRST FLOOR FRAMING PLAN  
SCALE: 1/4" = 1'-0"



3 SECOND FLOOR FRAMING PLAN  
SCALE: 1/4" = 1'-0"

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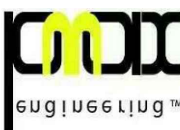
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## PERRY VILLAGE HALL ADA IMPROVEMENTS

VILLAGE OF PERRY  
46 N. MAIN ST.  
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NOTES & REVISIONS:

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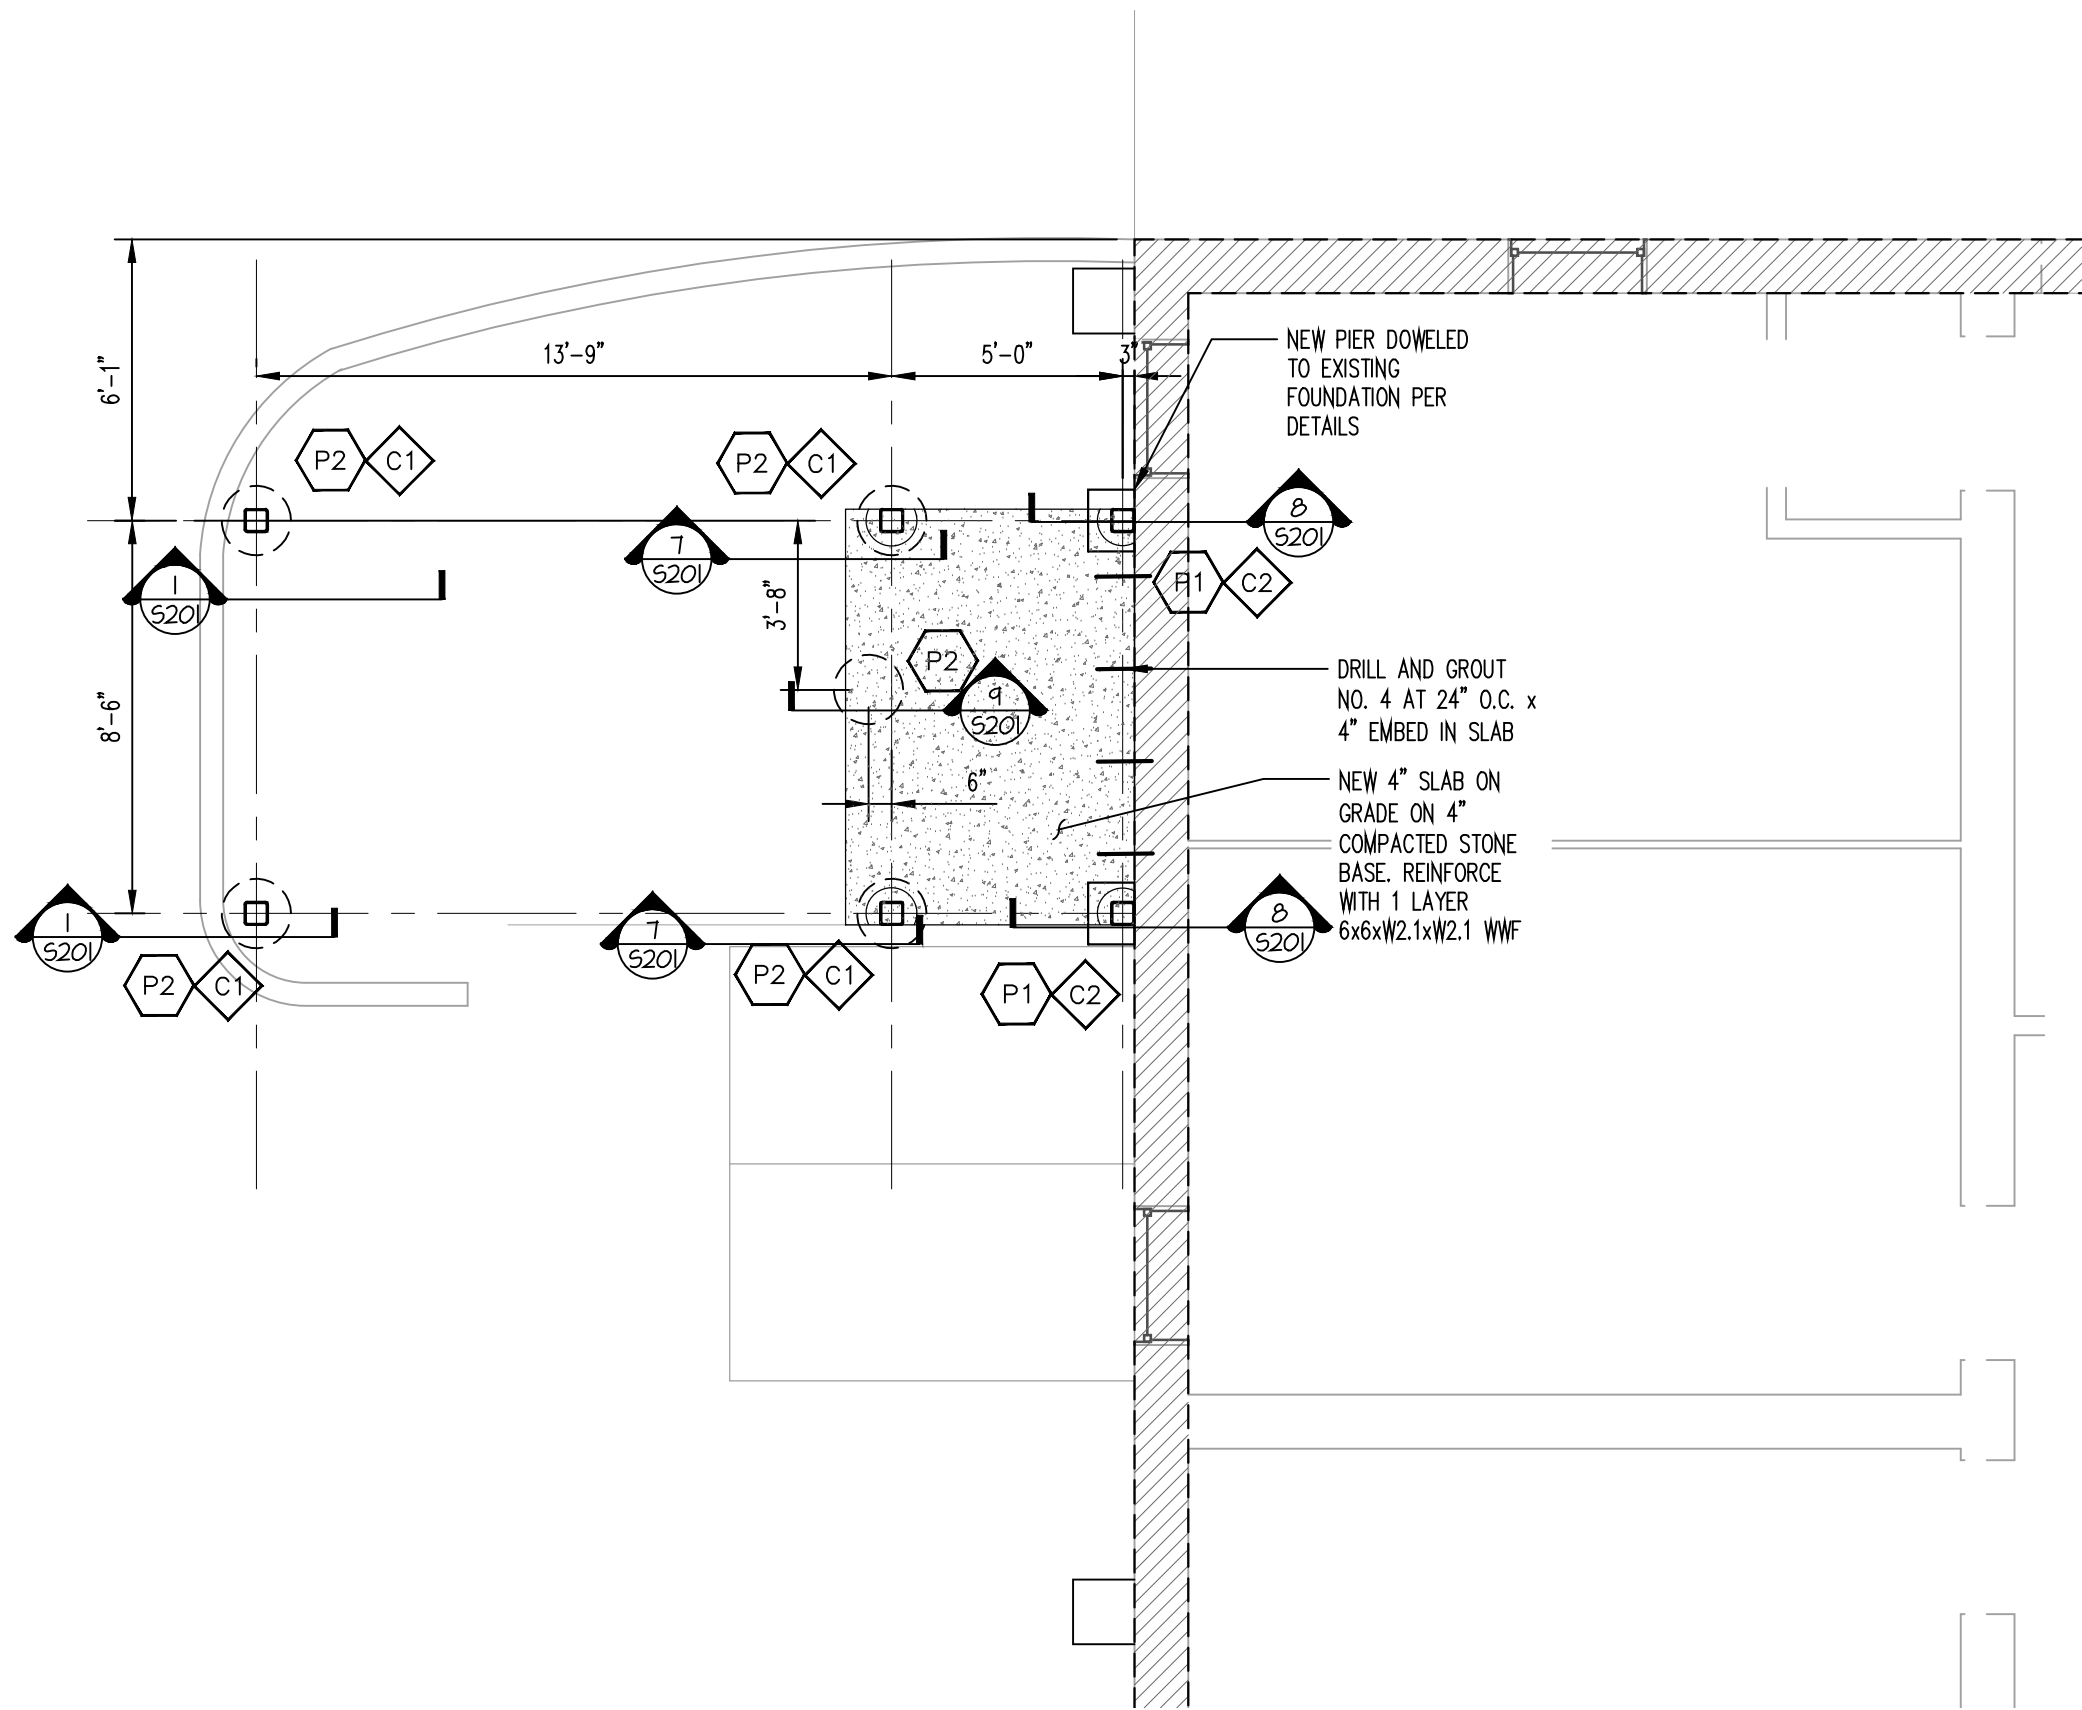
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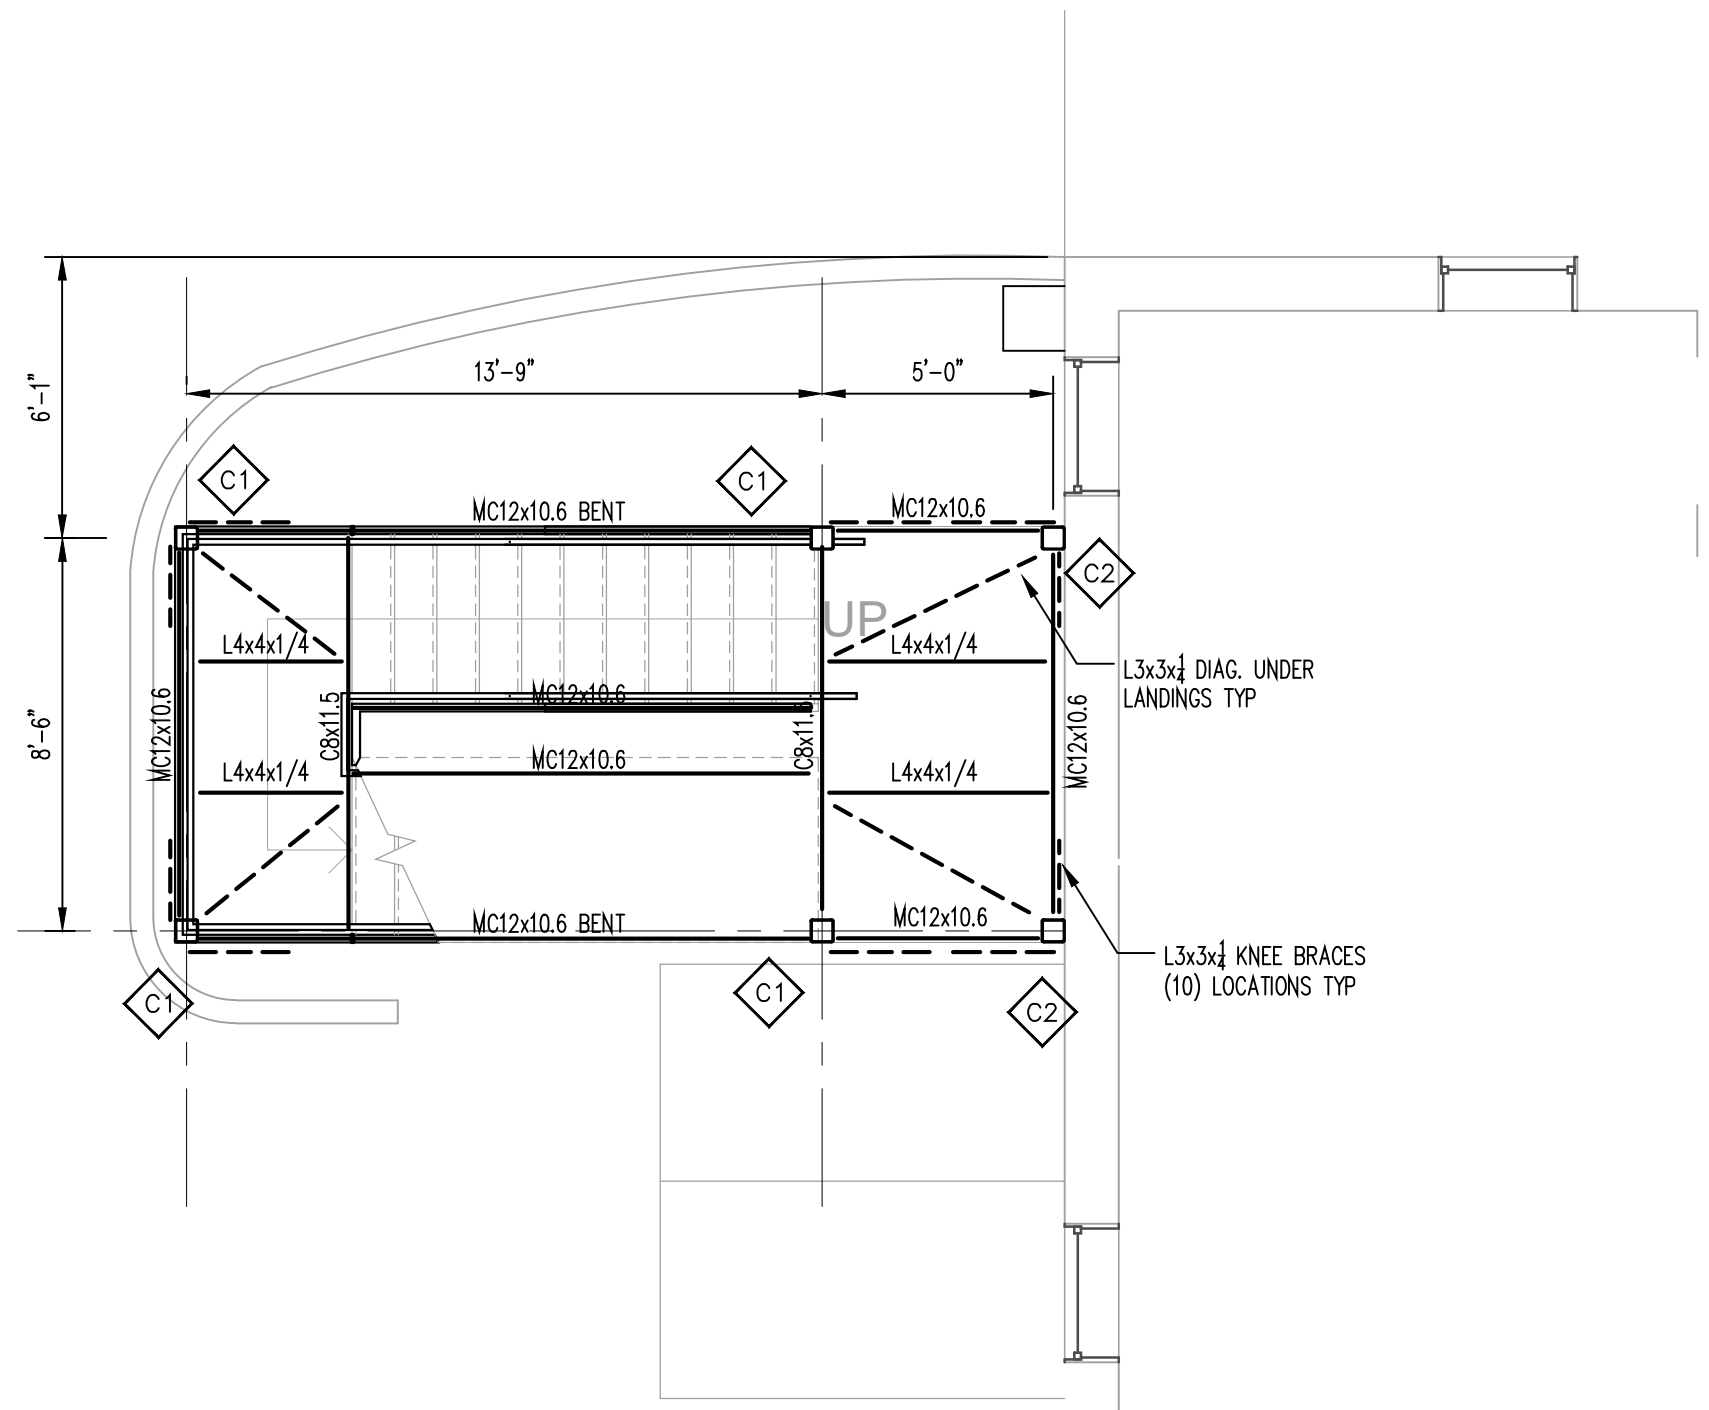
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PLANS

Drawing Number

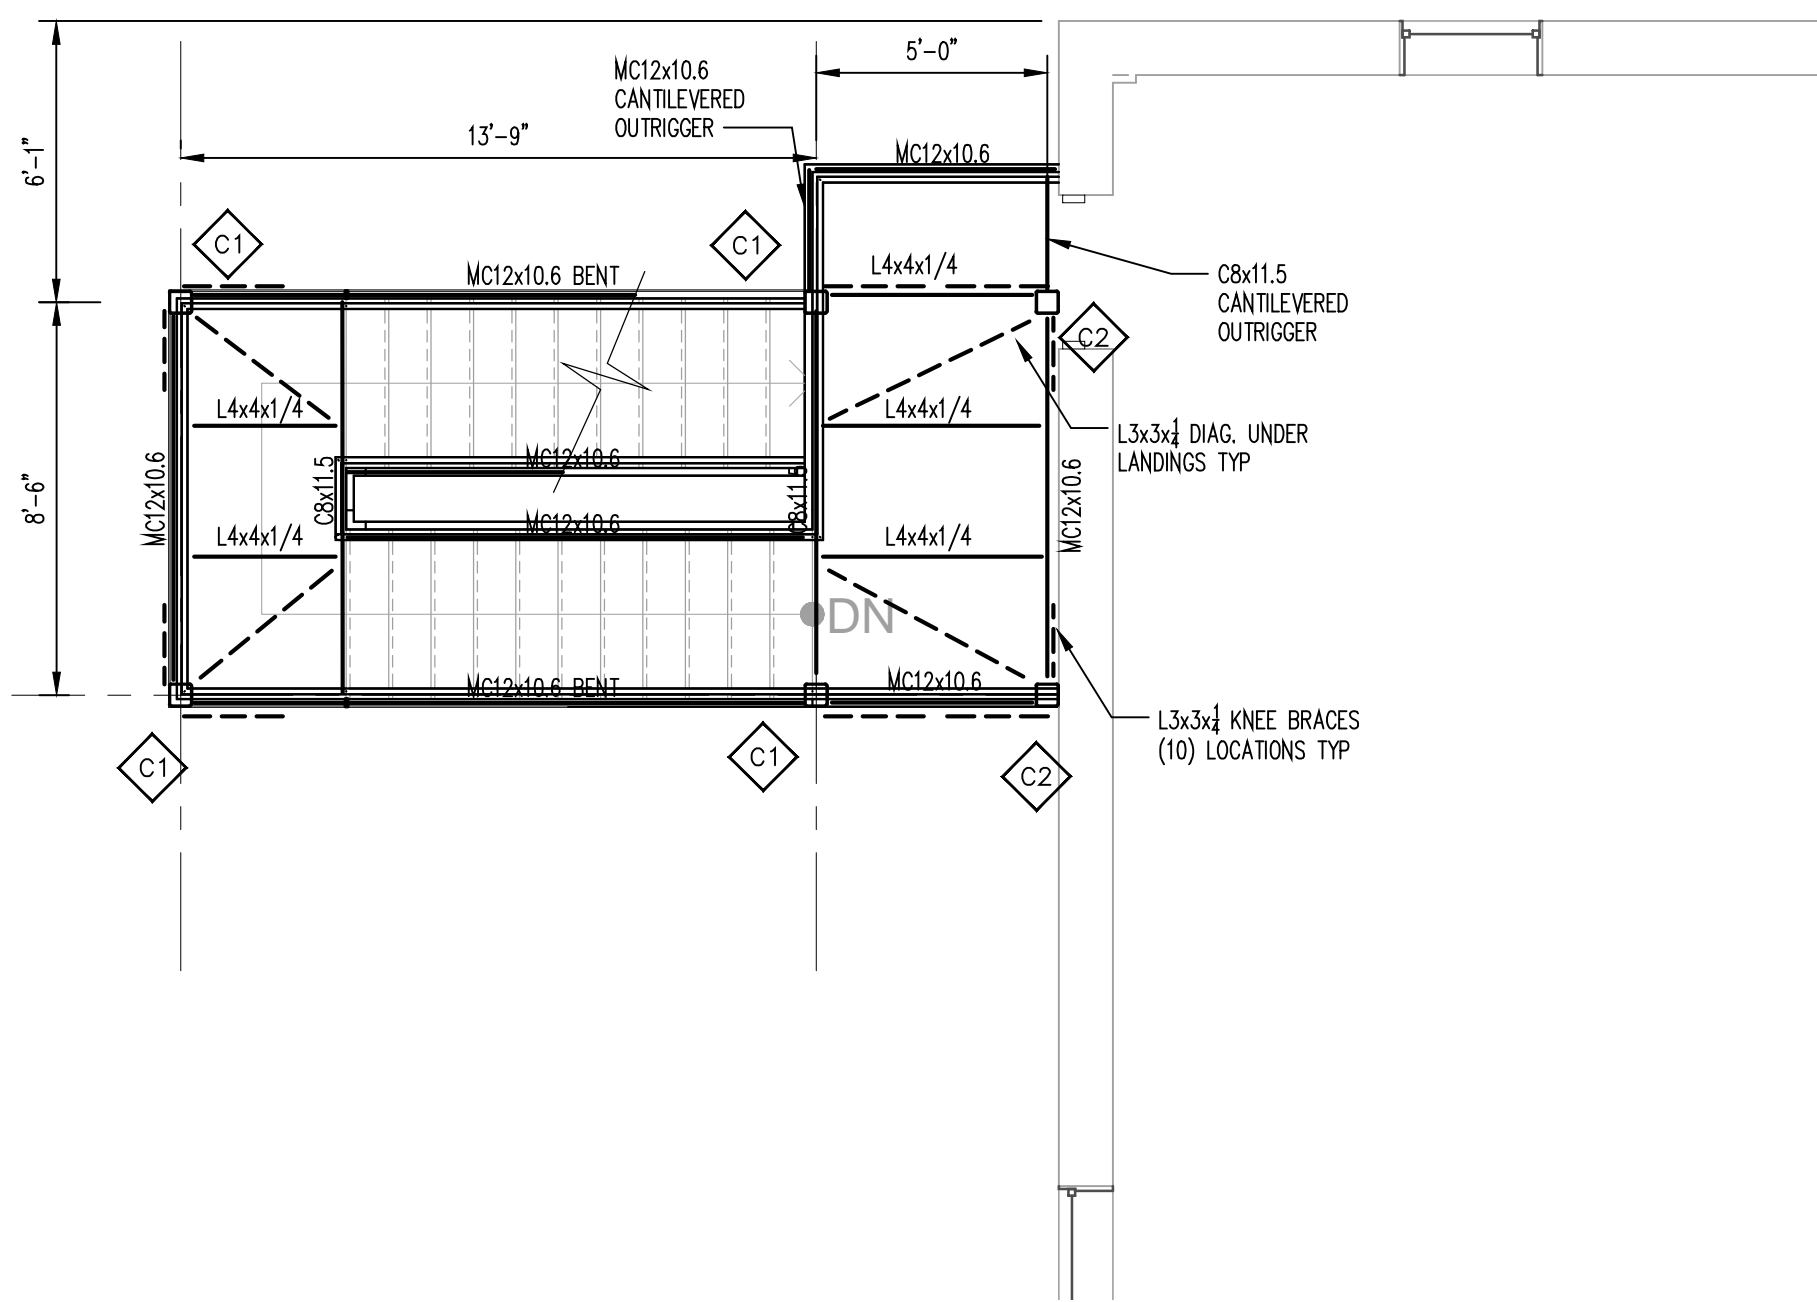
S1-01



1 GROUND LEVEL FOUNDATION PLAN  
SCALE: 1/4" = 1'-0"

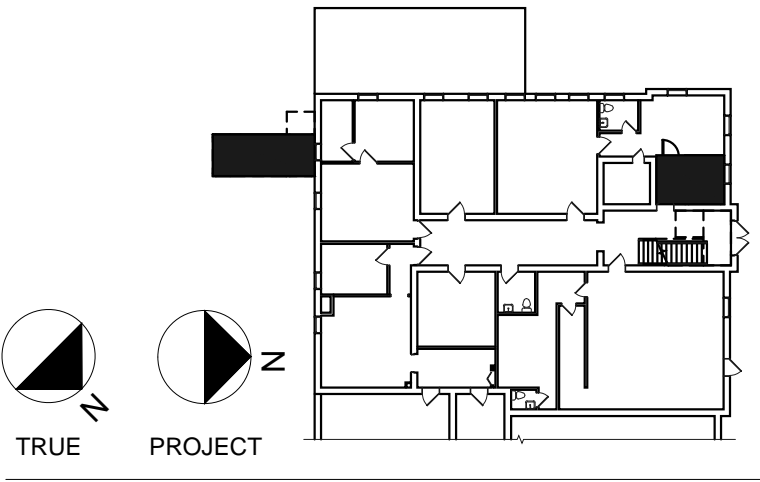


2 TYPICAL STAIR MID LEVELS  
SCALE: 1/4" = 1'-0"



3 UPPERSECOND STAIR FRAMING  
SCALE: 1/4" = 1'-0"

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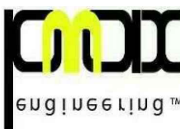
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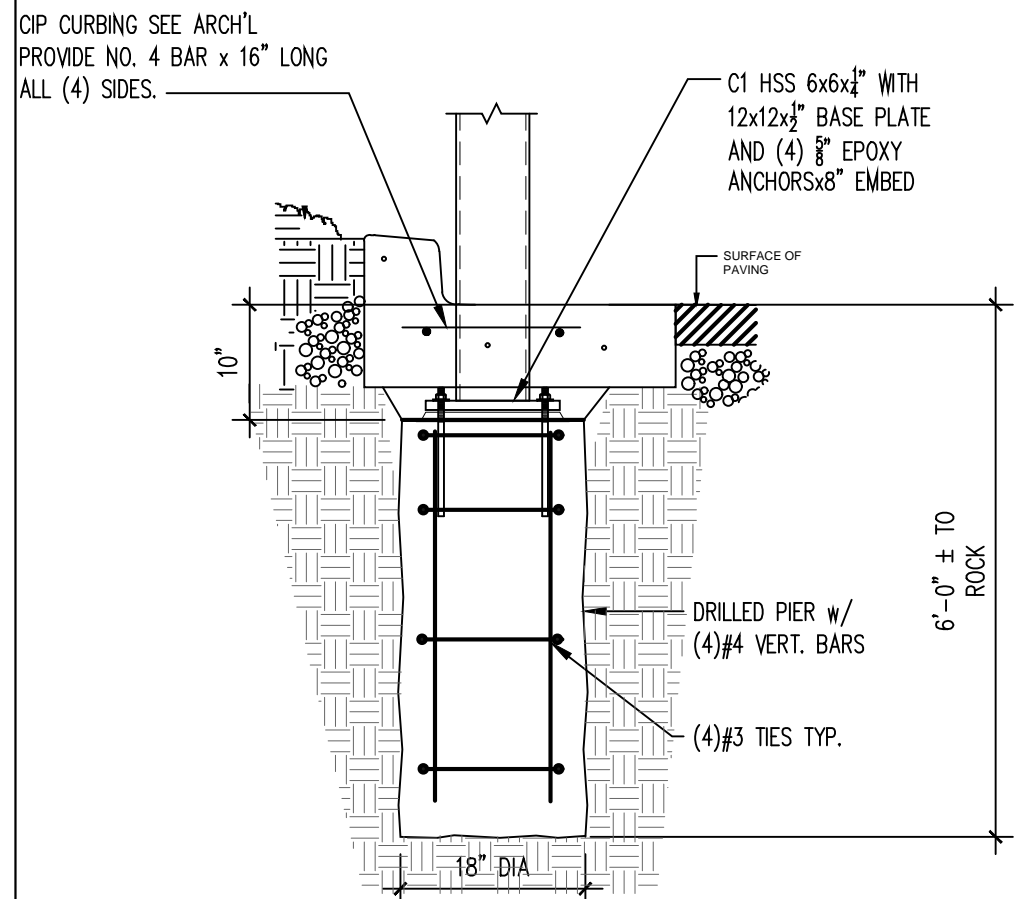
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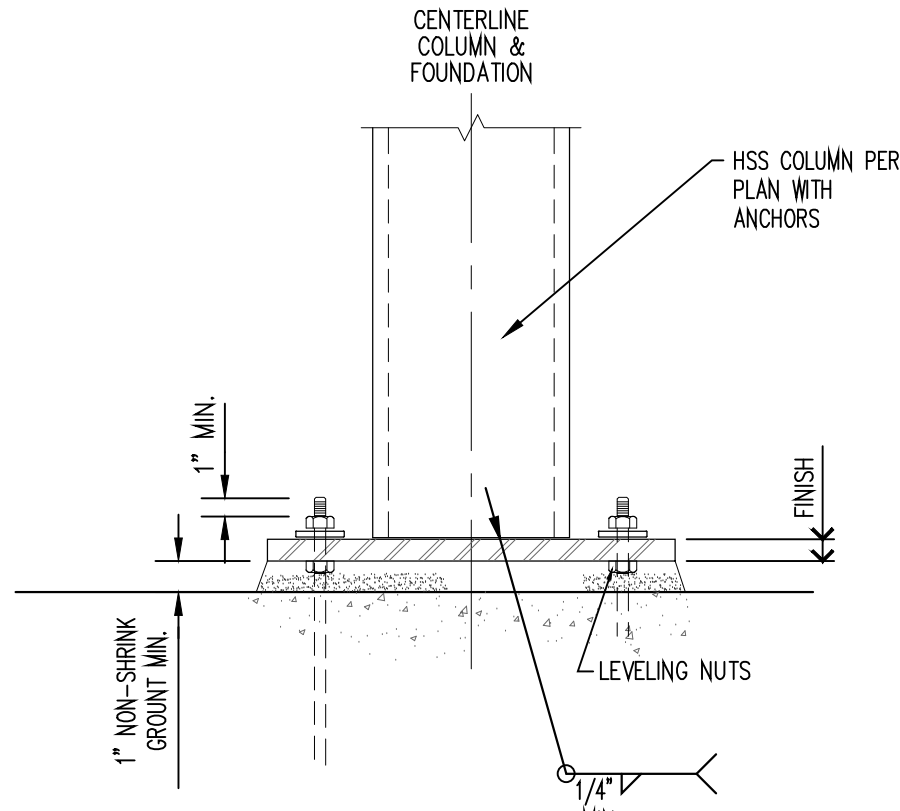
STAIR PLANS

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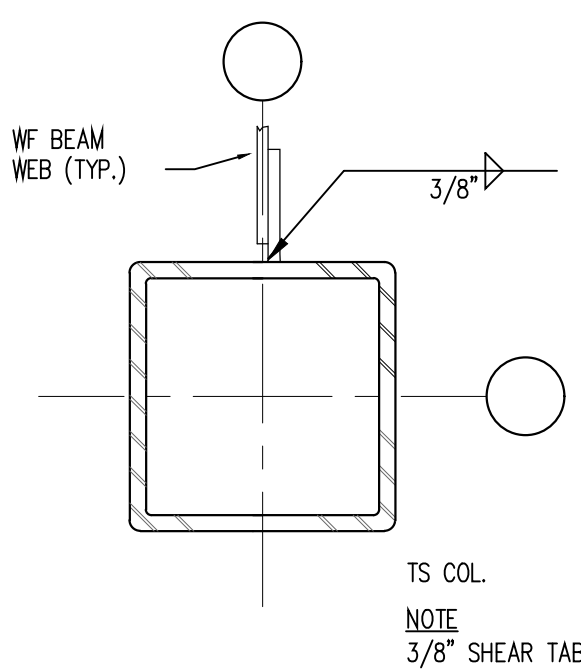
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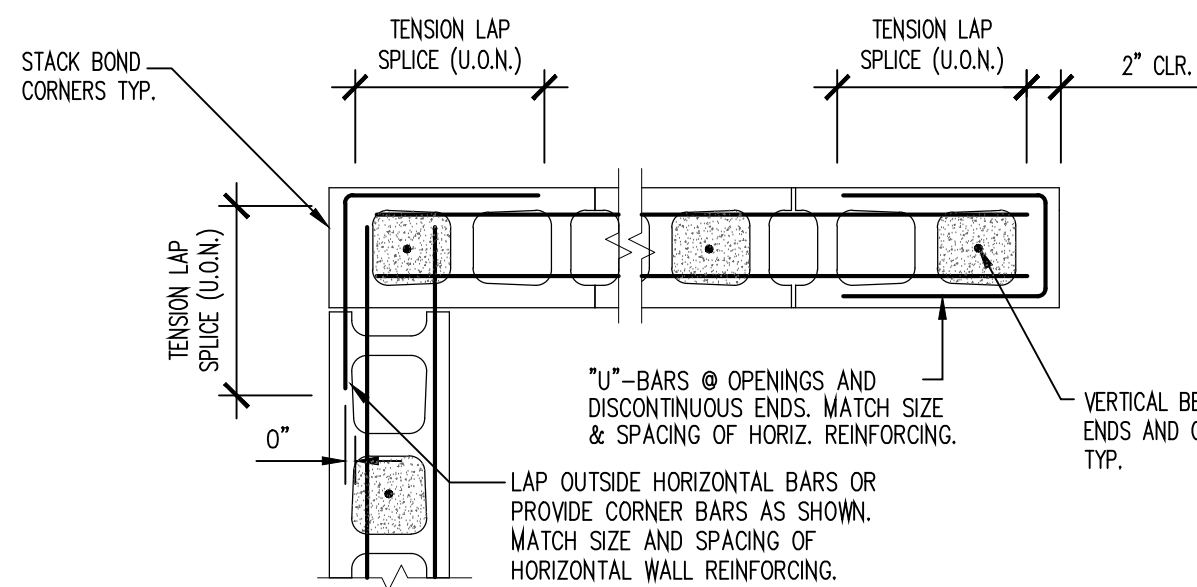
1 FOUNDATION SECTION  
SCALE: 3/4" = 1'-0" AT STAIRS



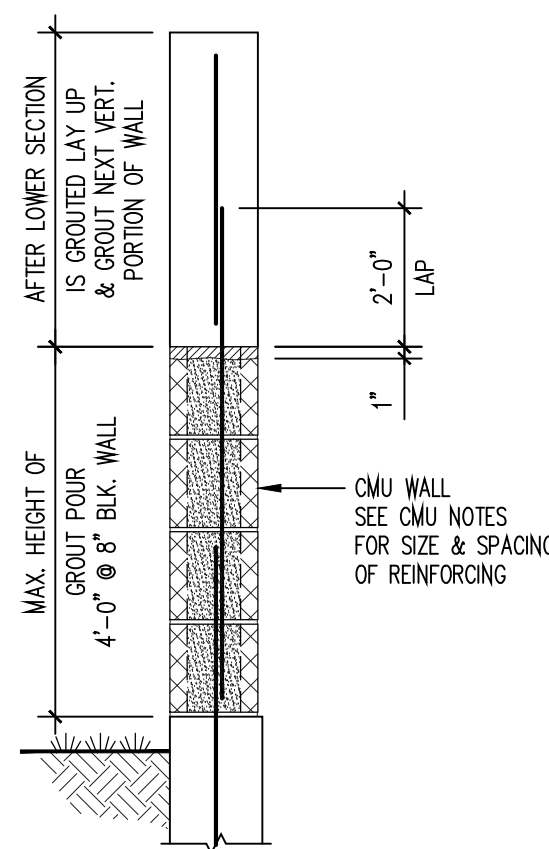
2 TYP. STEEL COLUMN BASE  
SCALE: NONE



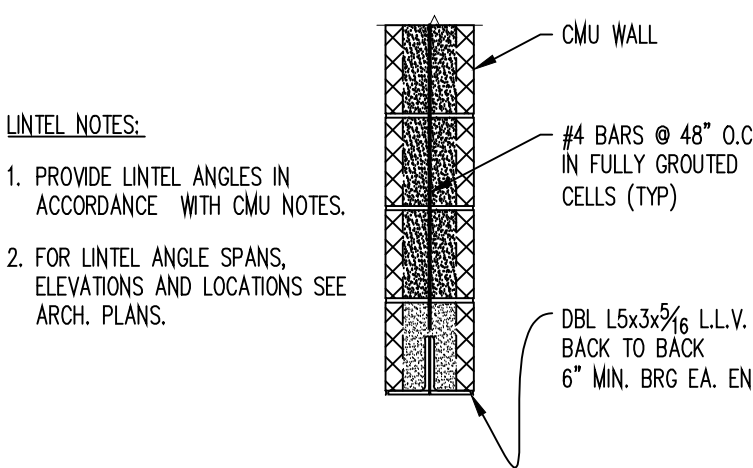
3 TYPICAL BEAM TO TUBE  
COLUMN CONNECTION DETAIL  
SCALE: NONE



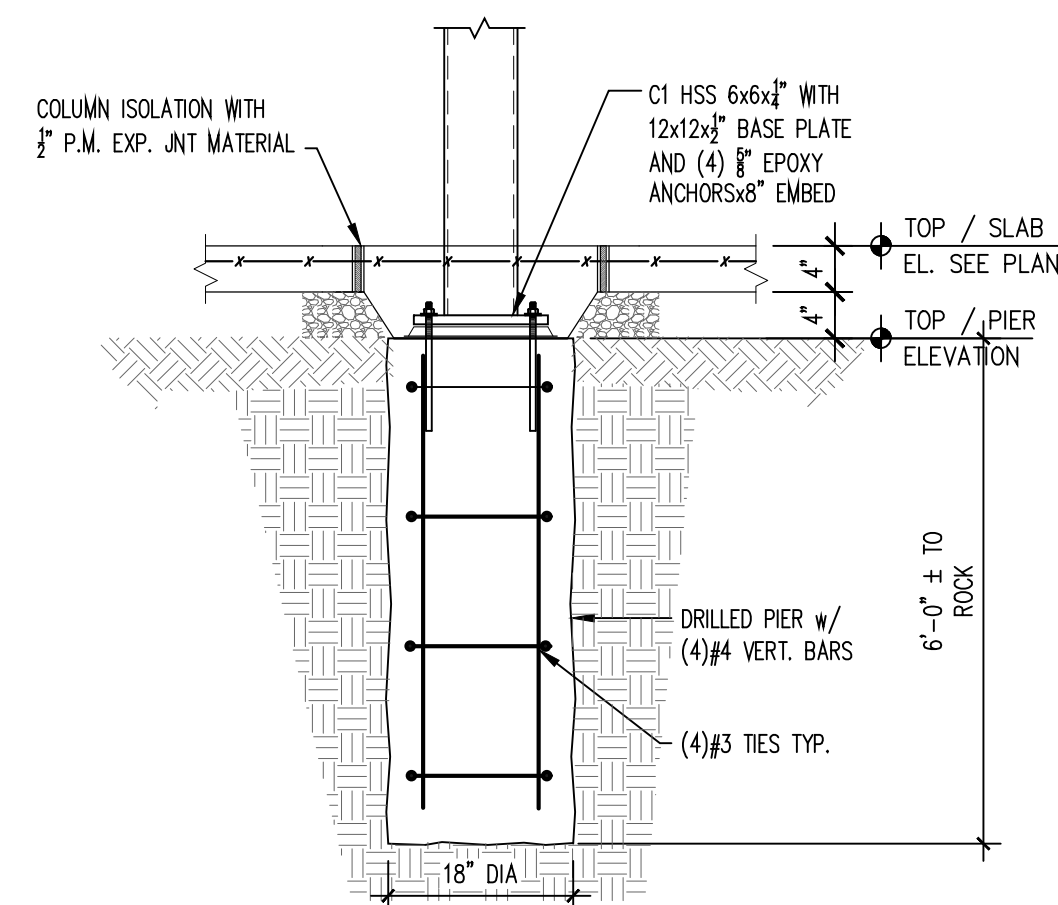
4 TYP. CORNERS AND  
ENDS OF MASONRY WALLS  
SCALE: NONE



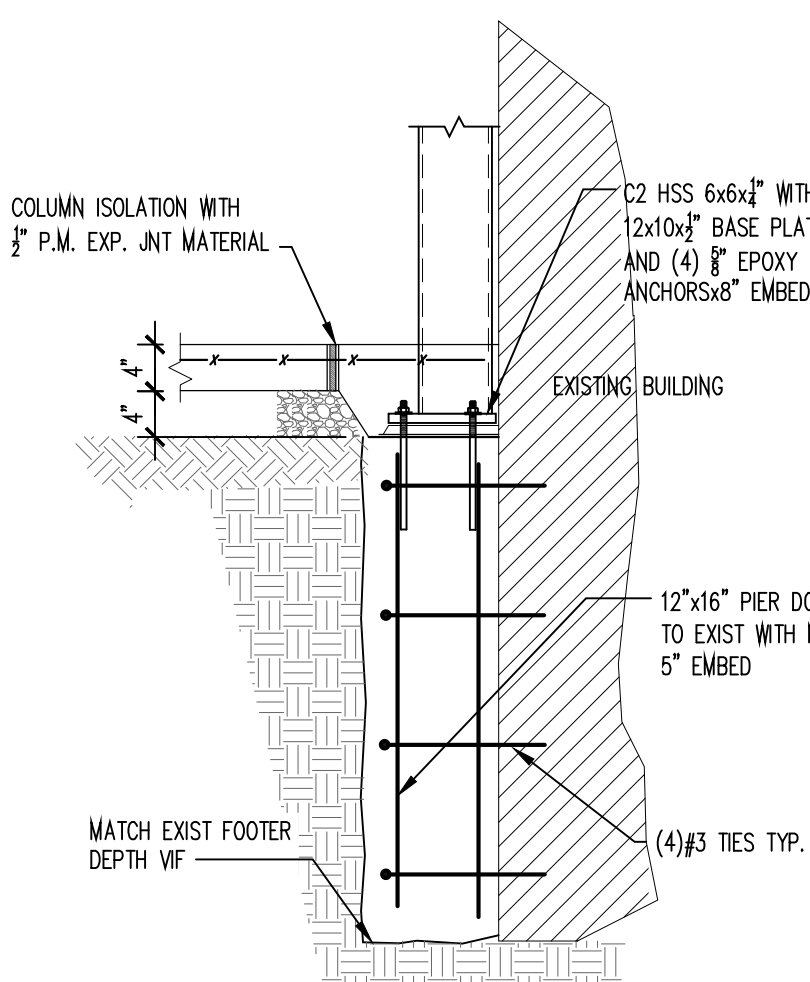
5 MASONRY -GROUTING SEQUENCE  
SCALE: N.T.S.



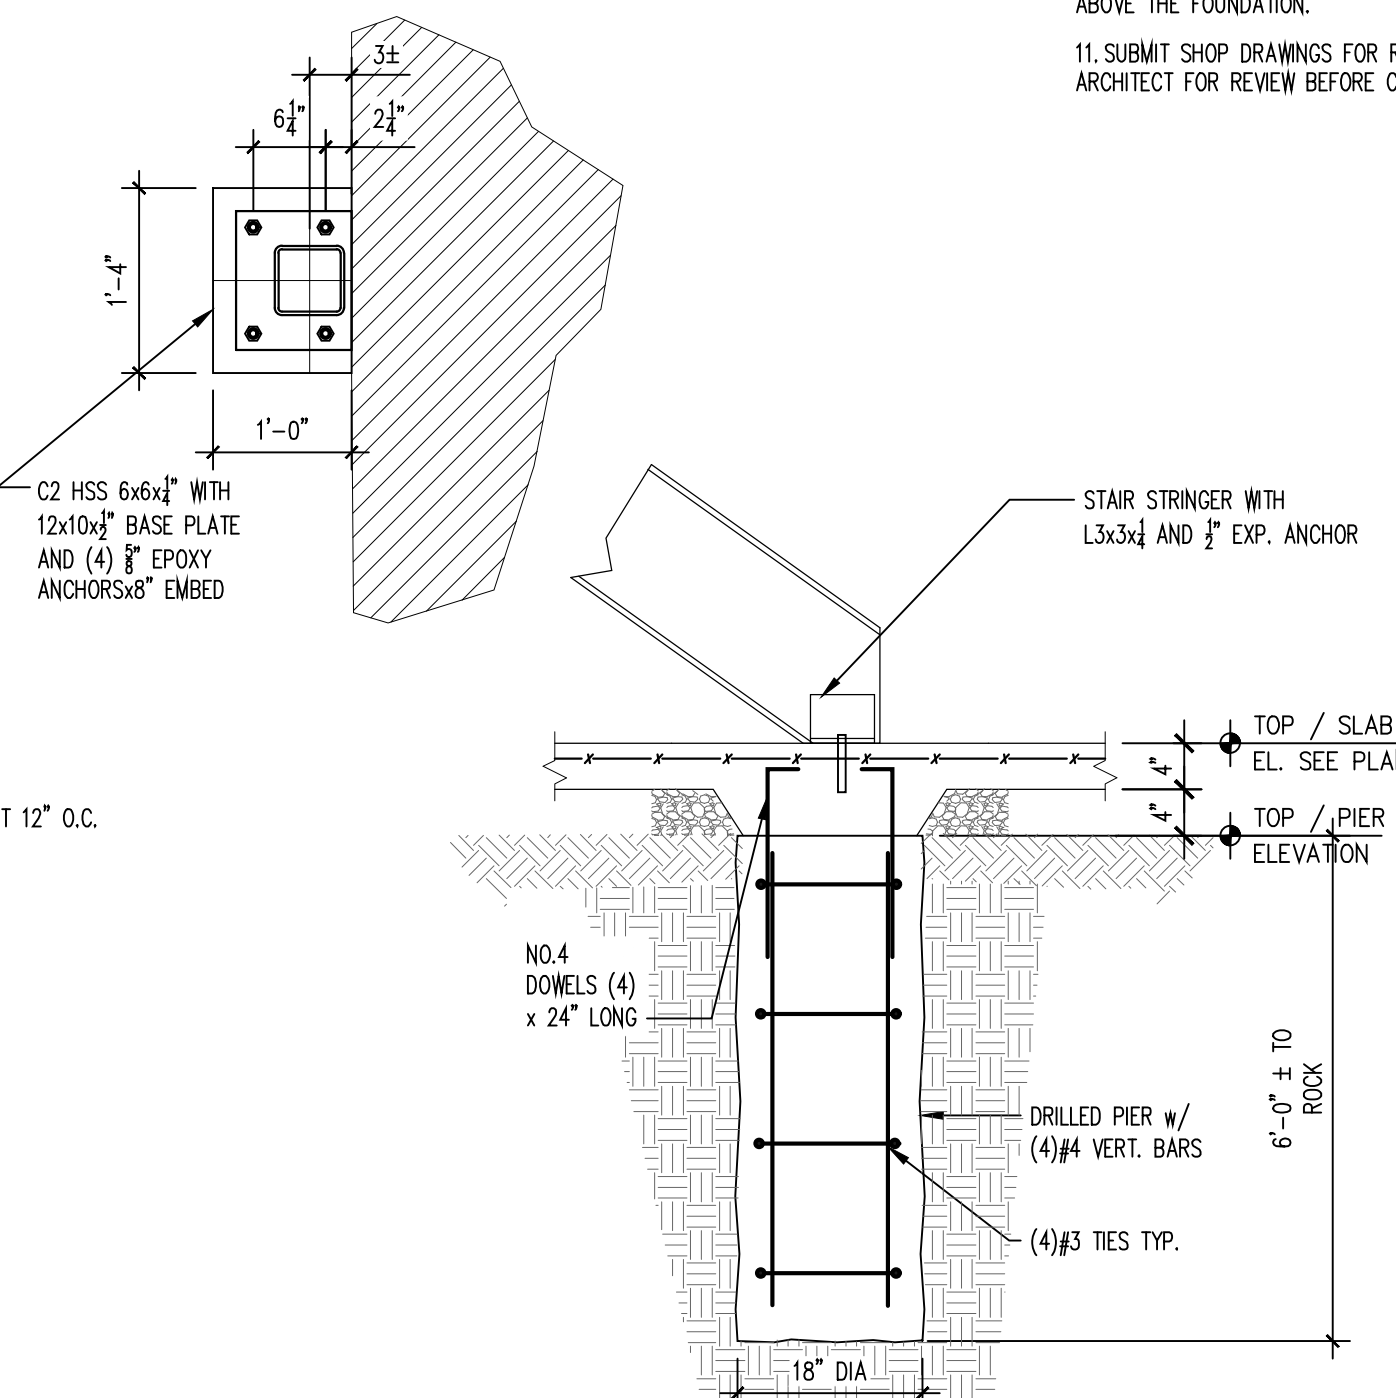
6 LINTEL DETAIL  
SCALE: 3/4" = 1'-0" TYPICAL



7 FOUNDATION SECTION  
SCALE: 3/4" = 1'-0" AT STAIRS



8 FOUNDATION SECTION  
SCALE: 3/4" = 1'-0" AT STAIRS



9 FOUNDATION SECTION  
SCALE: 3/4" = 1'-0" AT STAIRS

## STRUCTURAL STEEL:

- STRUCTURAL STEEL SHALL CONFORM TO THE LATEST EDITION OF THE AISC CODE OF STANDARD PRACTICE.
- STRUCTURAL STEEL GRADES (UNLESS NOTED OTHERWISE):
  - STRUCTURAL STEEL (L-, C- PLATES): ASTM A36,  $f_y = 36$ ksi
  - STRUCTURAL TUBING: ASTM A500,  $f_y = 46$ ksi
  - BOLTS: ASTM A325
  - WELDS: E70xx
- SUBMIT SHOP DRAWINGS FOR STRUCTURAL STEEL FOR REVIEW PRIOR TO CONSTRUCTION.

## SPECIAL INSPECTIONS:

- SPECIAL INSPECTIONS SHALL CONFORM TO THE LATEST CODE
- SPECIAL INSPECTIONS AND TESTING REQUIREMENTS INDICATED IN THIS SECTION ARE THE OWNER'S RESPONSIBILITY. OWNER WILL ENGAGE QUALIFIED SPECIAL INSPECTORS AND TESTING AGENCIES TO PERFORM THESE SERVICES.

## CONCRETE:

- CONCRETE DESIGN AND CONSTRUCTION SHALL CONFORM TO ACI 318-02 AND ACI 301-05.
- MINIMUM COMPRESSIVE STRENGTH AT 28 DAYS SHALL BE:
  - FOOTINGS 3,000psi, MAX. W/C RATIO = 0.45
  - PIERS, FND. WALLS 3,500psi, MAX. W/C RATIO = 0.50
  - SLAB ON GRADE 3,500psi, MAX. W/C RATIO = 0.50
- LEVELING GROUT SHALL BE NON-SHRINK CONFORMING TO ASTM C1107 WITH A MINIMUM 2-DAY STRENGTH OF 5,000psi.
- ALL CONCRETE EXPOSED TO EARTH OR WEATHER SHALL HAVE ENTRAINED AIR AS FOLLOWS:

MAXIMUM AGGREGATE SIZE	AIR CONTENT
2 in.	4% TO 6.5%
1.5 in.	4% TO 7%
1 in.	4.5% TO 7%
0.75 in.	4.5% TO 7%

- REINFORCING STEEL SHALL CONFORM TO ASTM A615, GRADE 60. WELDED WIRE FABRIC SHALL CONFORM TO ASTM A185, AND SHALL BE SUPPLIED IN SHEETS ONLY. THE WELDING OF REINFORCING BARS SHALL CONFORM TO ASTM A706 AND AWS D1.4.
- THE CONTRACTOR SHALL FABRICATE ALL REINFORCEMENT AND FURNISH ALL ACCESSORIES, CHAIRS, SPACER BARS AND SUPPORTS NECESSARY TO SECURE THE REINFORCEMENT PRIOR TO POURING CONCRETE.
- CLEAR COVER TO REINFORCING SHALL BE AS FOLLOWS UNLESS SHOWN OTHERWISE
  - CONCRETE CAST AGAINST AND PERMANENTLY EXPOSED TO EARTH - 3"
  - FORMED CONCRETE EXPOSED TO EARTH OR WEATHER:
    - #6 AND LARGER - 2"
    - #5 AND SMALLER - 1 1/2"
  - CONCRETE NOT EXPOSED TO EARTH OR WEATHER:
    - SLABS, WALLS - 3/4"
    - ALL OTHER - 1/2"
- LAP SPICES SHALL CONFORM TO THE REQUIREMENTS OF ACI 318 FOR CLASS "B" TENSION LAP SPICES, UNLESS NOTED OTHERWISE.
- HOOKS AND BENDS IN REINFORCING BARS SHALL CONFORM TO ACI 318 UNLESS SHOWN OTHERWISE ON THE DRAWINGS.
- UNLESS SHOWN OTHERWISE, DOWELS INTO FOUNDATION ELEMENTS SHALL HAVE A STANDARD 90 DEGREE HOOK AND SHALL BE THE SAME SIZE AND QUANTITY PROVIDED IN PIERS AND WALLS ABOVE THE FOUNDATION.
- SUBMIT SHOP DRAWINGS FOR REINFORCING STEEL AND CONCRETE MIX DESIGNS TO THE ARCHITECT FOR REVIEW BEFORE CONSTRUCTION.

## DESIGN LOADS:

- LIVE LOAD:
  - = 100 PSF
- SNOW LOADS:
  - = 50psf
  - = 35psf (42PSF AT OVERHANGS)
  - = 1.0 (1.2 AT OVERHANGS)
- WIND LOADS:
  - = 109mph
  - = 1.0
  - EXPOSURE = B

### SEISMIC

SEISMIC USE GROUP "II" -  
SEISMIC DESIGN CATEGORY "B"  
SDS = 0.114g  
SD1 = 0.031g  
SITE CLASS "A"

BASIC SEISMIC FORCE RESISTING  
SYSTEM = ORDINARY MOMENT  
FRAMES R=3.0  
DESIGN BASE SHEAR = 1k  
ANALYSIS PROCEDURE =  
EQUIVALENT LATERAL FORCE  
PROCEDURE  
 $I_e = 1.00$

## GENERAL STRUCTURAL NOTES:

- DESIGN AND CONSTRUCTION SHALL CONFORM TO THE NEW YORK STATE BUILDING CODE 2020. THE DRAWINGS AND SPECIFICATIONS REPRESENT THE FINISHED STRUCTURE AS A COMPLETE UNIT. THE CONTRACTOR SHALL BE RESPONSIBLE FOR ALL MEANS, METHODS, AND SEQUENCES OF ALL PHASES OF CONSTRUCTION AND DEMOLITION INCLUDING TEMPORARY SHORING, BRACING, COLD AND HOT-WEATHER PROTECTION, AND FOUNDATION UNDERPINNING. THE CONTRACTOR SHALL COMPLY WITH ALL APPLICABLE CODES AND STANDARDS THAT PERTAIN TO MEANS, METHODS, AND SEQUENCES OF CONSTRUCTION.
- THE GENERAL CONTRACTOR SHALL ENGAGE A LICENSED PROFESSIONAL ENGINEER IN THIS JURISDICTION TO DEVELOP SHORING CALCULATIONS AND PLANS SIGNED AND SEALED. THESE SHALL BE SUBMITTED TO THE ARCHITECT PRIOR TO THE START OF CONSTRUCTION.
- THE STRUCTURAL DRAWINGS ARE TO BE USED IN CONJUNCTION AND COORDINATED WITH ALL OTHER CONTRACT DRAWINGS AND SPECIFICATIONS. THE CONTRACTOR SHALL COORDINATE SUCH REQUIREMENTS INTO THEIR WORK.
- DETAILS NOT SPECIFICALLY SHOWN SHALL BE SIMILAR TO THOSE SHOWN FOR THE MOST NEARLY SIMILAR CONDITION AS DETERMINED BY THE ARCHITECT OR ENGINEER.
- CONTRACTOR TO COORDINATE ALL OPENINGS, EQUIPMENT LOCATIONS, AND INSERTS SHOWN ON THE STRUCTURAL DRAWINGS WITH THE TRADES THAT REQUIRE THEM. PENETRATIONS THROUGH STRUCTURAL MEMBERS ARE NOT PERMITTED EXCEPT AS DETAILED.
- CONTRACTOR SHALL VERIFY EXISTING CONDITIONS IN THE FIELD AND NOTIFY THE ARCHITECT OF ANY DISCREPANCIES, ALL DIMENSIONS TO THE EXISTING STRUCTURE AND ALL STRUCTURAL SIZES AND DEVIATIONS ARE APPROXIMATE AND SHALL BE VERIFIED BY THE CONTRACTOR PRIOR TO CONSTRUCTION.
- WHERE DEMOLITION OR OTHER MODIFICATIONS TO THE EXISTING STRUCTURE ARE REQUIRED, THE CUTTING, DRILLING, AND REMOVALS SHALL OCCUR IN A MANNER WHICH WILL PREVENT DAMAGE TO ADJOINING CONSTRUCTION WHICH IS TO REMAIN. UNLESS OTHERWISE INDICATED, PROVIDE NEW MATERIALS TO MATCH THE APPEARANCE AND PERFORMANCE OF EXISTING CORRESPONDING MATERIALS WHERE DEMOLITION OCCURS.
- STRUCTURAL MEMBERS MARKED (EX) ARE EXISTING AND ARE TO BE VERIFIED IN THE FIELD.
- SHOP DRAWINGS PREPARED BY SUPPLIERS AND SUBCONTRACTORS SHALL BE REVIEWED AND SIGNED AND STAMPED BY THE CONTRACTOR PRIOR TO SUBMISSION TO THE ARCHITECT AND ENGINEER. REPRODUCTIONS OF THE STRUCTURAL DRAWINGS SHALL NOT BE USED FOR THE PREPARATION OF SHOP DRAWINGS. MANUFACTURED COMPONENTS SHALL BE SIGNED AND STAMPED BY A LICENSED PROFESSIONAL ENGINEER PRIOR TO SUBMISSION.
- ALL SHOP DRAWINGS SHALL INCORPORATE ACTUAL EXISTING CONDITIONS WHERE THE NEW CONSTRUCTION ADJOINS THE EXISTING STRUCTURE. THE EXISTING STRUCTURE IS TO BE EXPOSED AS NEEDED TO VERIFY THAT THE EXISTING STRUCTURE MATCHES THE DESIGN INTENT. THE ARCHITECT IS TO BE NOTIFIED WHEN THE EXISTING CONDITIONS DO NOT MATCH THE DESIGN INTENT OR WHEN THE EXISTING CONDITIONS NECESSITATE A CHANGE TO THE DESIGN.

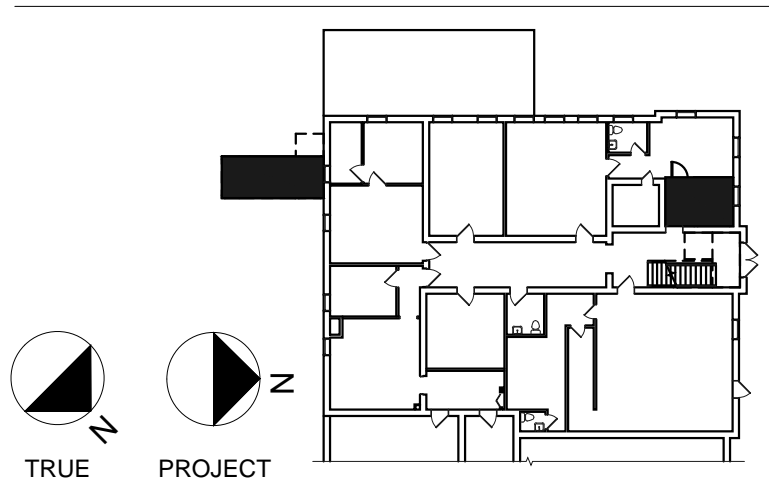
## FOUNDATIONS:

- SOIL BEARING SURFACES SHALL BE DRY AND FREE FROM FROST OR LOOSE MATERIAL. EXISTING SOIL TO BE REMOVED AND REPLACED AS RECOMMENDED BY THE GEOTECHNICAL ENGINEER. ALL SOIL BEARING SURFACES AND BACKFILL SHALL BE INSPECTED AND APPROVED BY THE GEOTECHNICAL ENGINEER OR OTHER APPROVED TESTING AGENT.
- CONTRACTOR SHALL VERIFY AND LOCATE ALL EXISTING BELOW GRADE UTILITIES PRIOR TO CONSTRUCTION.
- CONTRACTOR TO PROVIDE TEMPORARY PROTECTION AS REQUIRED FOR FOUNDATIONS EXPOSED TO WATER OR FREEZING.

## MASONRY:

- CONCRETE MASONRY DESIGN AND CONSTRUCTION SHALL CONFORM TO THE LATEST EDITION OF ACI 530.
- CONCRETE MASONRY UNITS SHALL CONFORM TO ASTM C-90, TYPE I, GRADE N, MOISTURE CONTROLLED UNITS WITH  $F_m = 2,000$ psi.
- MORTAR SHALL BE TYPE M OR S AND SHALL CONFORM TO ASTM C270.
- HORIZONTAL JOINT REINFORCING: 9ga, ASTM A82, GALVANIZED LADDER-TYPE SHALL BE PROVIDED AT 16" O.C. UNLESS NOTED OTHERWISE.
- GROUT FOR FILLING BLOCK CORES SHALL CONFORM TO ASTM C476 WITH A MINIMUM COMPRESSIVE STRENGTH OF 2,000psi AT 28 DAYS. GROUT SHALL BE PLACED IN LIFTS NOT EXCEEDING 7 COURSES IN HEIGHT UNLESS OTHERWISE APPROVED BY THE ENGINEER.
- FULL HEAD AND BED JOINTS SHALL BE PROVIDED.
- COORDINATE LOCATION OF ALL MASONRY WALLS, PARTITIONS AND OPENINGS WITH ARCHITECTURAL DRAWINGS.
- LAP SPICES IN VERTICAL REINFORCING FOR CONCRETE BLOCK MASONRY WALLS AND PLASTER SHALL BE A MINIMUM OF 48 BAR DIAMETERS UNLESS DETAILED OTHERWISE ON THE DRAWINGS.
- ALL LINTELS AT MASONRY OPENINGS SHALL HAVE 4" MIN. OR 1" FOR EACH FOOT OF SPAN OF BEARING AT EACH END. ALL EXTERIOR LINTELS SHALL BE HOT DIPPED GALVANIZED.
- REFERENCE ARCHITECTURAL DRAWINGS AND PROJECT SPECIFICATIONS FOR CONTROL JOINT LOCATION REQUIREMENTS. ALL BOND BEAM REINFORCEMENT TO BE CONTINUOUS AT CONTROL JOINT LOCATIONS. SCORE BOND BEAM SHELL 3/8" EACH SIDE AT CONTROL JOINTS.
- MASONRY COURSING INDICATED ON THE STRUCTURAL DRAWINGS IS APPROXIMATE. REFER TO ARCHITECTURAL DRAWINGS FOR ACTUAL COURSING LAYOUT.
- REINFORCING STEEL SHALL BE IN PLACE AND SECURE PRIOR TO PLACING GROUT.
- ALL MASONRY CELLS BELOW GRADE SHALL BE GROUTED SOLID.
- SUBMIT SHOP DRAWINGS FOR REINFORCING STEEL, GROUT AND MORTAR MIX DESIGNS, AND CMU PRODUCT DATA TO THE ARCHITECT FOR REVIEW BEFORE CONSTRUCTION.

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## PERRY VILLAGE HALL ADA IMPROVEMENTS

### VILLAGE OF PERRY 46 N. MAIN ST.

PERRY, NY 14530

### 100% CONSTRUCTION DOCUMENT SUBMISSION

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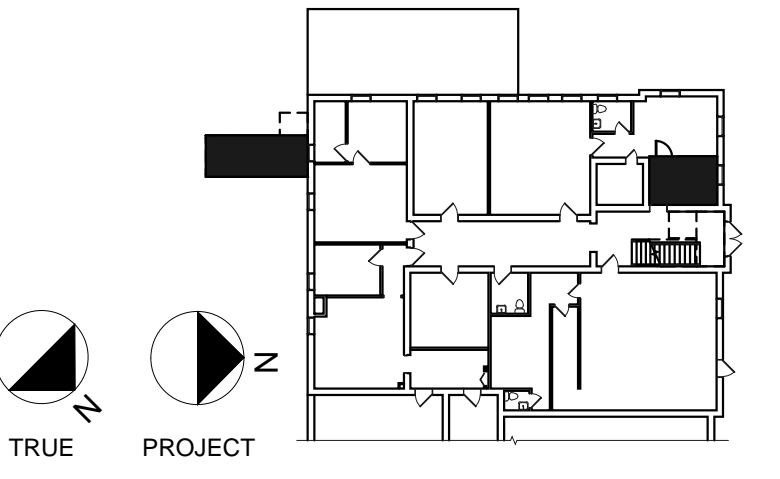
Drawing Title

## DETAILS

Drawing Number

S2-01

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DATE 01/05/2020



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## PERRY VILLAGE HALL ADA IMPROVEMENTS

VILLAGE OF PERRY  
46 N. MAIN ST.

PERRY, NY 14530

**100% CONSTRUCTION DOCUMENT SUBMISSION**

### NOTES & REVISIONS:

Revision Schedule		
Revision Number	Date	Description

DRAWING ISSUED: FEBRUARY 01, 2021

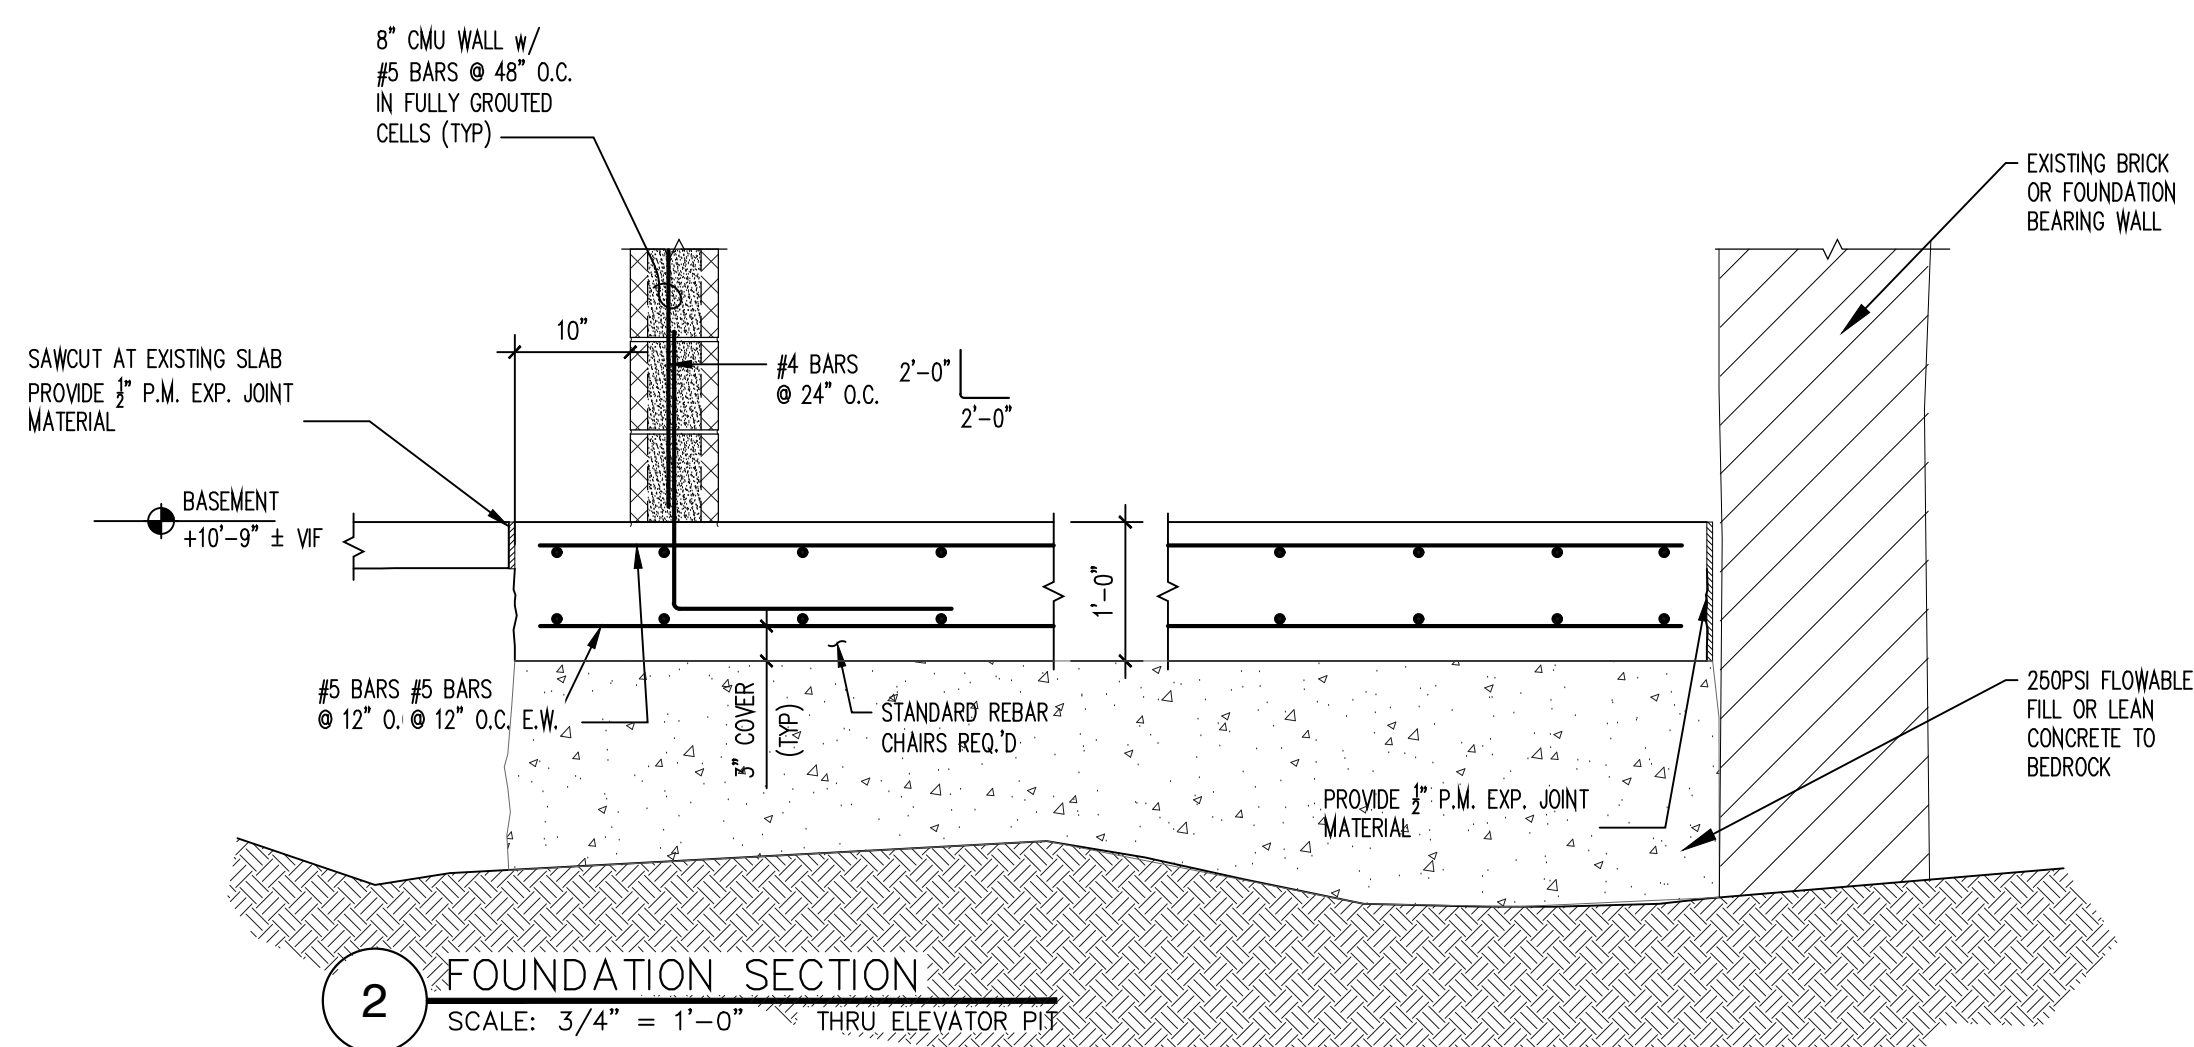
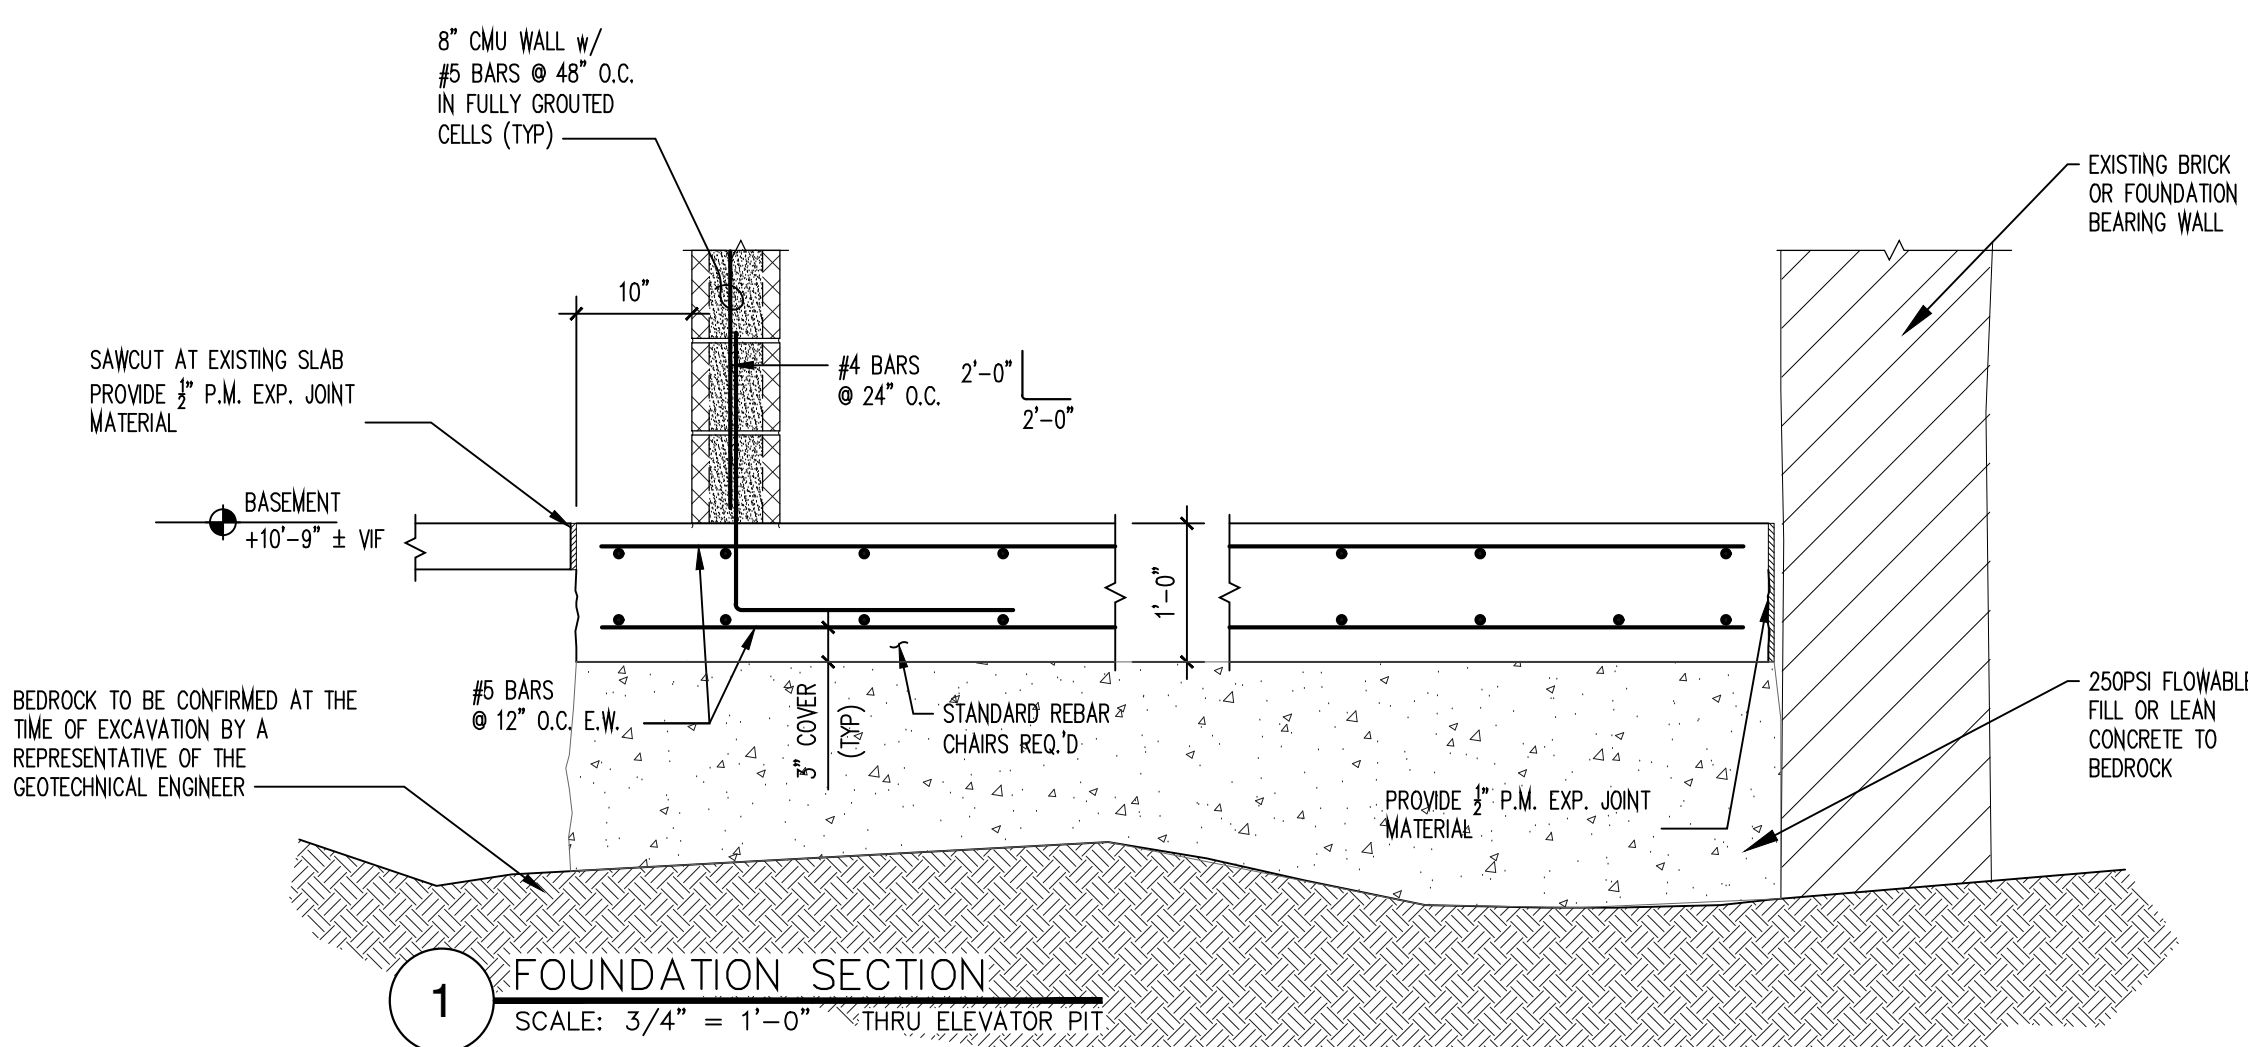
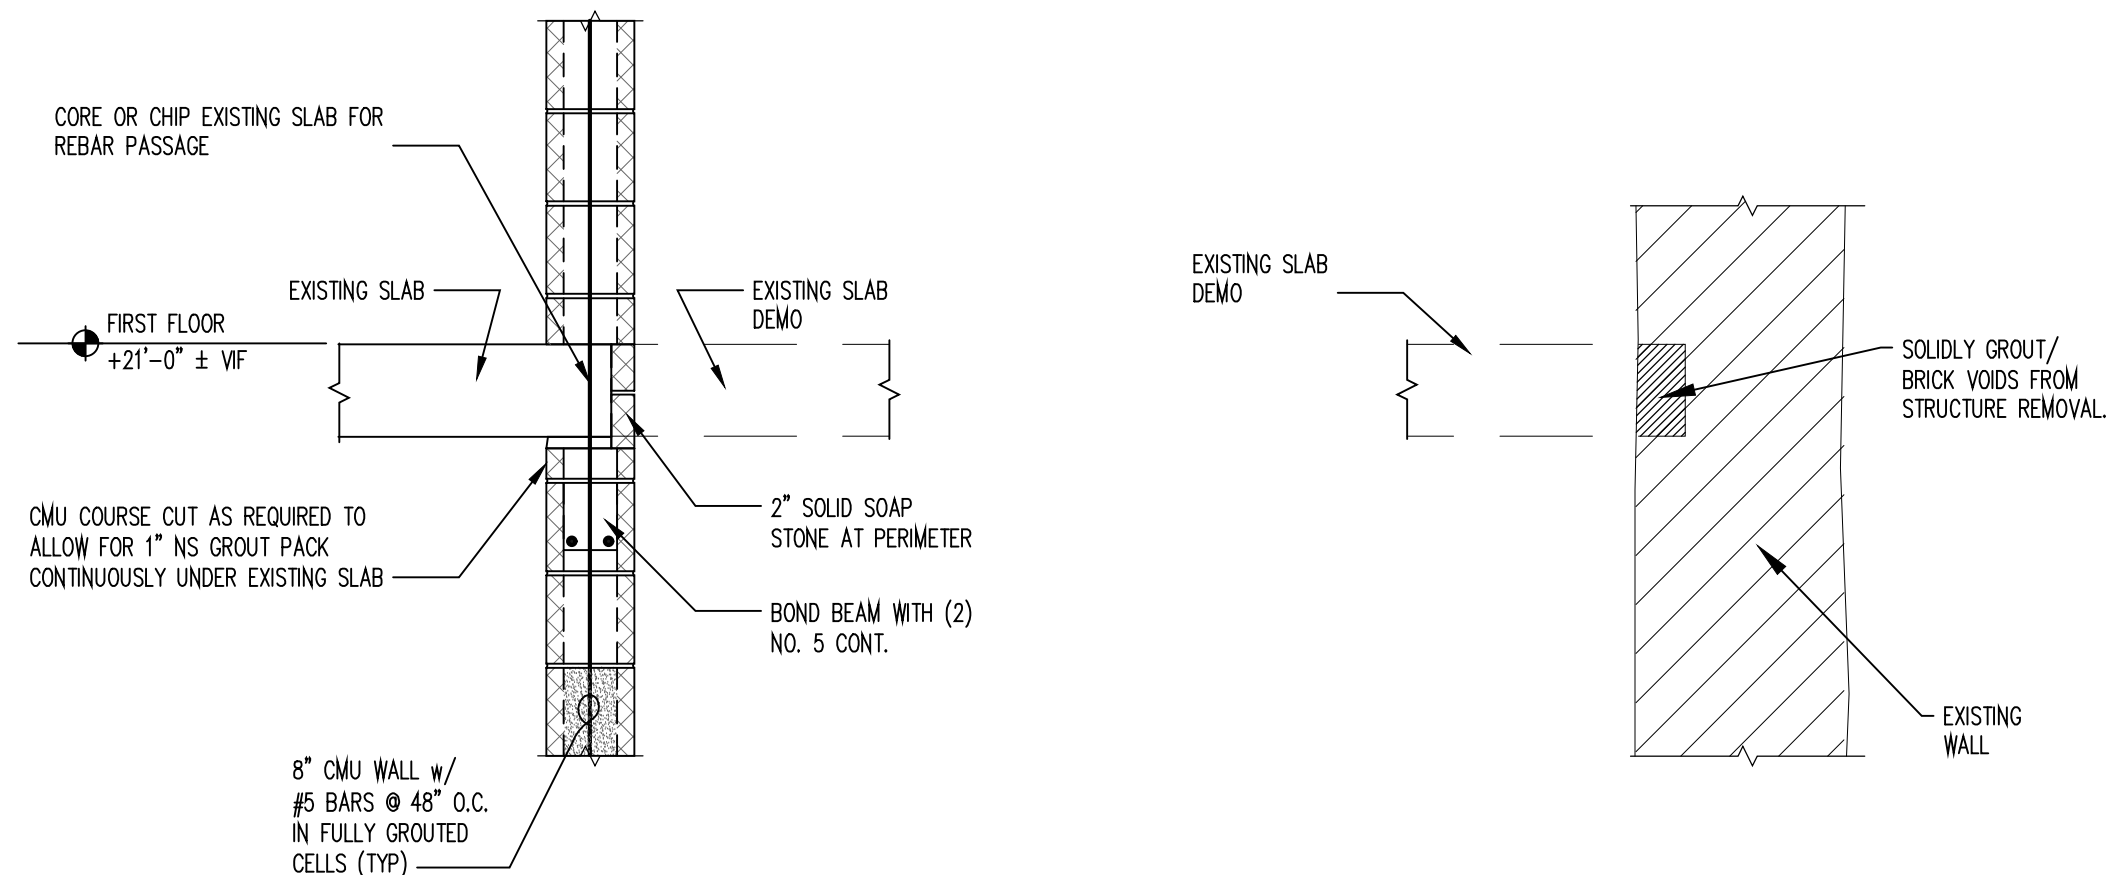
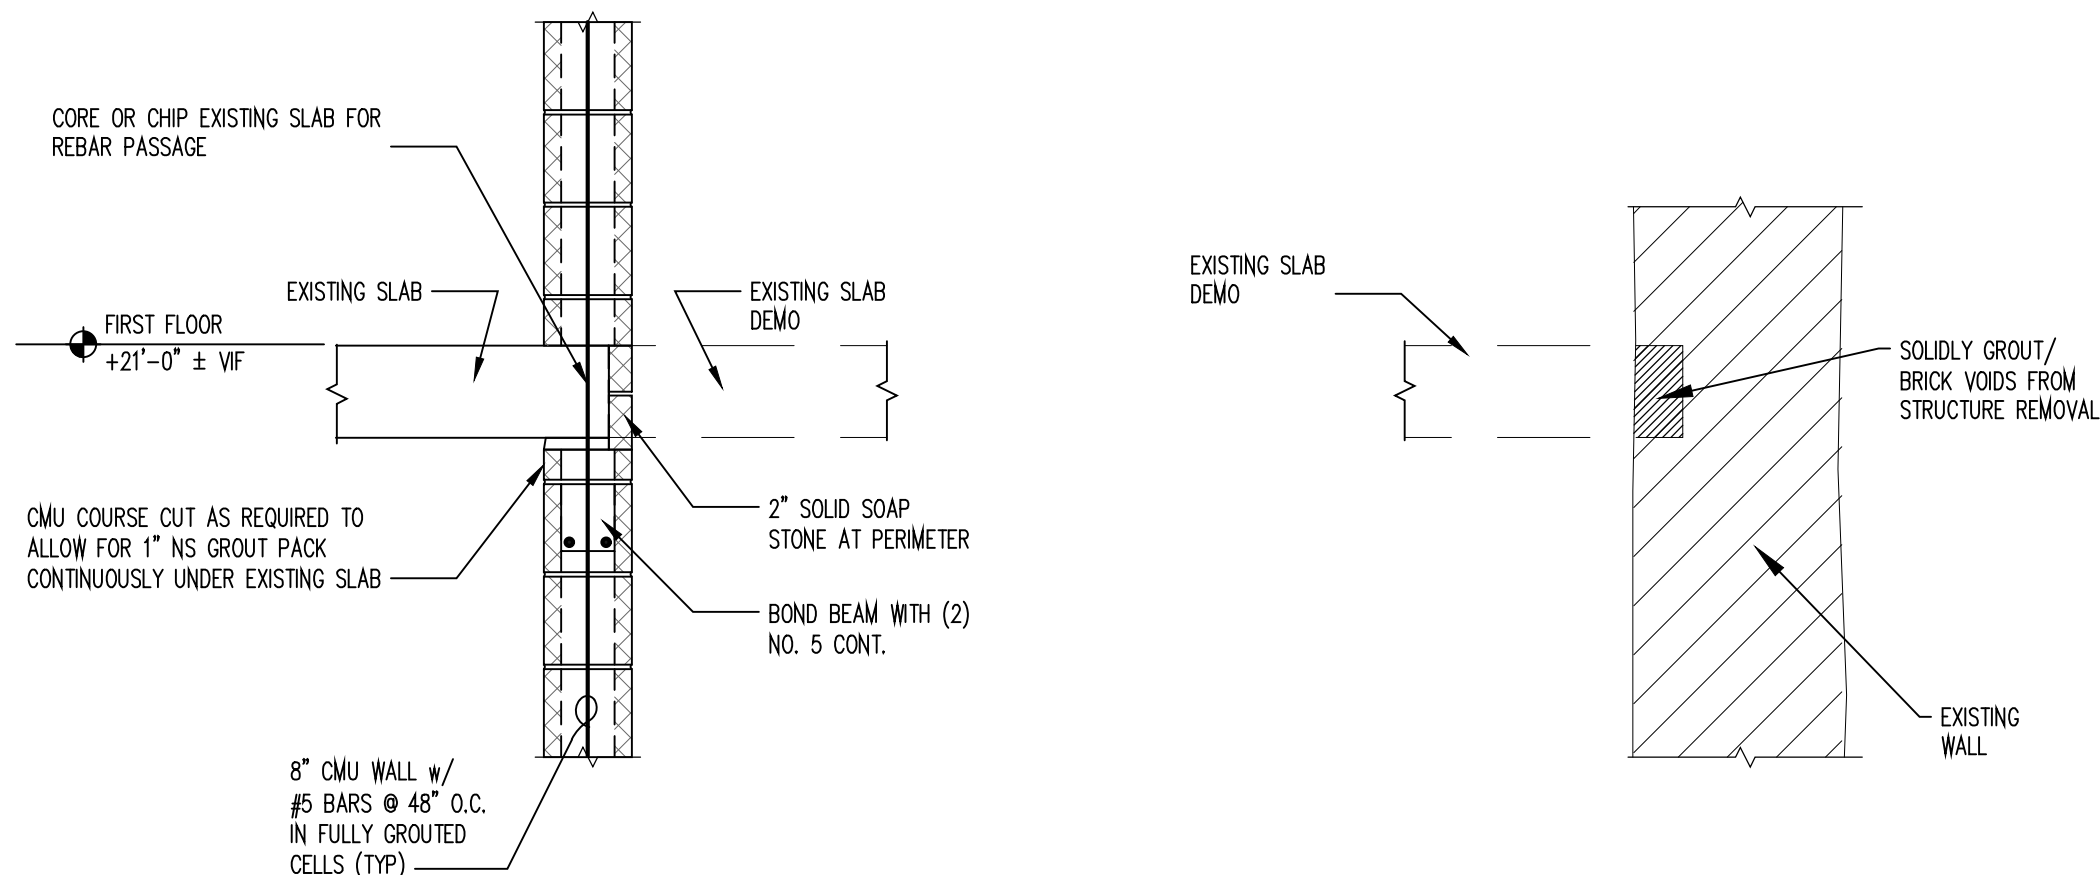
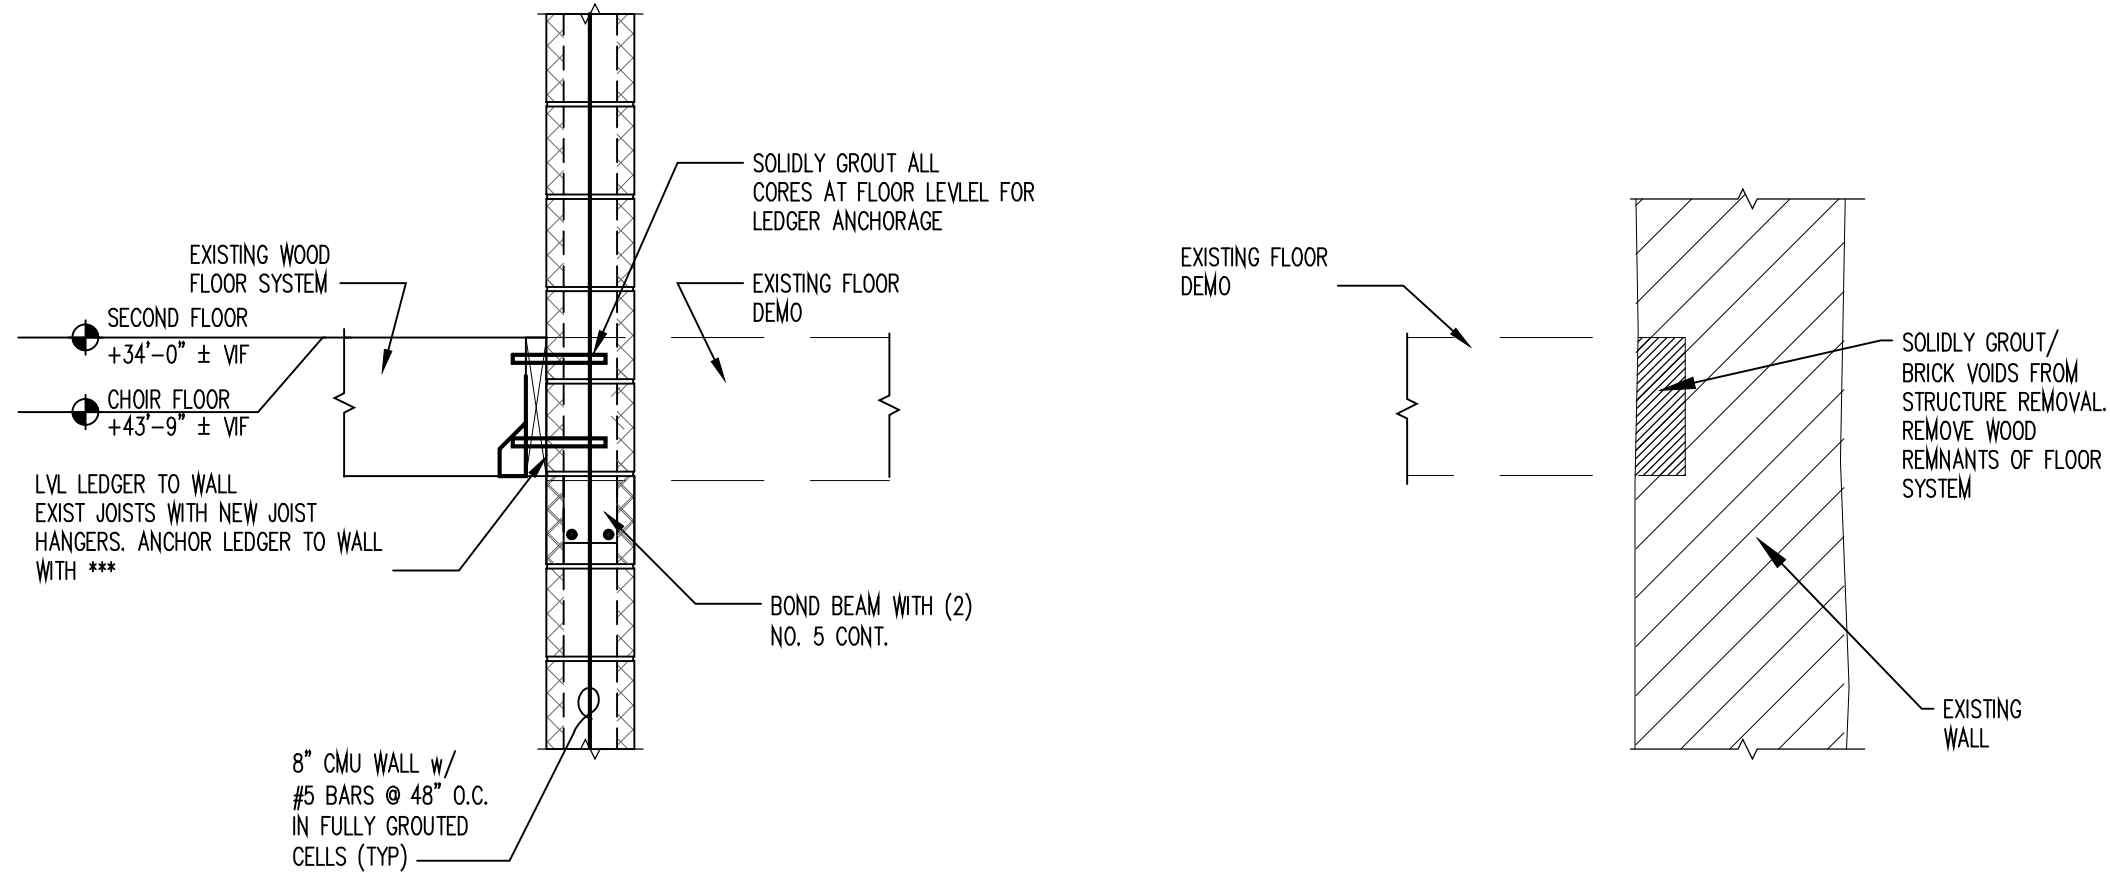
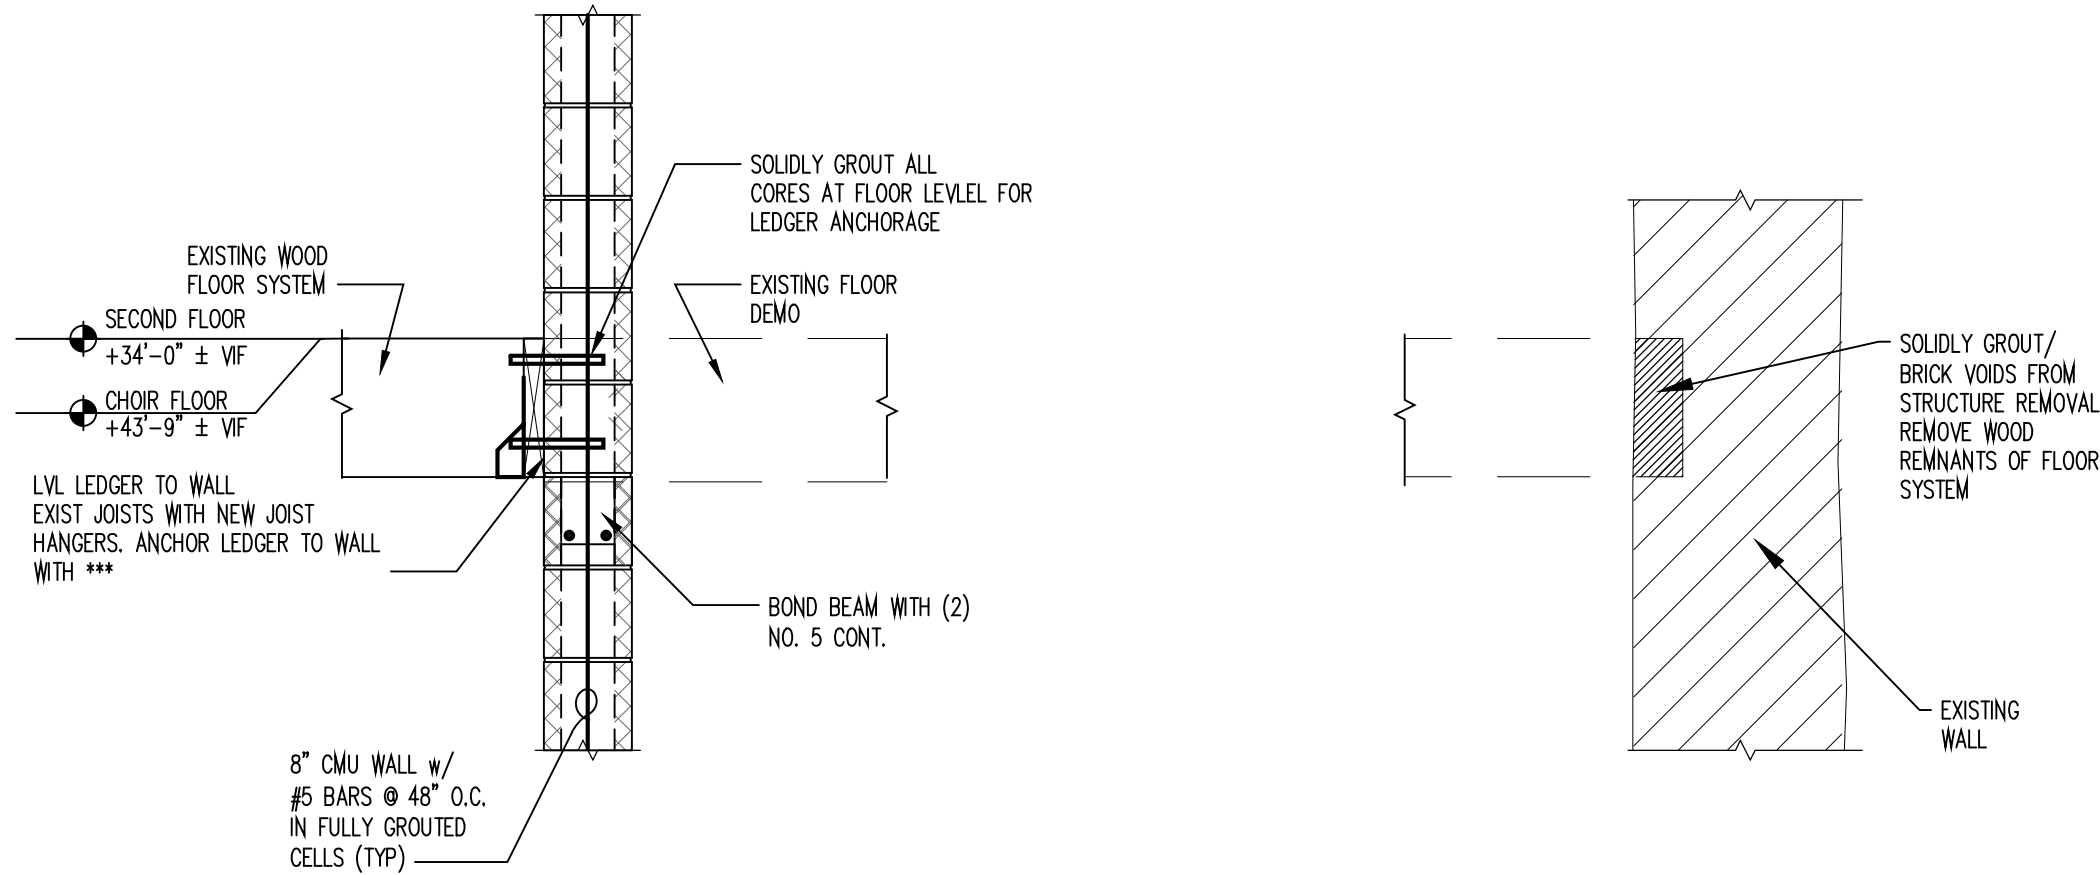
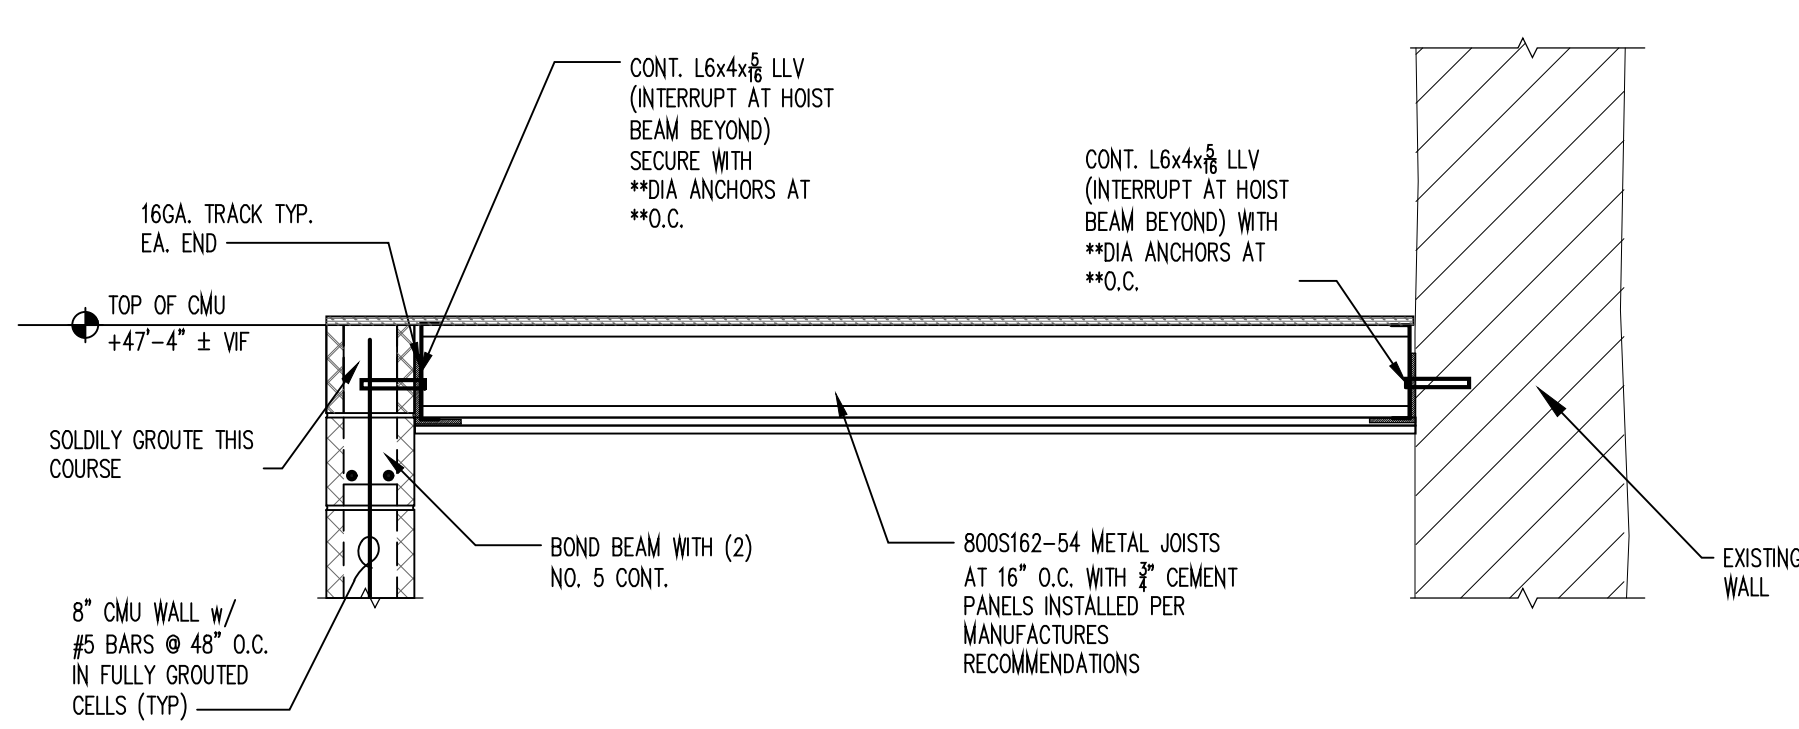
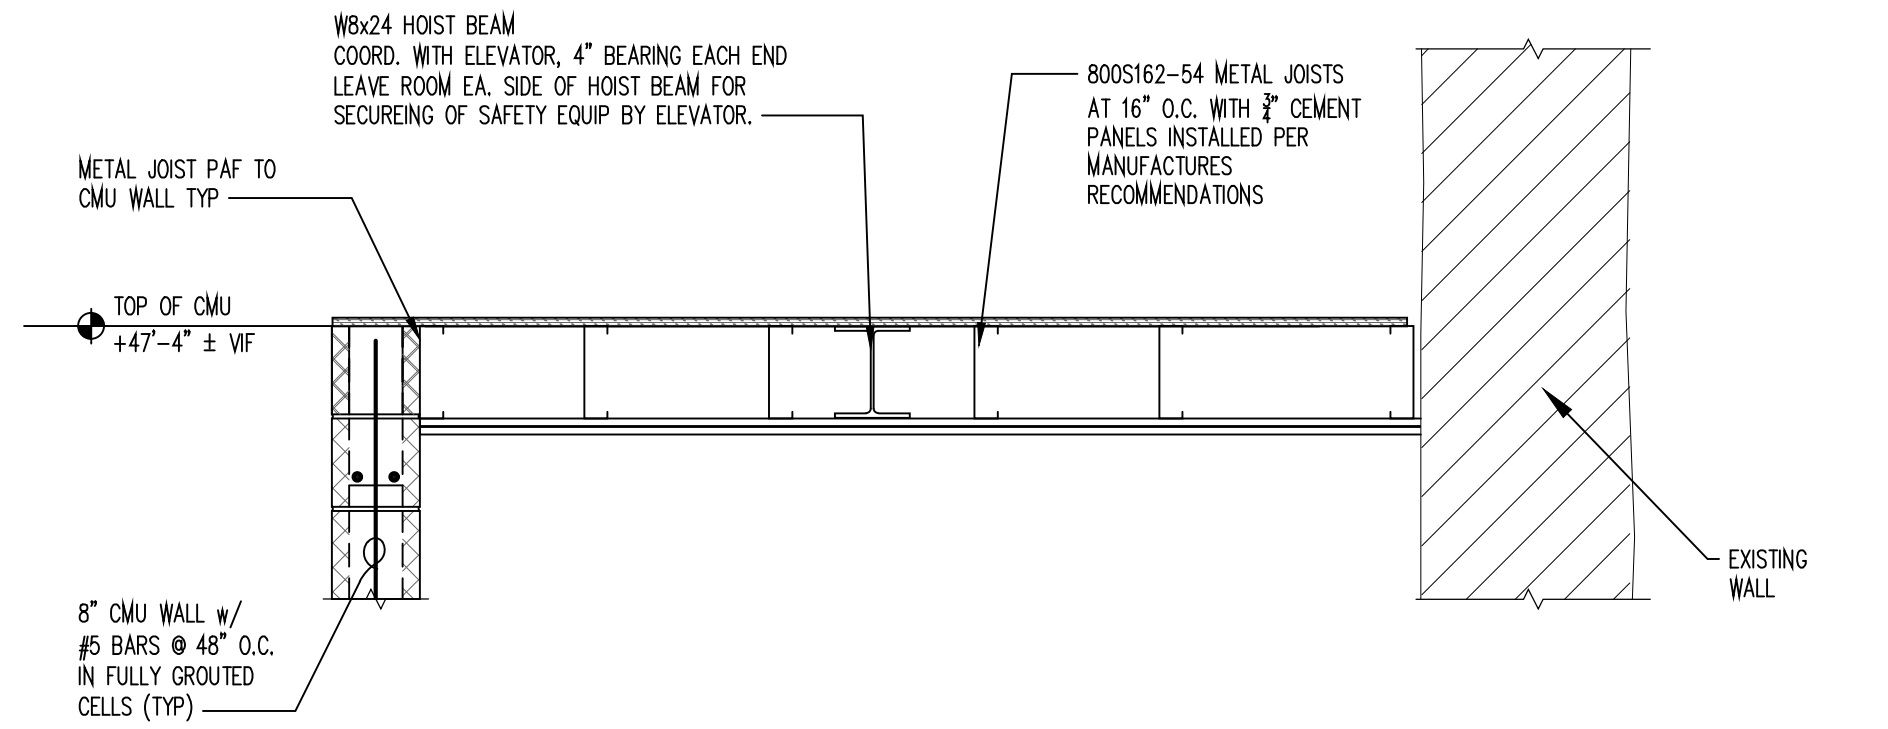
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Drawn By: MB	Checked By: LM

Drawing Title

**DETAILS**

Drawing Number

# S2-02

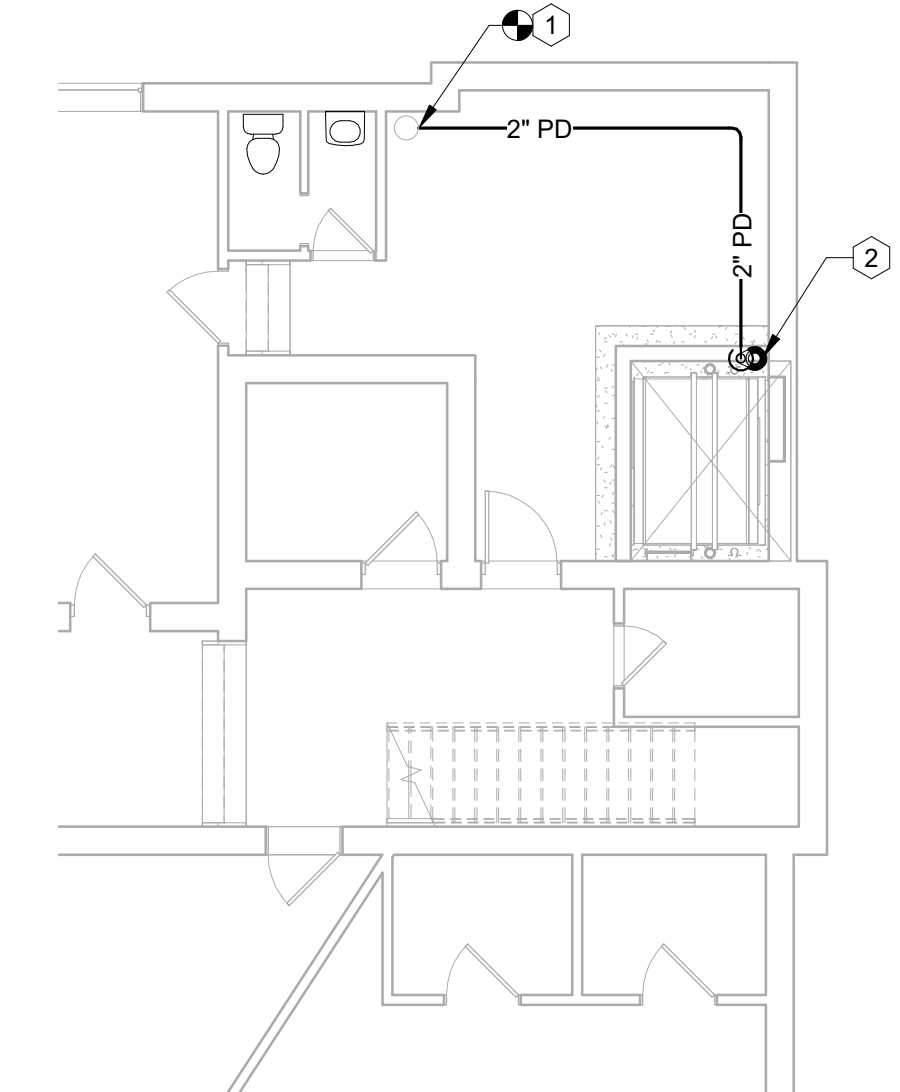


**1 FOUNDATION SECTION**  
SCALE: 3/4" = 1'-0" THRU ELEVATOR PIT

**2 FOUNDATION SECTION**  
SCALE: 3/4" = 1'-0" THRU ELEVATOR PIT

GENERAL PLUMBING NOTES:

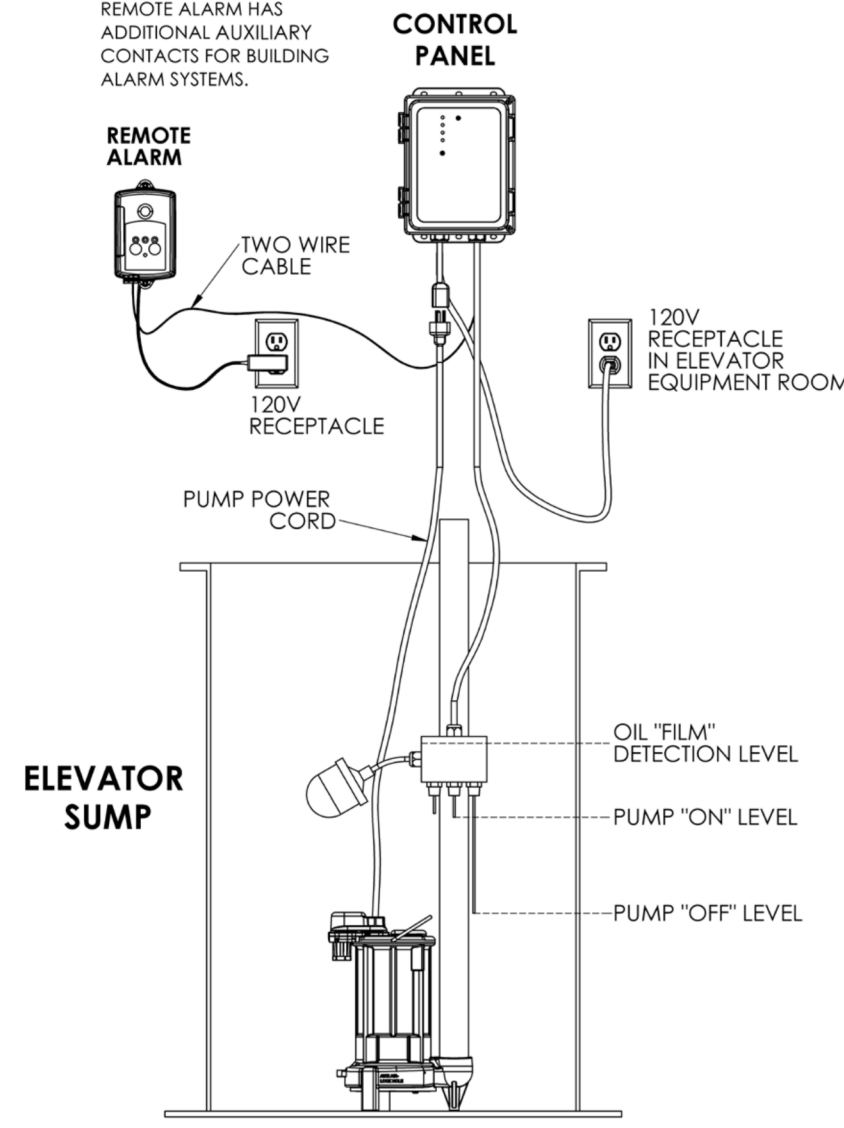
1. PROVIDE FOR THE PROPER FIELD FITTING OF WORK. THE CONTRACTOR SHALL PROVIDE FOR FIELD MEASUREMENTS AS REQUIRED AND SHALL BE RESPONSIBLE FOR FITTING NEW CONSTRUCTION.
2. THIS CONTRACTOR SHALL REVIEW ALL CONTRACT DRAWINGS AND SPECIFICATIONS TO COORDINATE THE PLACEMENT OF PLUMBING WORK WITH THE WORK OF OTHER TRADES.
3. PROVIDE FOR ALL CUTTING, PATCHING, CORE DRILLING AND FIRE STOPPING REQUIRED TO ACCOMPLISH WORK SHOWN FOR THIS TRADE. PATCH AND SEAL OPENINGS TO MATCH EXISTING WALLS, FLOORS, CEILINGS, ETC. UNLESS OTHERWISE INDICATED. ALL WORK IN FINISHED AREAS SHALL BE CONCEALED UNLESS OTHERWISE INDICATED OR DIRECTED BY THE ARCHITECT.
4. PROVIDE ALL MAKE-UP WATER, DRAINS, INDIRECT WASTE DRAINS, ETC. CONNECTIONS TO MECHANICAL EQUIPMENT AS INDICATED ON THE PLANS. COORDINATE WITH OTHER TRADES FOR FINAL CONNECTION POINTS.
5. PROVIDE ALL SUBMITTED EQUIPMENT AND SYSTEMS IN COMPLIANCE WITH THE MANUFACTURERS WRITTEN INSTALLATION INSTRUCTIONS AND SPECIFICATIONS.
6. ALL PHYSICAL ATTRIBUTES OF EQUIPMENT AND DEVICES ARE BASED ON THOSE MANUFACTURERS LISTED IN THE SPECIFICATIONS AND/OR THE EQUIPMENT SCHEDULES. PROVIDE FOR ALL CHANGES BROUGHT ABOUT BY THE USE OF ITEMS SUBMITTED AND BY OTHER MANUFACTURERS AT NO COST TO OWNER. THE ARCHITECT/ENGINEER HAS RESERVED THE RIGHT TO REJECT ITEMS BY OTHER MANUFACTURERS.
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8. PROVIDE ALL MATERIALS, EQUIPMENT, LABOR, ETC. AS REQUIRED TO PERFORM THE CONTRACT WORK. ALL SYSTEMS AND EQUIPMENT SHALL BE COMPLETE AND OPERATIONAL.
9. PLUMBING FIXTURES AND EQUIPMENT IN SPACES ACCESSIBLE TO THE PUBLIC SHALL BE FULLY HANDICAPPED ACCESSIBLE. EQUIPMENT FOR USE IN SPACES SPECIFICALLY DESIGNATED FOR HANDICAPPED USE SHALL BE DESIGNED FOR HANDICAPPED USE AND SHALL CONFORM TO THE AMERICANS WITH DISABILITIES ACT.
10. PROVIDE ALL WORK IN COMPLIANCE WITH ALL LOCAL, STATE, AND FEDERAL CODES AND ORDINANCES, SUCF DESIGN GUIDELINES AS WELL AS ALL APPLICABLE NFPA STANDARDS, AND OTHER REFERENCED STANDARDS.
11. PROVIDE FOR ALL NECESSARY INSPECTIONS PRIOR TO COMPLETION OF WALLS AND CEILINGS. PROVIDE ONE WEEK WRITTEN NOTIFICATION.
12. LOCATE PIPING TO PREVENT FREEZING. DO NOT INSTALL WATER PIPING IN EXTERIOR WALLS.
13. THE DRAWINGS ARE SCHEMATIC IN INTENT. PROVIDE ALL MATERIALS, EQUIPMENT, AND LABOR NECESSARY FOR A COMPLETE INSTALLATION. ADJUST THE LOCATION OF ALL PIPING, STACKS, EQUIPMENT, AND CONNECTIONS TO ACCOMMODATE ACTUAL CONSTRUCTION CONDITIONS ENCOUNTERED; OBTAIN APPROVAL FROM THE ARCHITECT FOR ALL BUT MINOR CHANGES. ALL EQUIPMENT SHALL BE INSTALLED TO BE FULLY ACCESSIBLE FOR OPERATION AND MAINTENANCE IN ACCORDANCE WITH MANUFACTURER'S INSTALLATION REQUIREMENTS.
14. ALL PIPES PENETRATING RATED WALLS AND FLOOR DECKS SHALL BE FIRESTOPPED USING APPROVED, U.L. LISTED FIRE STOPPING MATERIAL. REFER TO THE ARCHITECTURAL DRAWINGS FOR FIRE RATED WALL AND FLOOR LOCATIONS; CONFIRM ALL LOCATIONS WITH ARCHITECTURAL DRAWINGS.
15. PROVIDE ALL EQUIPMENT IN COMPLETE COMPLIANCE WITH MANUFACTURERS INSTALLATION INSTRUCTIONS, AND THE PROJECT SPECIFICATIONS.
16. PROVIDE ACCESS PANELS FOR ALL VALVES, WATER HAMMER ARRESTORS, CLEANOUTS, FAUCET / FLUSH VALVE TRANSFORMERS, ETC CONCEALED BEHIND WALLS AND ABOVE CEILINGS, WHERE OTHERWISE INACCESSIBLE. PROVIDE FIRE RATED WHERE ARCHITECTURAL DRAWINGS SHOW RATING. ACCESS PANELS TO MATCH RATING FOR WALL/CEILING.
17. PROVIDE A PRODUCT SUBMITTAL FOR ANY PRODUCTS TO BE INSTALLED THAT ARE NOT IDENTIFIED IN THE PROJECT MANUAL OR ON THE DRAWINGS.
18. TEST ALL EQUIPMENT AND PIPING SYSTEMS FOR PROPER OPERATION. PROVIDE FOR PRESSURE TESTING OF ALL PIPING AND EQUIPMENT IN COMPLIANCE WITH THE 2020 PLUMBING CODE OF NEW YORK STATE AND IN ACCORDANCE WITH MANUFACTURERS REQUIREMENTS. PROVIDE COPIES OF TEST REPORTS IN THE FINAL O&M MANUALS.
19. PROVIDE RECORD DRAWINGS DEPICTING THE LOCATIONS OF PIPING, EQUIPMENT, VALVES, AND CLEANOUTS AS-BUILT ON A CLEAN SET OF DRAWINGS. PROVIDE FULL SIZE COPIES FOR THE OWNER, ARCHITECT AND ENGINEER. PROVIDE COPIES OF THE OPERATION AND MAINTENANCE MANUALS TO OWNER INCLUDING ALL PRODUCTS AND MECHANICAL EQUIPMENT IN COMPLIANCE WITH THE CONTRACT REQUIREMENTS. RECORD DRAWINGS SHALL BE PROVIDED ON THE ORIGINAL BID DOCUMENT PLANS AS SUPPLIED BY THE ARCHITECT. CONTRACTOR SHALL OBTAIN THE ORIGINAL BID DOCUMENTS AND PERMISSION FOR THE USE FROM THE ARCHITECT.
20. PROVIDE FOR ALL ACCESSORIES, INCLUDING HANGERS, SUPPORTS, CONTROLS, INSULATION, VALVES, AS REQUIRED FOR A COMPLETE INSTALLATION.
21. ALL ROOF WORK REQUIRED INCLUDING CUTTING AND PATCHING SHALL BE PROVIDED TO COMPLY WITH ROOFING MANUFACTURER'S WRITTEN REQUIREMENTS AND SHALL COMPLY WITH ALL WARRANTY CONDITIONS.
22. MINIMUM SLOPE FOR DRAINAGE PIPE WITHIN 5'-0" OF BUILDING IS 1/4" PER FOOT FOR 2-1/2" DIAMETER AND LESS AND 1/8" PER FOOT FOR 3" DIAMETER AND GREATER.
23. DOMESTIC HOT WATER SHALL BE SUPPLIED TO PLUMBING FIXTURES AT 140 DEGREES F. ALL INDIVIDUAL LAVATORIES, SINKS AND MOP SINKS SHALL BE PROVIDED WITH ASSE 1070 POINT OF USE MIXING DEVICES DESIGNED TO FAIL TO COLD WATER.
24. PROVIDE FOR PAINTING OF ALL EXPOSED PIPING. SANITARY, VENT, STORM AND NATURAL GAS SHALL BE COATED WITH A RUST INHIBITOR, PRIMED AND PAINTED. EXPOSED INSULATION ON DOMESTIC COLD, HOT AND HOT WATER RECIRCULATION PIPING SHALL BE FINISHED PAINTED. REFER TO ARCHITECTURAL PLANS AND SPECIFICATIONS FOR PAINTING REQUIREMENTS.
25. ALL PLUMBING FIXTURE AND EQUIPMENT WATER CONNECTIONS SHOULD BE SUPPLIED WITH LINE-SIZE BALL VALVES FOR ISOLATION.



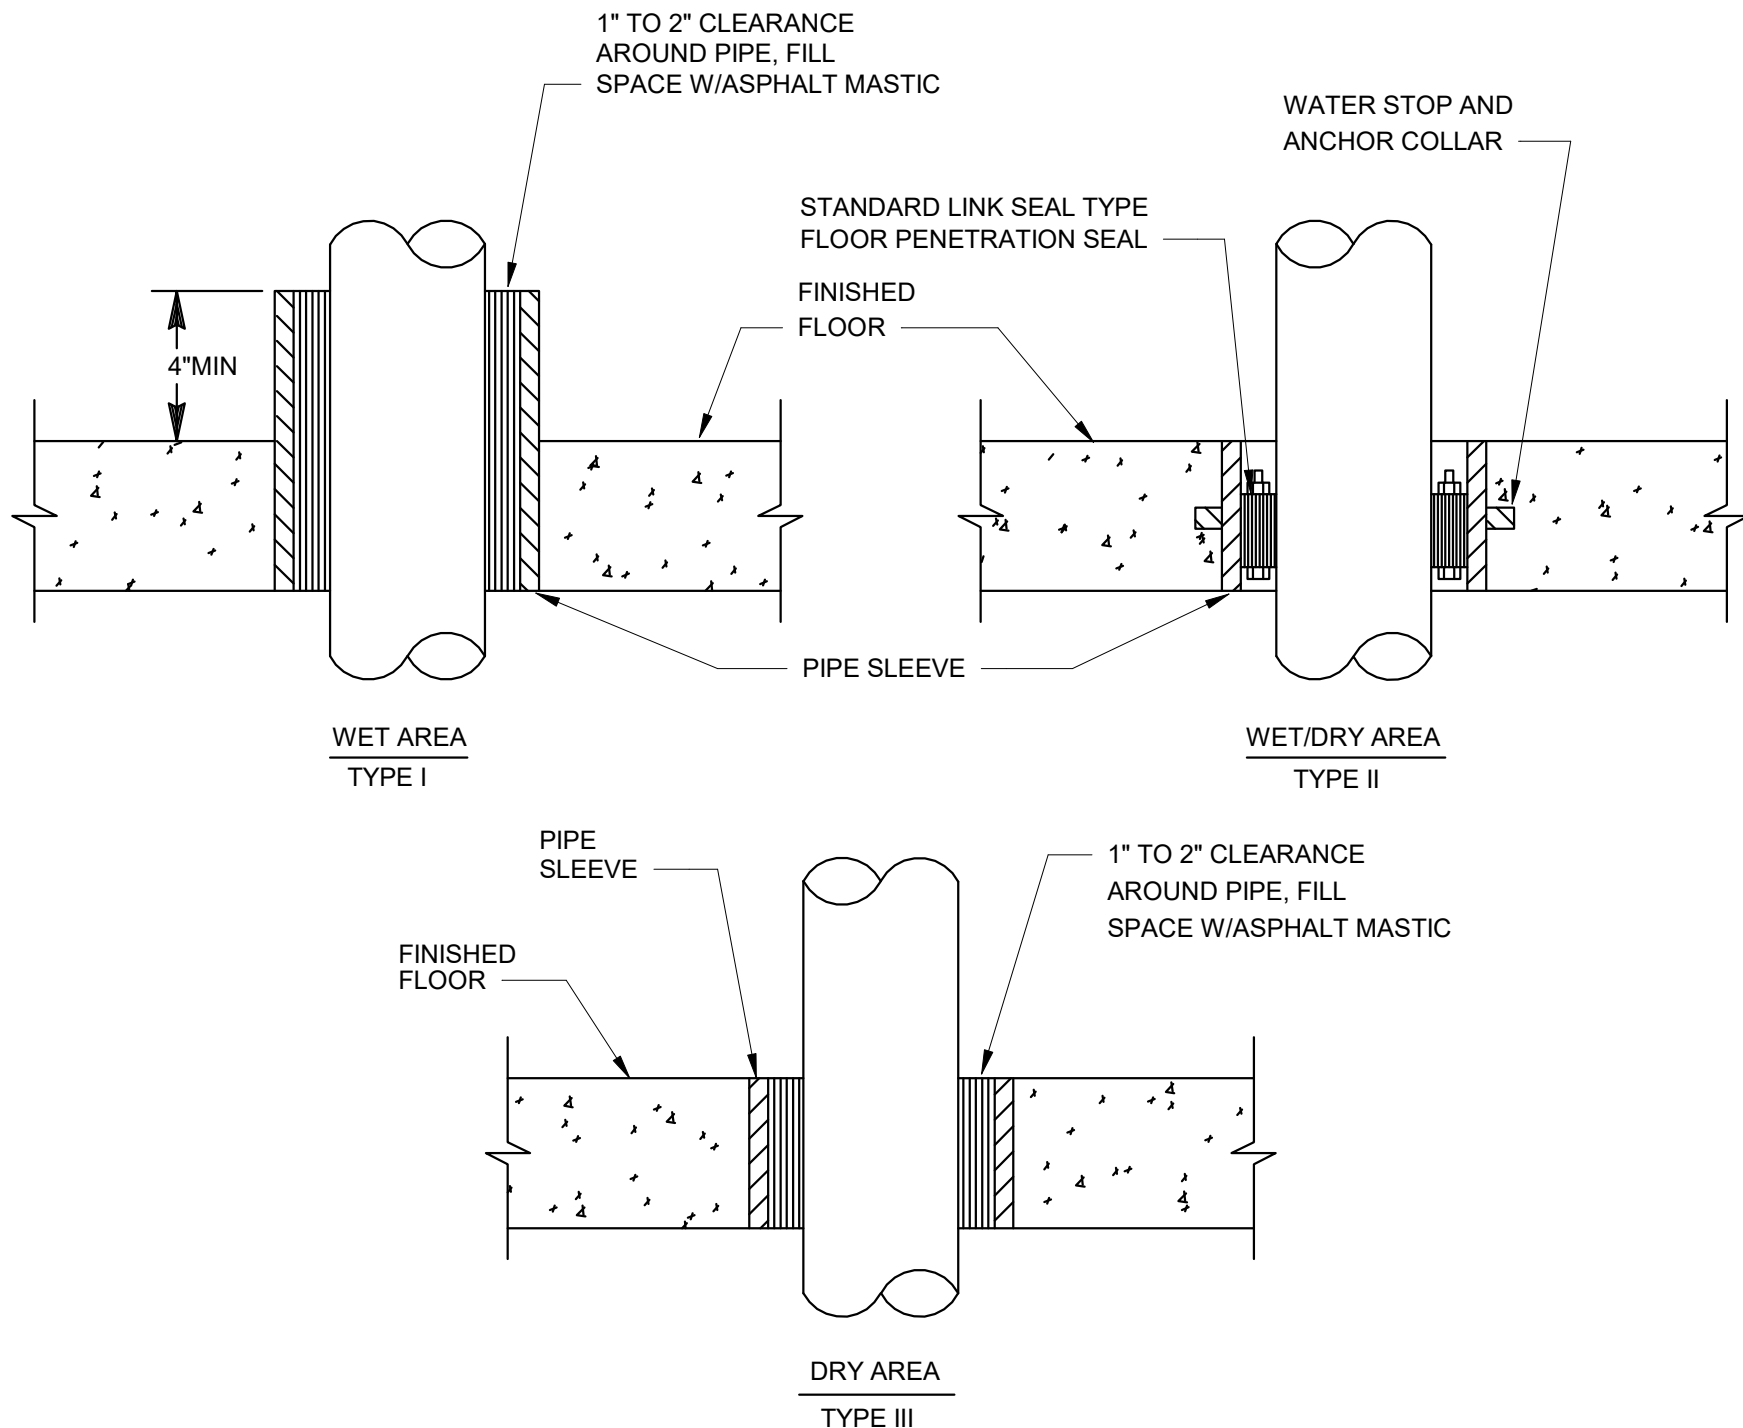
1 GROUND FLOOR PLUMBING PLAN  
1/8" = 1'-0"

P1-01 DRAWING NOTES

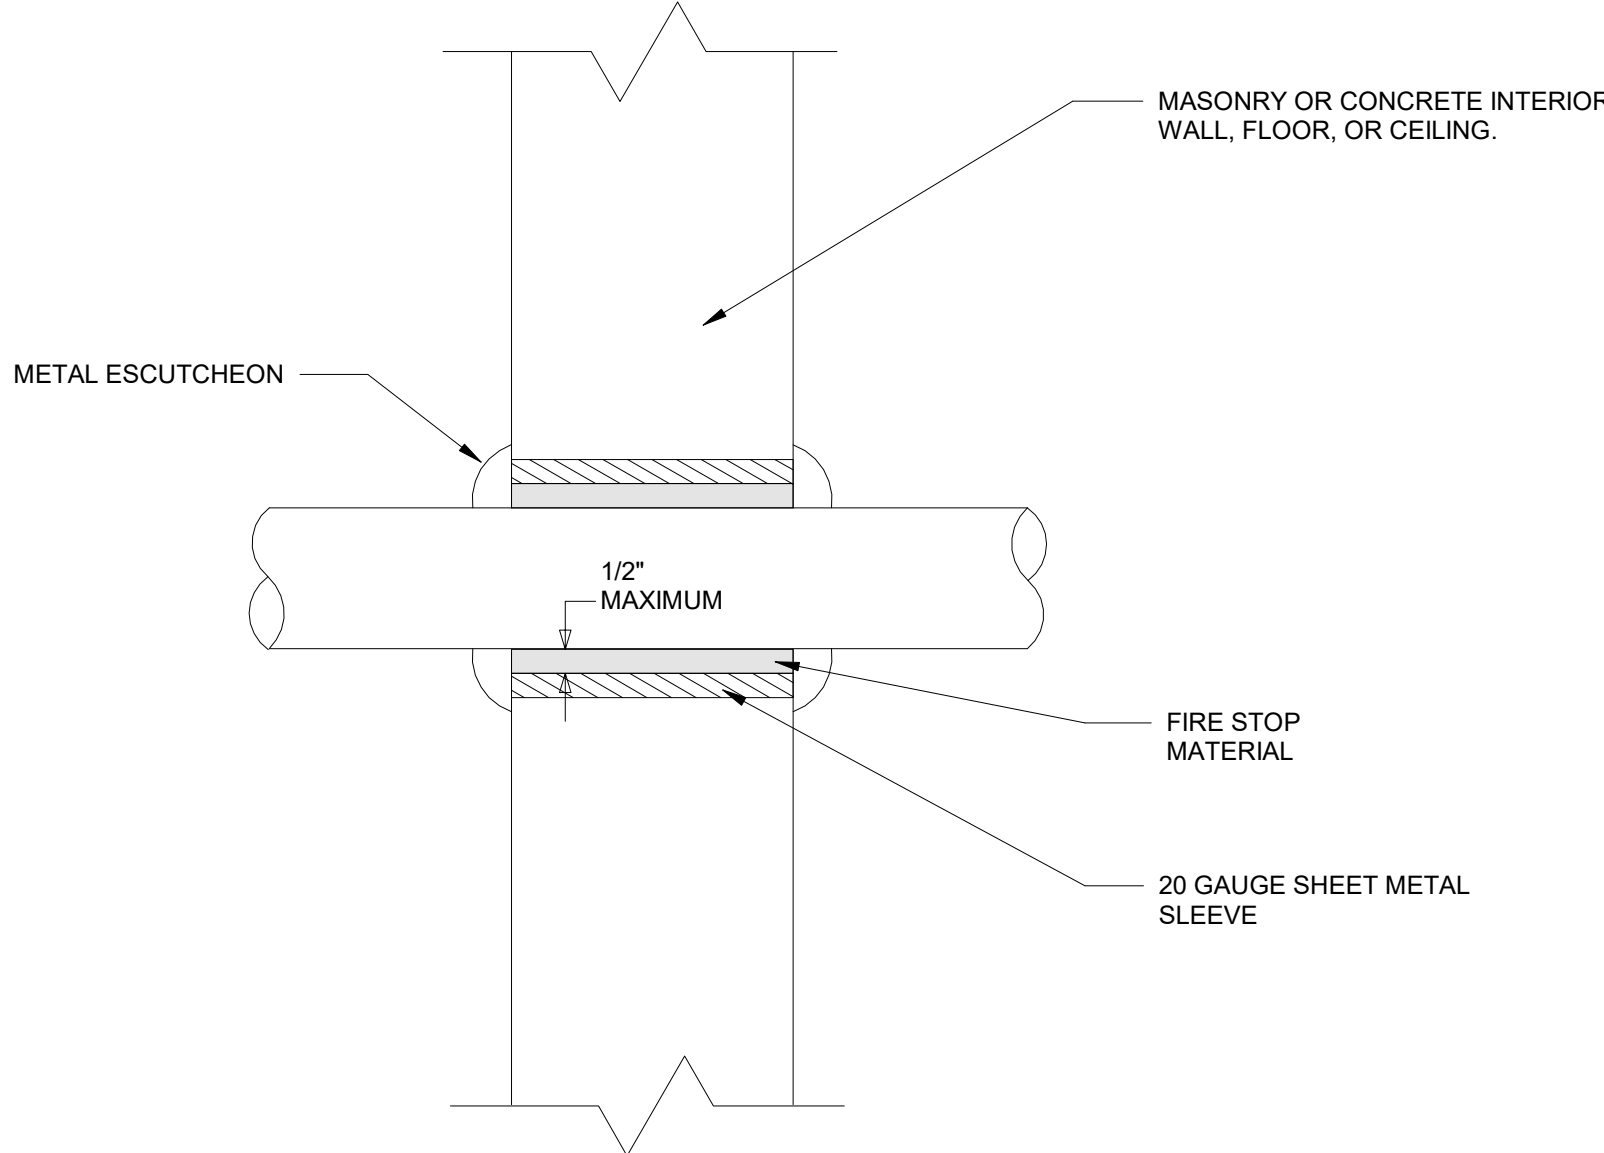
#	NOTE
1	PROVIDE 2" PUMPED DISCHARGE CONNECTION TO EXISTING 4" WASTE STACK. FIELD VERIFY EXACT LOCATION OF STACK.
2	PROVIDE ELEVATOR SUMP PUMP, WITH OIL SENSOR AND ALARM, 25 GPM @ 16FT. HEAD, 1/3HP, 120V, LIBERTY PUMPS ELV250 OR EQUIVALENT. PROVIDE SILENT CHECK VALVE IN DISCHARGE RISER. COORDINATE WITH ELEVATOR CONTRACTOR AND G.C.



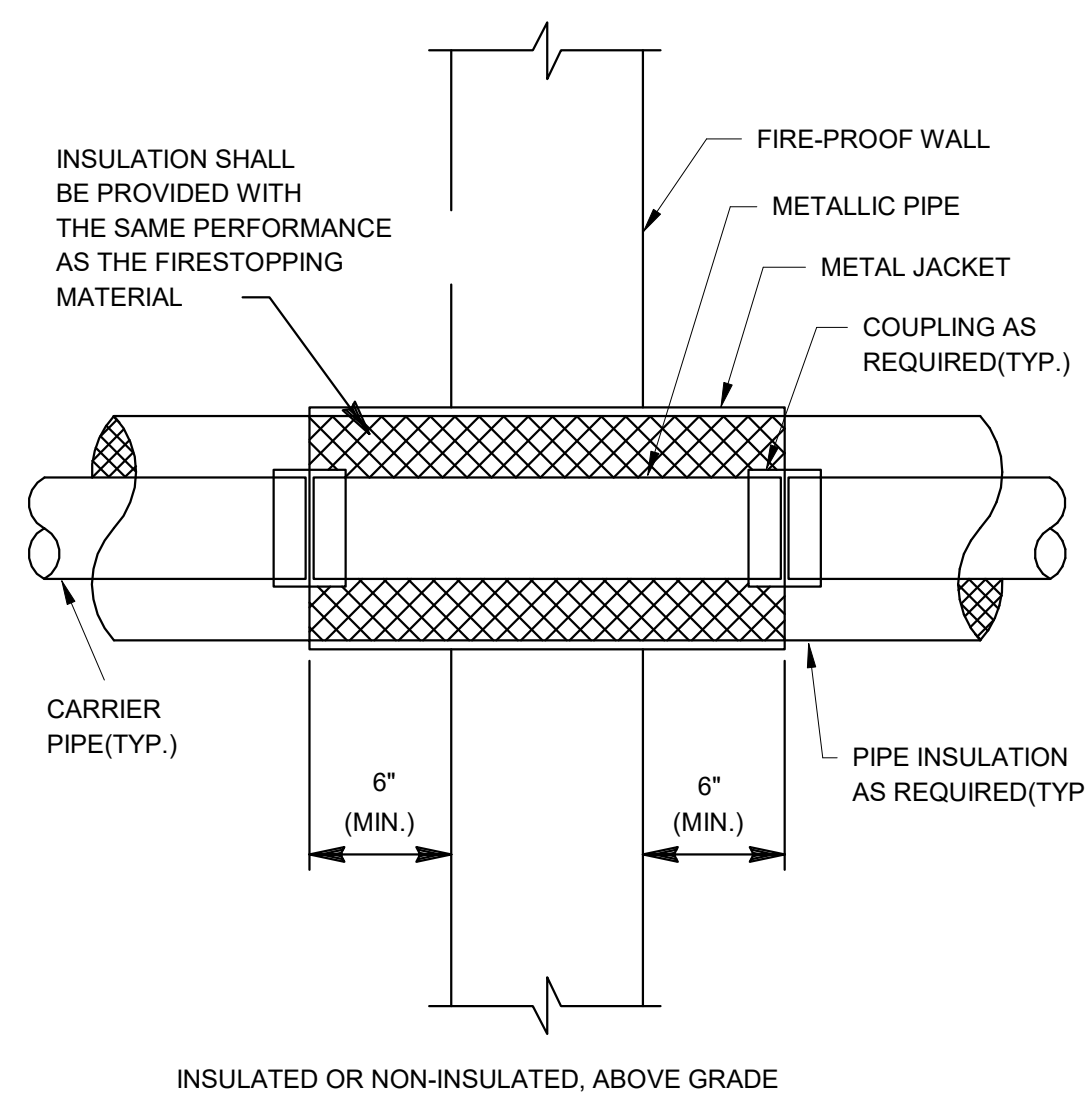
2 SUMP PUMP DETAIL



3 WATER-PROOF MEMBRANE PIPE PENETRATION

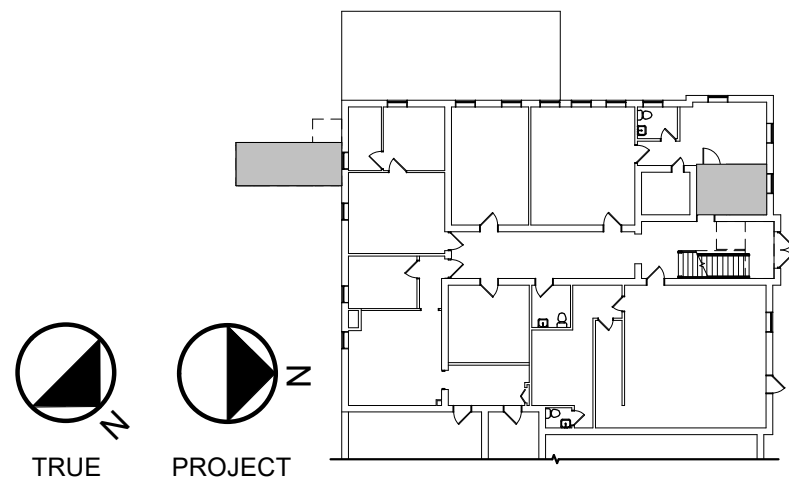


4 PIPE PENETRATION - INTERIOR WALL DETAIL



5 FIRE-PROOF WALL PENETRATION DETAIL

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DATE 04/02/2020



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PERRY, NY 14530

100% CONSTRUCTION DOCUMENT SUBMISSION

NOTES & REVISIONS:

Revision Schedule		
Revision Number	Date	Description

DRAWING ISSUED: APRIL 5, 2021

Project Number: 00370 Scale: As indicated

Drawn By: JD Checked By: AP

Drawing Title  
FIRST FLOOR PLAN - PLUMBING

Drawing Number

P1-01

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SYMBOLS AND ABBREVIATIONS:

- T

S

(E)

AHU

BOD

CFM

DSD

EA

EC

EWT

FA

G.C.

GWR

GWS

HP

IN. W.G.

LWT

MCA

MOCP

O.E.D

OA

PC

PSC

RA

RLA

SA

SF

SEER

SMACNA

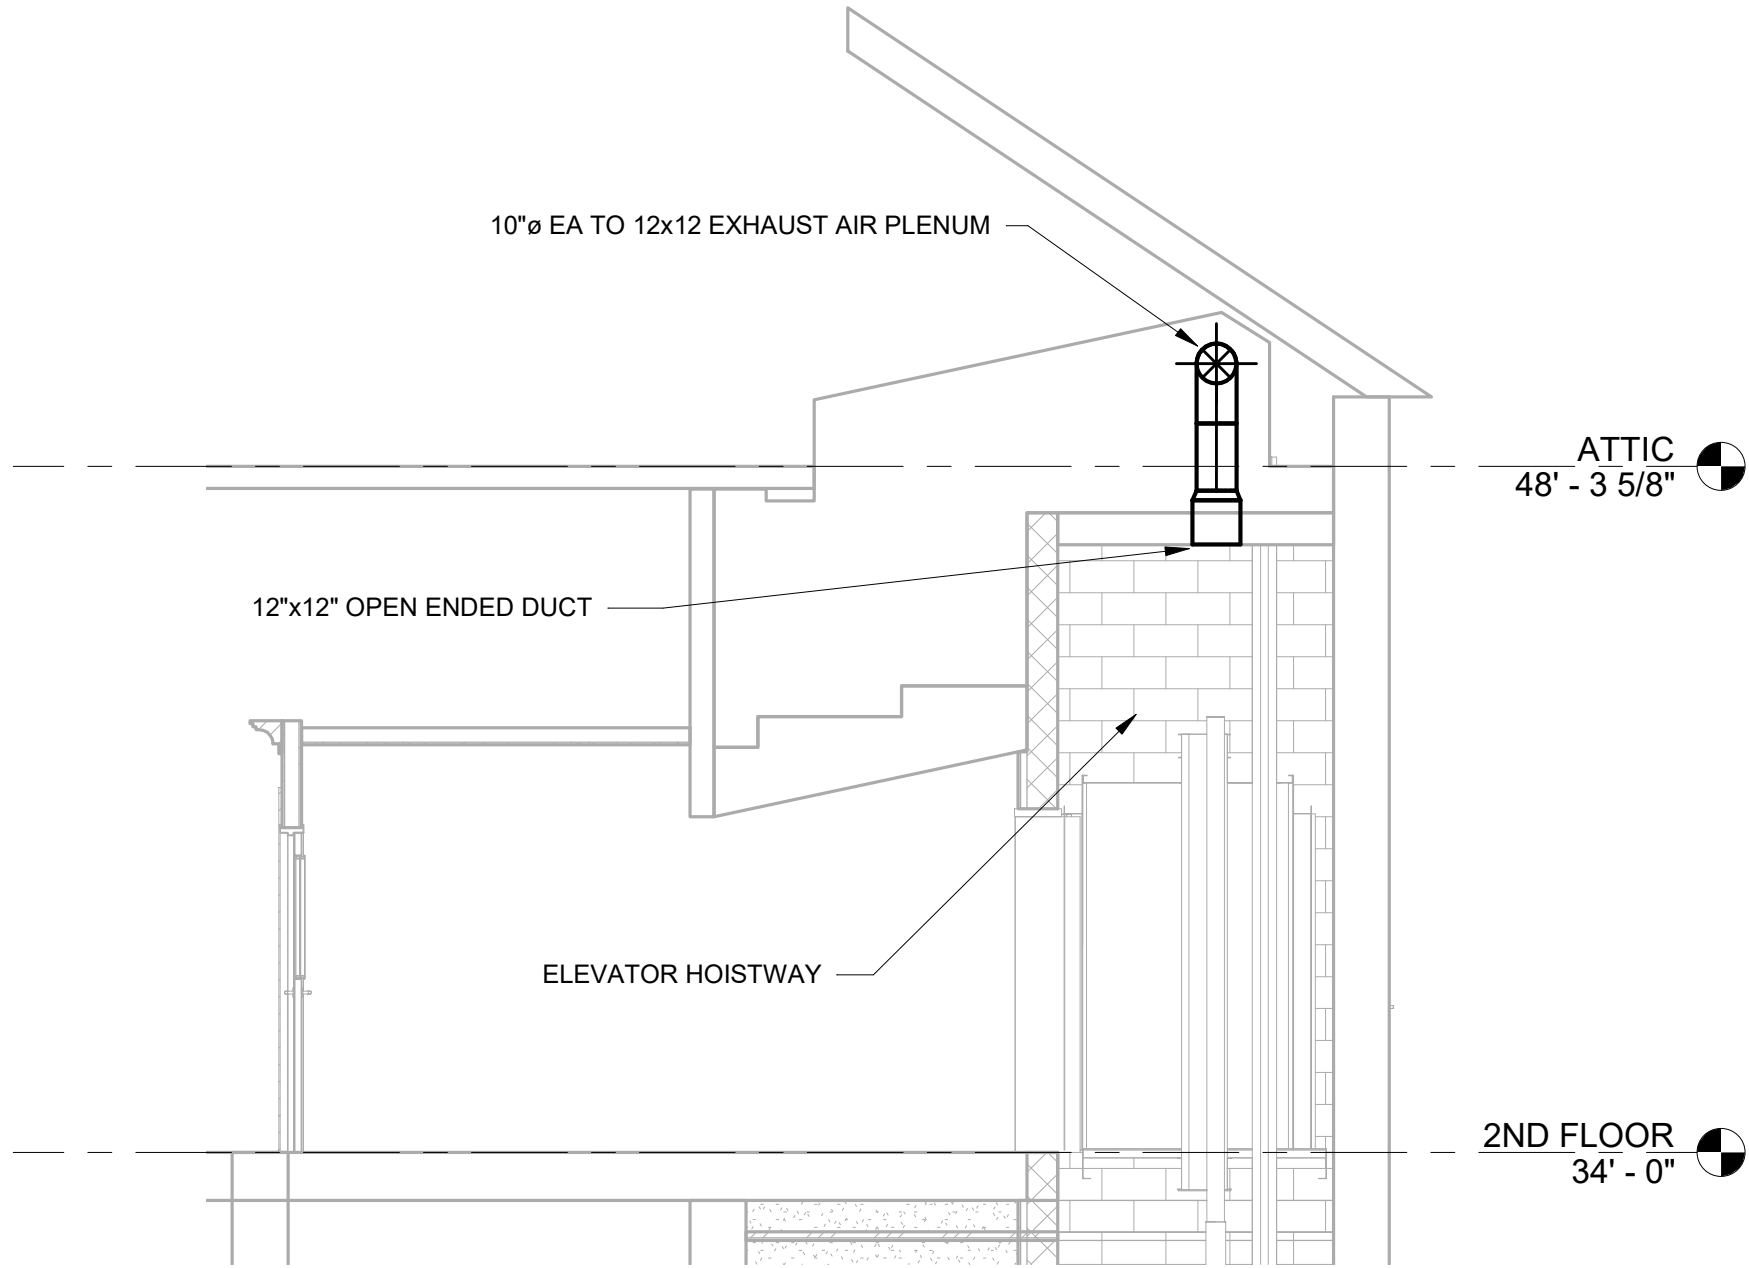
XFR

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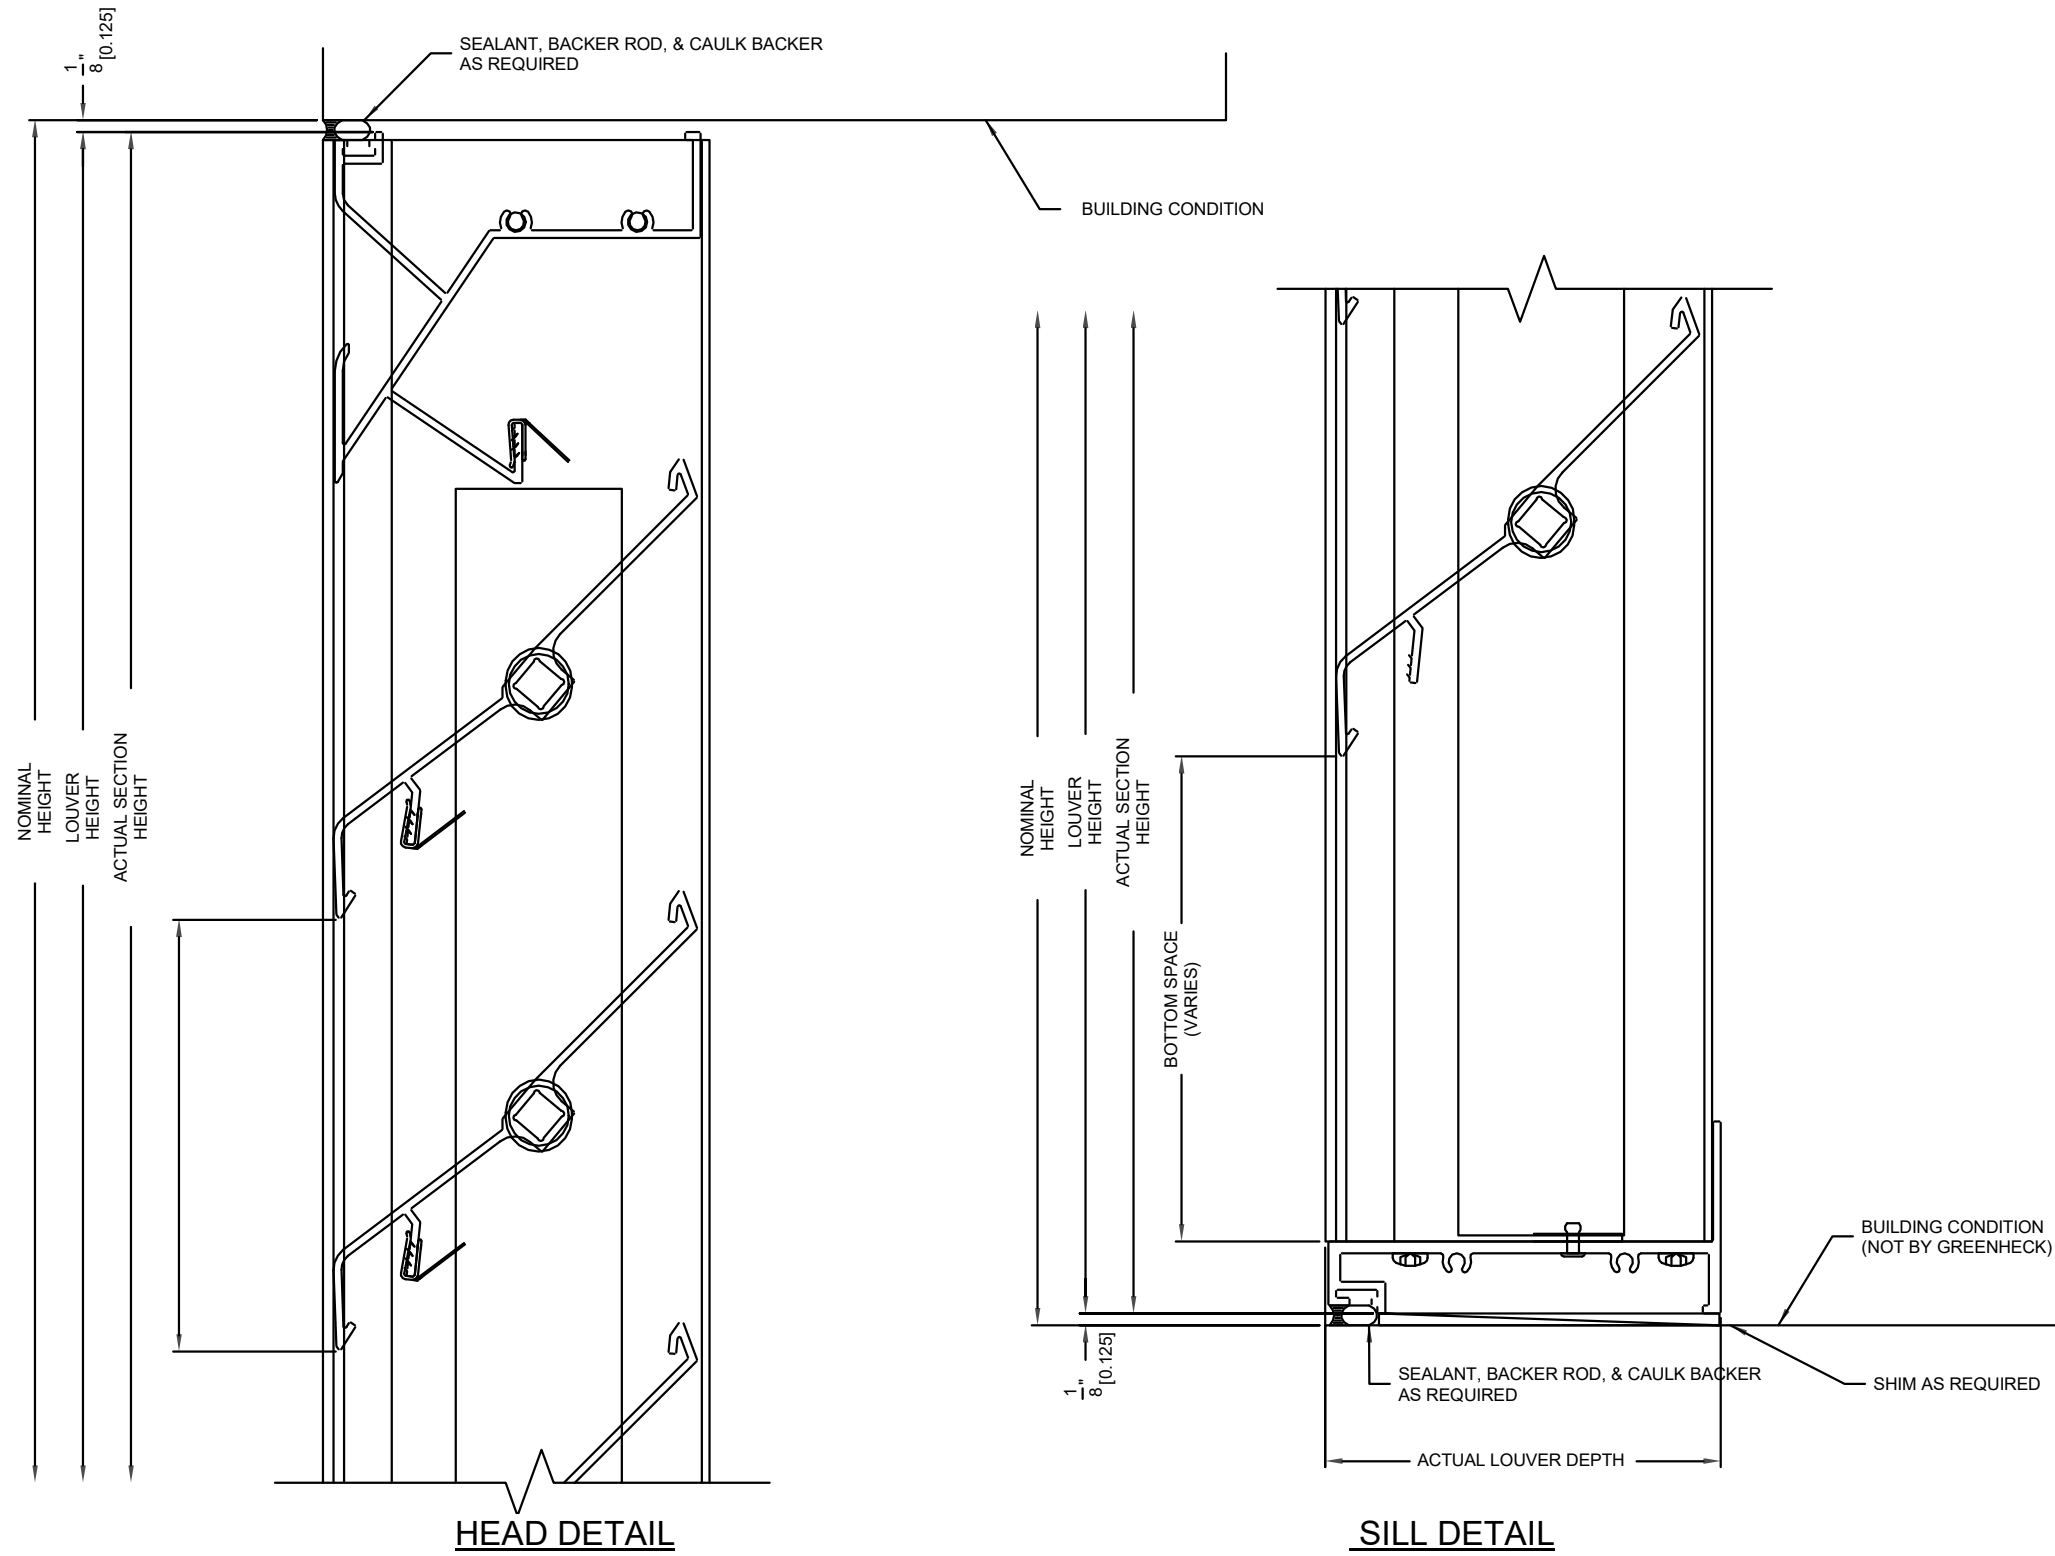
250
- TERMOSTAT  
TEMPERATURE SENSOR  
EXISTING TO REMAIN  
AIR HANDLING UNIT  
BOTTOM OF DUCT ELEVATION  
CUBIC FEET PER MINUTE  
DUCT SMOKE DETECTOR  
EXHAUST AIR  
ELECTRICAL CONTRACTOR  
ENTERING WATER TEMPERATURE  
FRESH AIR  
GENERAL CONTRACTOR  
GLYCOL WATER RETURN  
GLYCOL WATER SUPPLY  
HEAT PUMP  
INCHES OF WATER GAUGE (COLUMN)  
LEAVING WATER TEMPERATURE  
MINIMUM CURRENT AMPACITY  
MAXIMUM OVERCURRENT PROTECTION  
OPEN ENDED DUCT  
OUTDOOR AIR  
PLUMBING CONTRACTOR  
PERMANENT SPLIT CAPACITOR MOTOR  
RETURN AIR  
RATED LOAD AMPS  
SUPPLY AIR  
SUPPLY FAN  
SEASONAL ENERGY EFFICIENCY RATIO  
SHEET METAL AND AIR CONDITIONING CONTRACTORS NATIONAL ASSOCIATION TRANSFER  
DIFFUSER / REGISTER TAG  
DIFFUSER / REGISTER CFM

FAN SCHEDULE							
TAG	CFM	ESP	TYPE	MOTOR HP	VOLTS	MANUFACTURER	MODEL
EF-1	350	.35	INLINE	1/10	120V	GREENHECK	SQ-80-VG

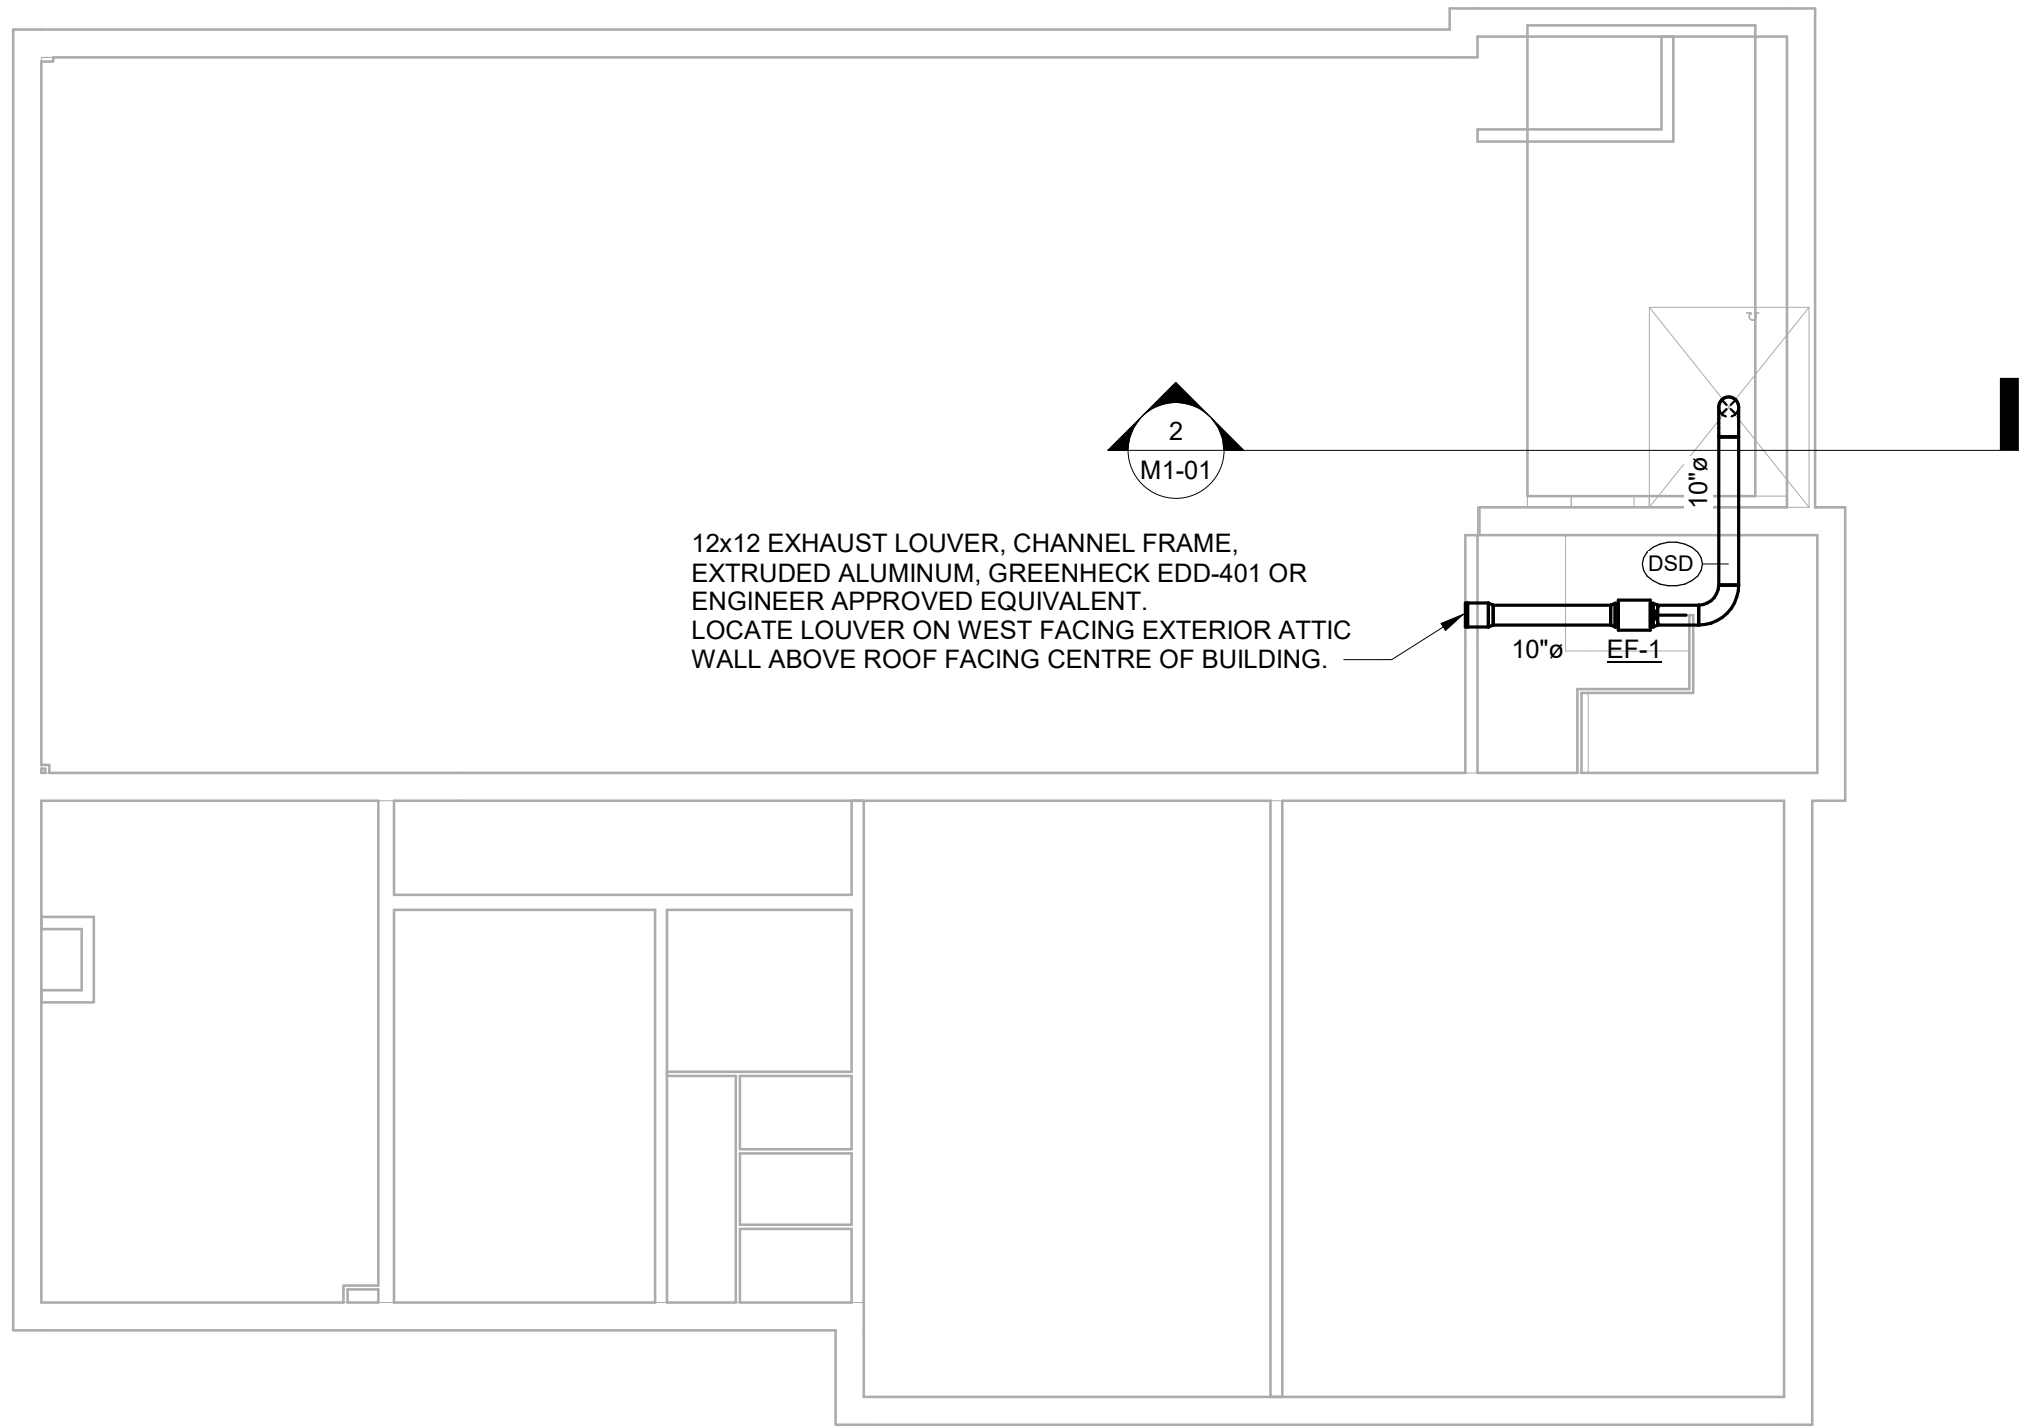
- NOTES:  
1. PROVIDE WITH DISCONNECT  
2. PROVIDE WITH BACKDRAFT DAMPER.  
3. PROVIDE WITH IAQ TEMP/HUMIDITY CONTROL.  
4. PROVIDE WITH DUCT MOUNT SMOKE DETECTOR, WIRED TO SHUT FAN DOWN UPON SMOKE DETECTION.



2 ELEVATOR EXHAUST FAN SECTION VIEW  
1/4" = 1'-0"

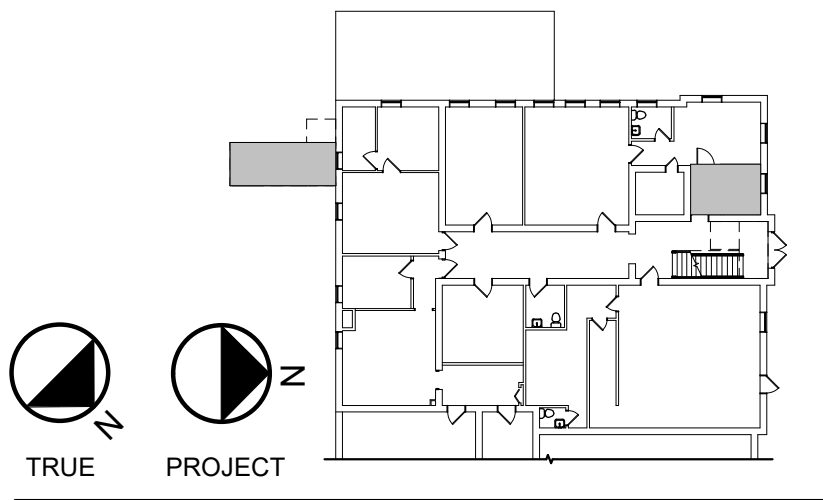


3 LOUVER DETAIL  
6" = 1'-0"



1 ATTIC PLAN - MECHANICAL  
1/8" = 1'-0"

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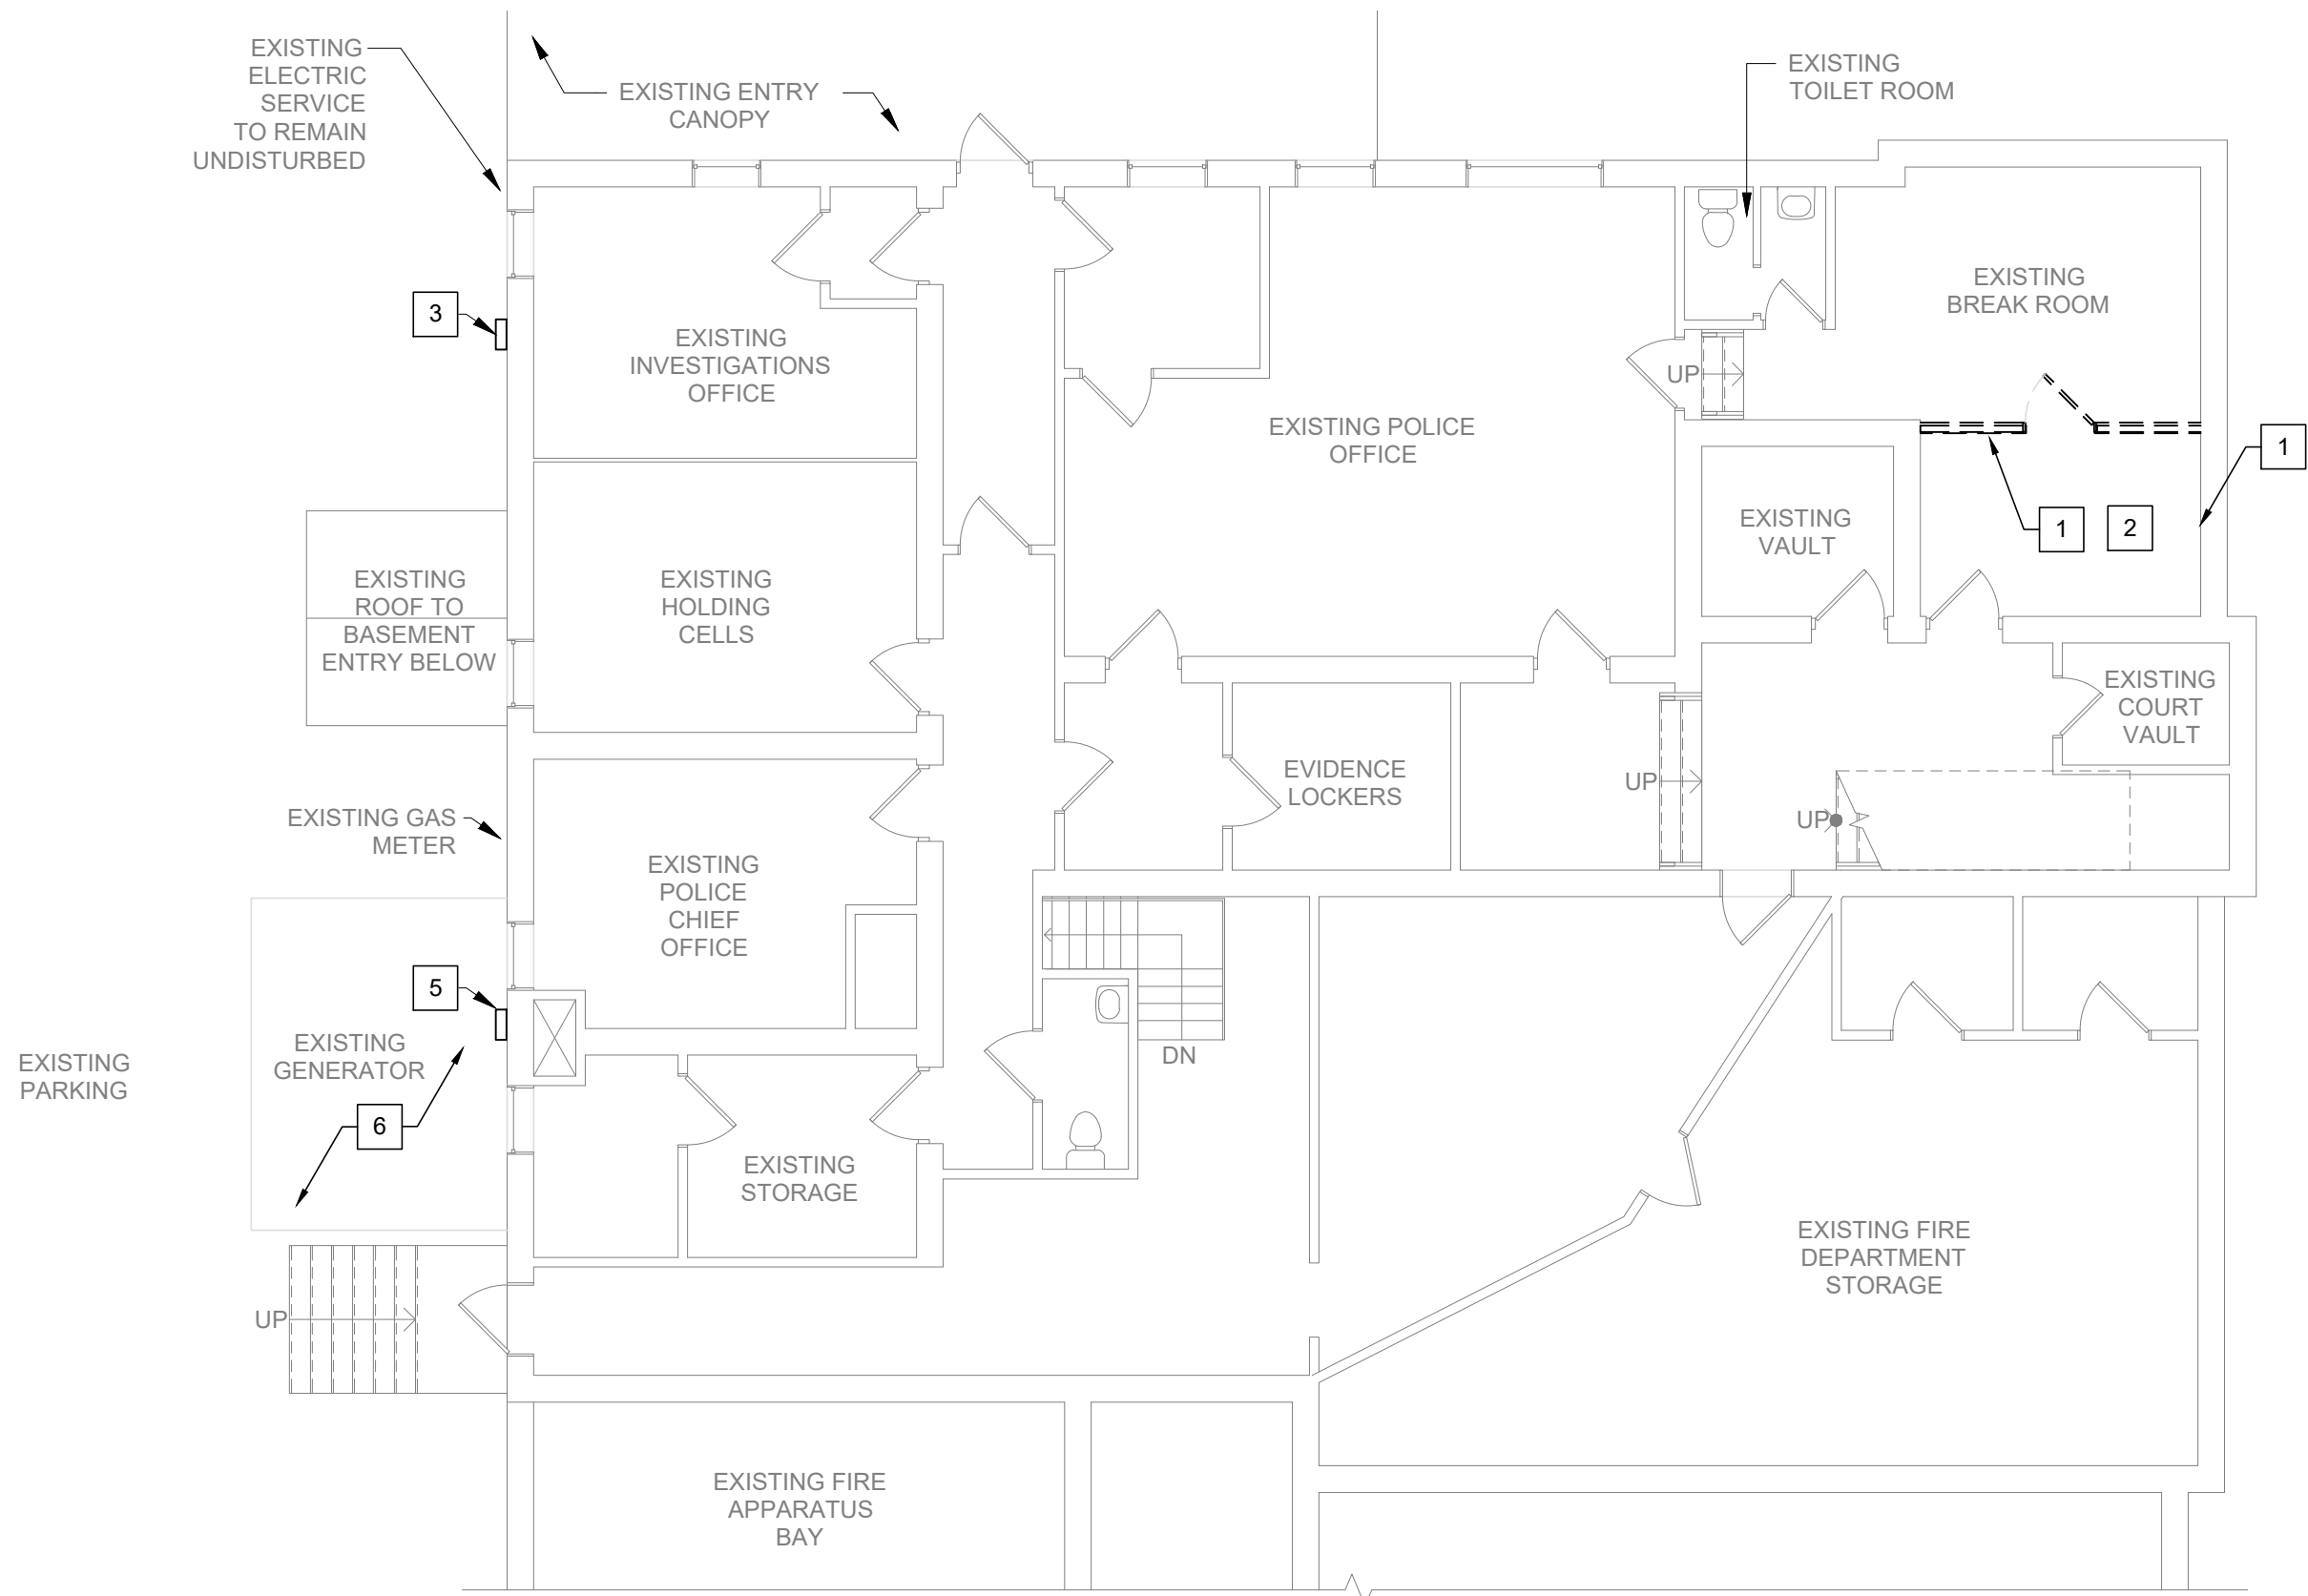
DRAWING ISSUED: APRIL 5, 2021

Project Number:	Scale:
00370	As indicated
Drawn By:	Checked By:
JD	AP

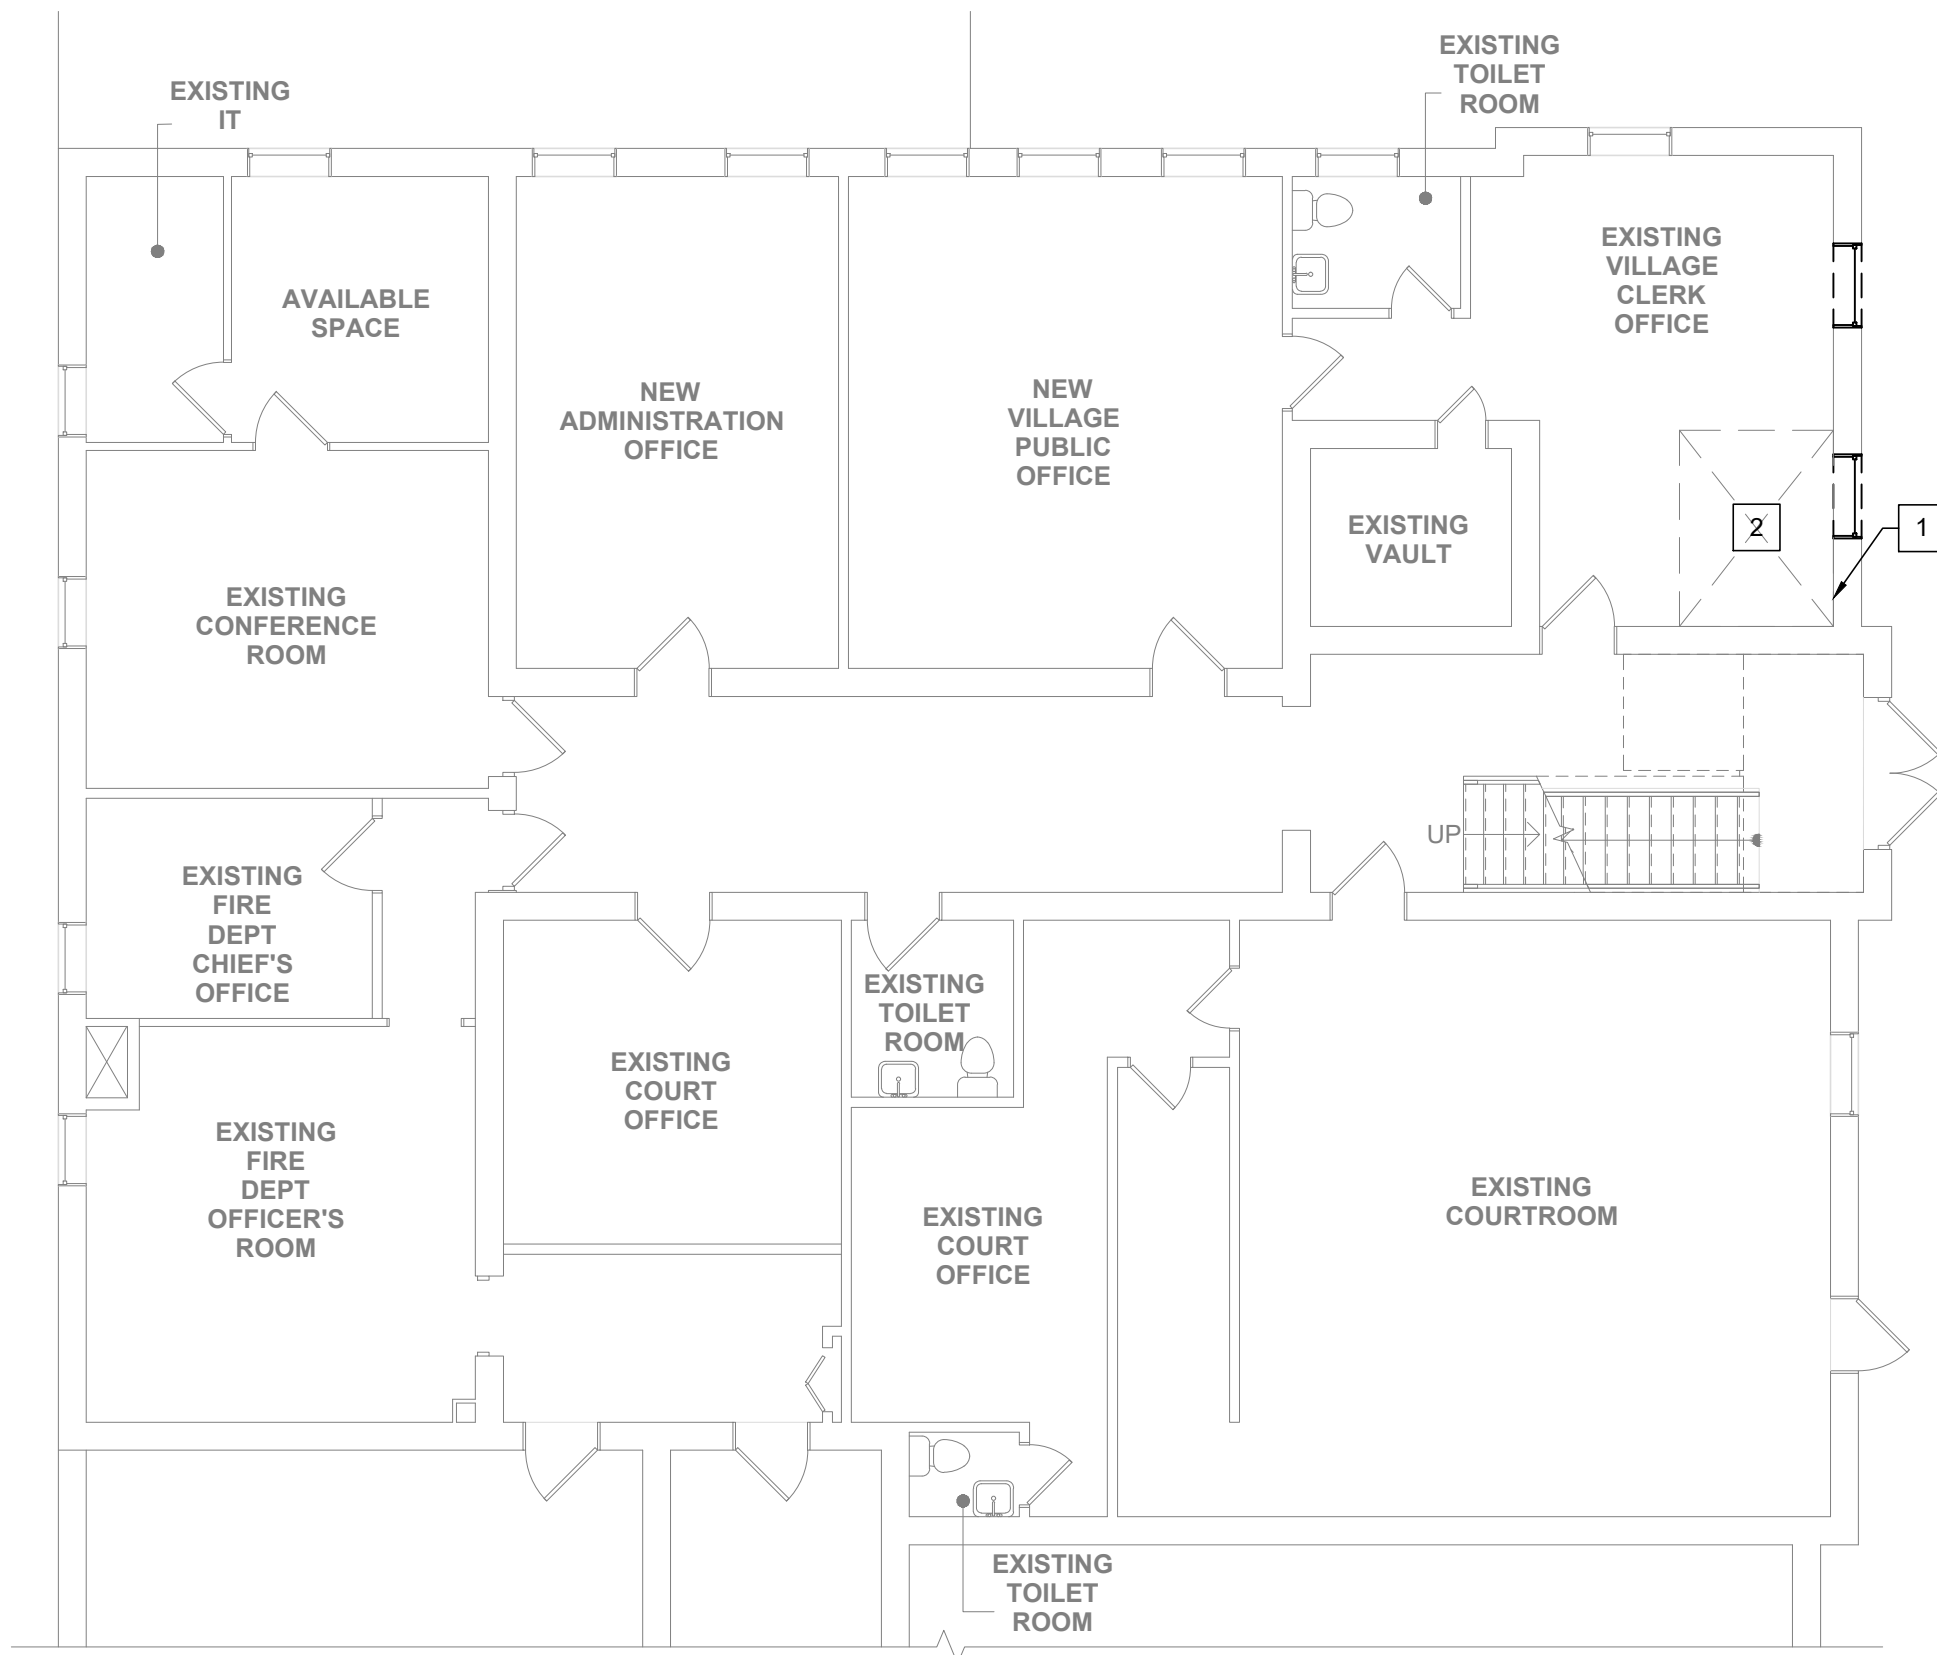
Drawing Title  
ATTIC PLAN - MECHANICAL

Drawing Number

M1-01



1 GROUND FLOOR DEMOLITION PLAN  
1/8" = 1'-0"



2 FIRST FLOOR DEMOLITION PLAN  
1/8" = 1'-0"

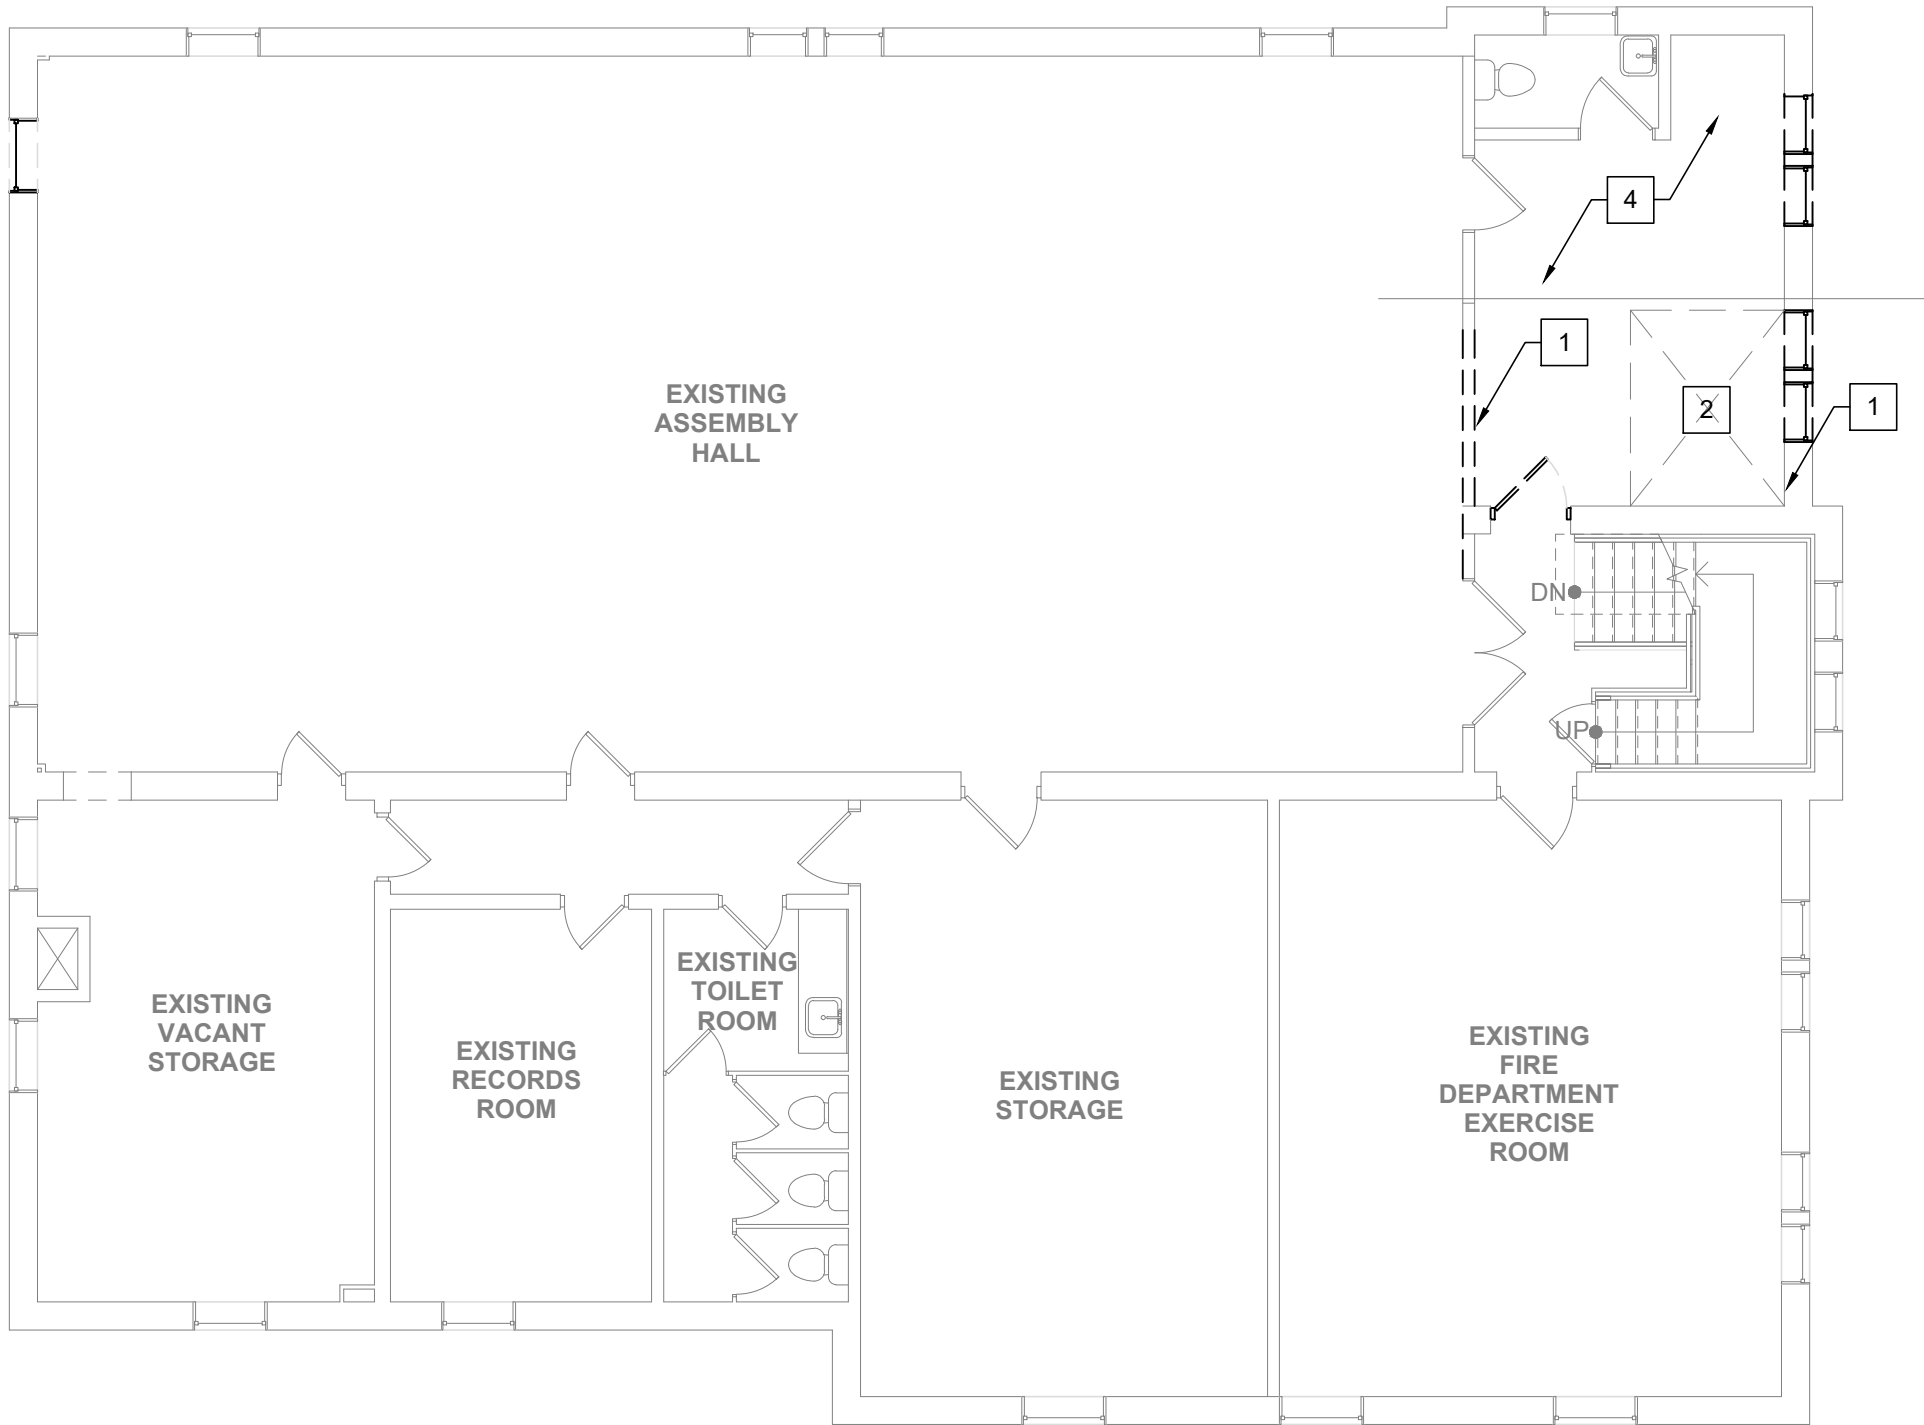
MISCELLANEOUS SYMBOLS	
	PANELBOARD, SURFACE MOUNTED
	FUSED DISCONNECT AS INDICATED. INDOOR NEMA 1.
	MOTOR CONNECTION - "1/2" DENOTES HORSEPOWER RATING
	HOMERUN TO PANELBOARD PP. FED FROM BREAKER, CIRCUIT #2, UNLESS INDICATED OTHERWISE.
	DUPLEX RECEPTACLE DEVICE. 120V. 20AMP.
	LIGHT SWITCH DEVICE. 120V. 15AMP.
	SMOKE DETECTION UNIT PROVISION
	EXIT SIGN AS SPECIFIED
	JUNCTION BOX

GENERAL NOTES:

- A. EXISTING CONDITIONS WERE NOTED FROM FIELD OBSERVATIONS AND EXISTING DRAWINGS. CONTRACTOR SHALL FIELD VERIFY EXISTING CONDITIONS AND NOTIFY OF DISCREPANCIES TO OWNER AND/OR ARCHITECT/ENGINEER.
- B. DISCONNECT AND REMOVE EXISTING DEVICES, FIXTURES, RACEWAYS AND EQUIPMENT AS INDICATED. MAINTAIN CIRCUIT INTEGRITY AND OPERATION AT ALL TIME IN "NOT-IN-CONTRACT" (N.I.C) SPACES. EXISTING CIRCUITS SHOULD BE TRACED WITH "AMPROBE PHASOR" DEVICE OR SIMILAR INSTRUMENT TO VERIFY THEIR IMPACT IN ADJACENT AND/OR N.I.C AREAS PRIOR TO REMOVAL AND INTERRUPTION.
- C. CONTRACTOR SHALL PROTECT AND PROVIDE TEMPORARY POWER TO ALL EXISTING TO REMAIN DEVICES IMPACTED DURING THE CONSTRUCTION PHASE. PROVIDE ALL MATERIALS TO RE-FEED DOWNSTREAM DEVICES TO REMAIN( IF ANY). FOLLOW AND COORDINATE CONSTRUCTION PHASING PLAN TO MEET BUILDING OPERATIONS.
- D. DISCONNECT AND REMOVE IMPACTED AND ABANDONED EXPOSED SURFACE RACEWAYS, INCLUDING UNUSED DEVICES.
- E. REFER TO EXISTING LUMINAIRES TO BE RELOCATED. RE-USED LIGHT FIXTURES SHOULD BE STORED IN A CLEAN DRY LOCATION FREE FROM DAMAGE. CLEAN, RE-LAMP, REPLACE LENS, AND RE-BALLAST SHALL BE PROVIDED PRIOR TO RE-INSTALLATION.
- F. CONTRACTOR SHALL COORDINATE SALVAGED DEVICES AND FIXTURES WITH OWNER. FIXTURES OR DEVICES CONTAINING PCB OR HAZARD MATERIALS SHALL BE HANDLED AND DISPOSAL AS REQUIRED BY ASBESTOS CONTRACTOR AND AS INDICATED IN UNIVERSAL WASTE SPECIFICATION SECTION, UNLESS OTHERWISE NOTED.
- G. ALL SHOWN DASHED ELEMENTS ARE FOR REMOVAL, UNLESS OTHERWISE NOTED. SHOWN ELEMENTS ARE TO DEPICT REMOVAL, BUT NOT NECESSARILY REPRESENT EXACT DEVICE QUANTITIES. CONTRACTOR TO FIELD VERIFY AND CONFIRM FINAL QUANTITIES, LENGTHS, TYPE.

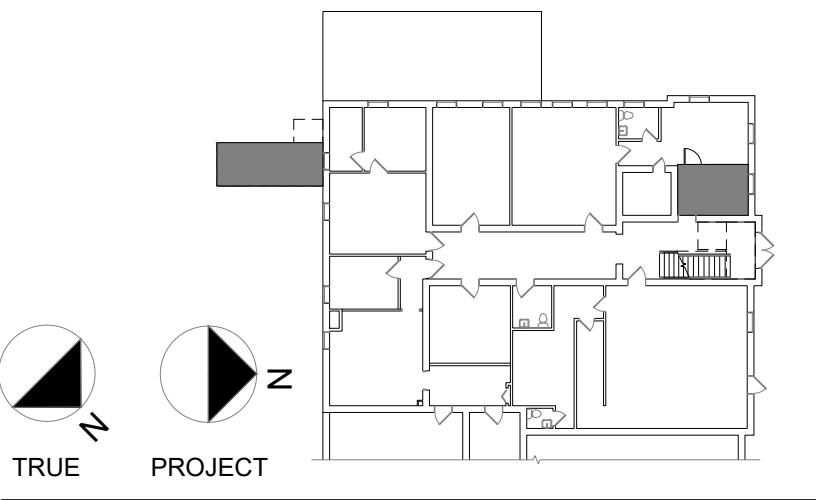
KEYED DEMOLITION NOTES: #

1. DISCONNECT AND REMOVE EXISTING ELECTRICAL DEVICES, EQUIPMENT IN THE IMPACTED, DEMOLISHED WALL(S).
2. DISCONNECT, REMOVE AND SALVAGE EXISTING OVERHEAD LUMINAIRE(S) TO ACCOMMODATE NEW ELEVATOR SHAFT. RETAIN CIRCUITS. RE-USE AND RELOCATE LUMINAIRE(S) OUTSIDE THE SHAFT SPACE, EXTEND CIRCUITRY AS NEEDED.
3. EXISTING WALLPACK FIXTURE (TYP. OF 2). DISCONNECT AND REMOVE IN ITS ENTIRETY. RETAIN EXTERIOR LIGHTING CIRCUITRY FOR RE-USE.
4. DISCONNECT AND REMOVE M/E/P ELEMENTS, DEVICES AS PART OF ALTERNATE #1. COORDINATE FINAL DEMOLITION SCOPE WITH ARCHITECT.
5. EXISTING WALLPACK LUMINAIRE AND CIRCUIT TO REMAIN AS IS.
6. EXISTING EMERGENCY GENERATOR UNIT TO REMAIN AS IS. PROTECT DURING CONSTRUCTION PHASE.



3 SECOND FLOOR DEMOLITION PLAN  
1/8" = 1'-0"

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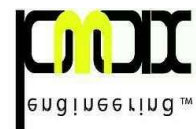
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NOTES & REVISIONS:

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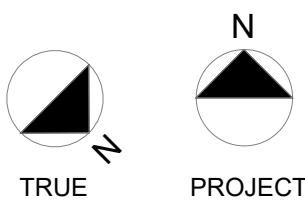
DRAWING ISSUED:		APRIL 5, 2021
Project Number:	Scale:	
00370	As indicated	
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AD	AP	

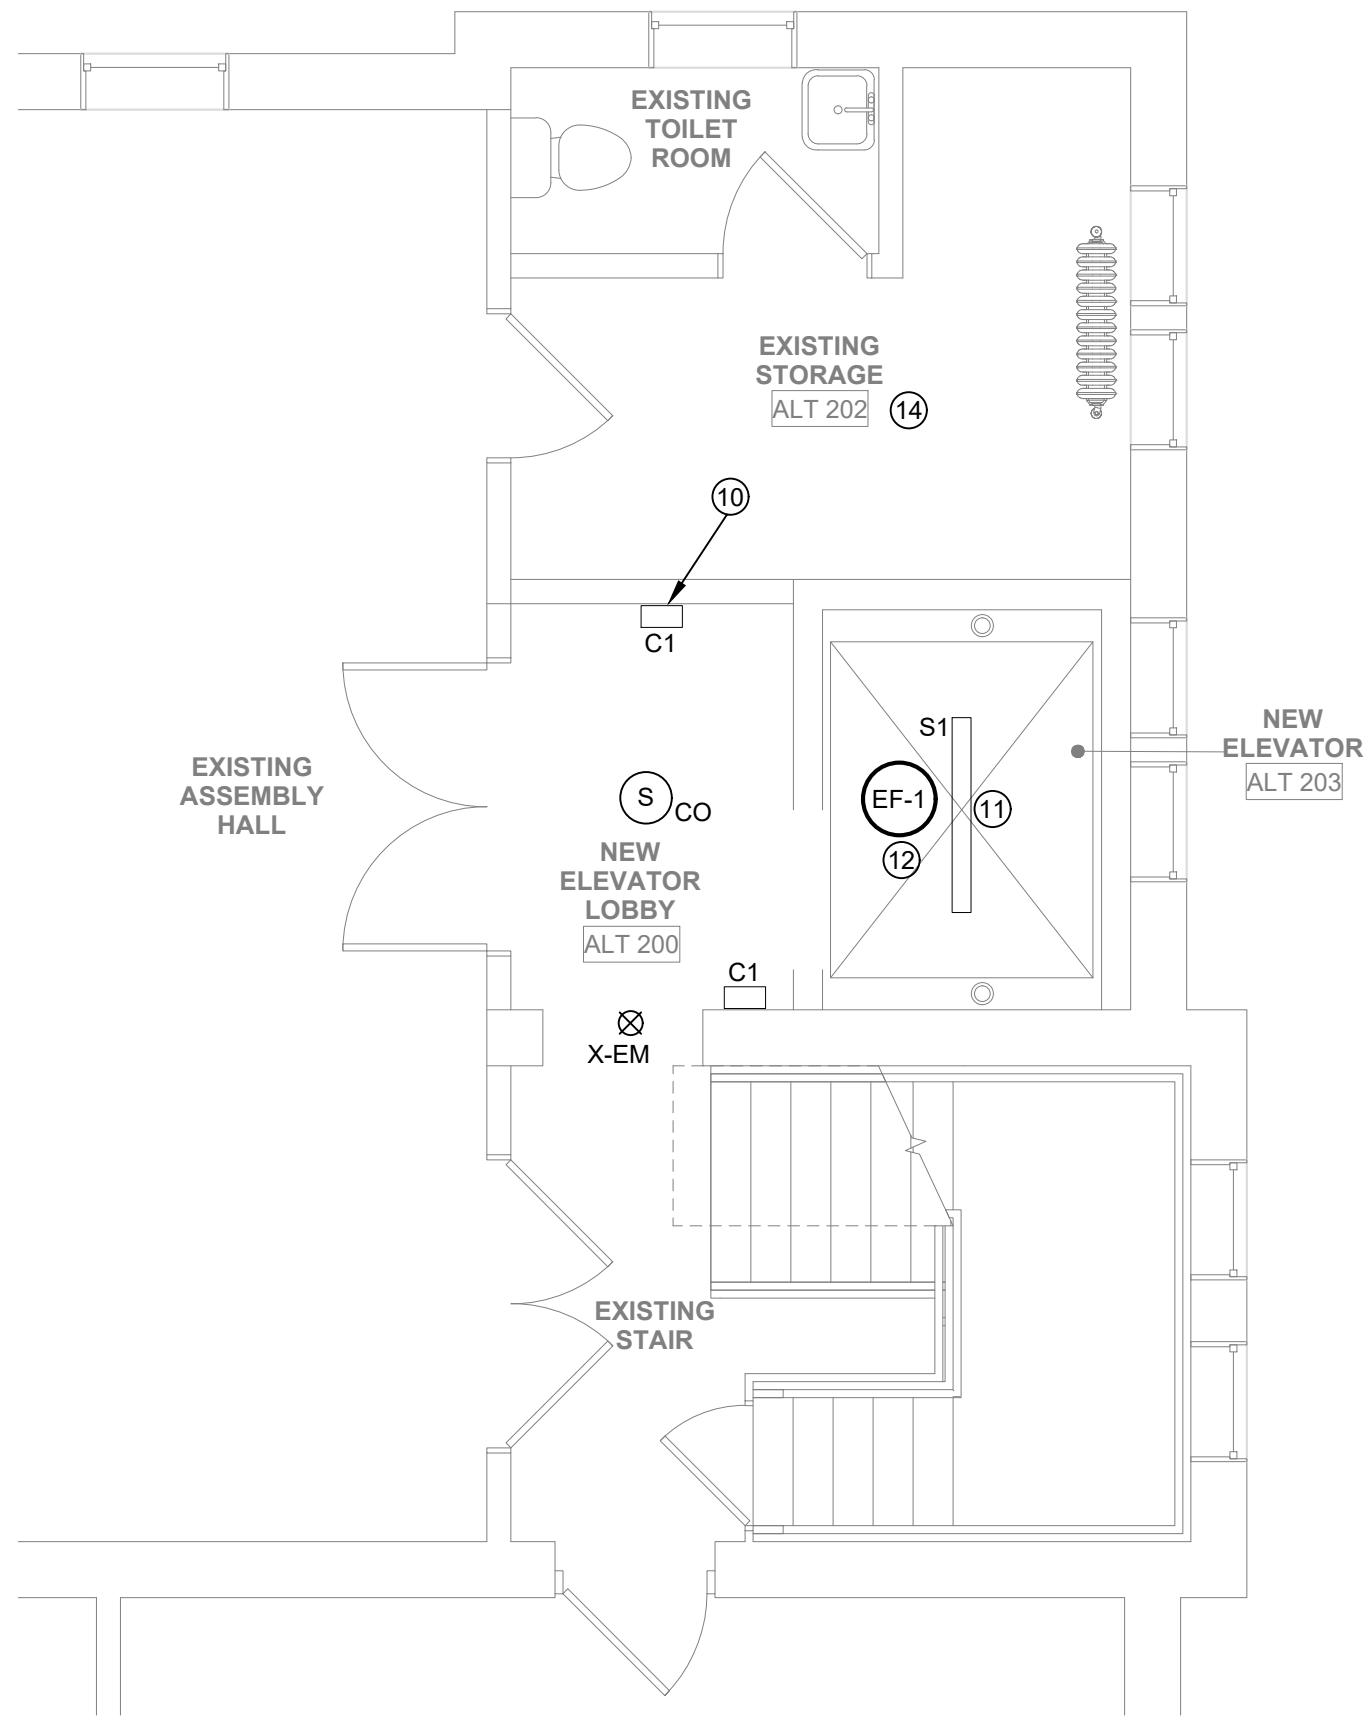
Drawing Title

ELECTRICAL  
DEMOLITION PLAN

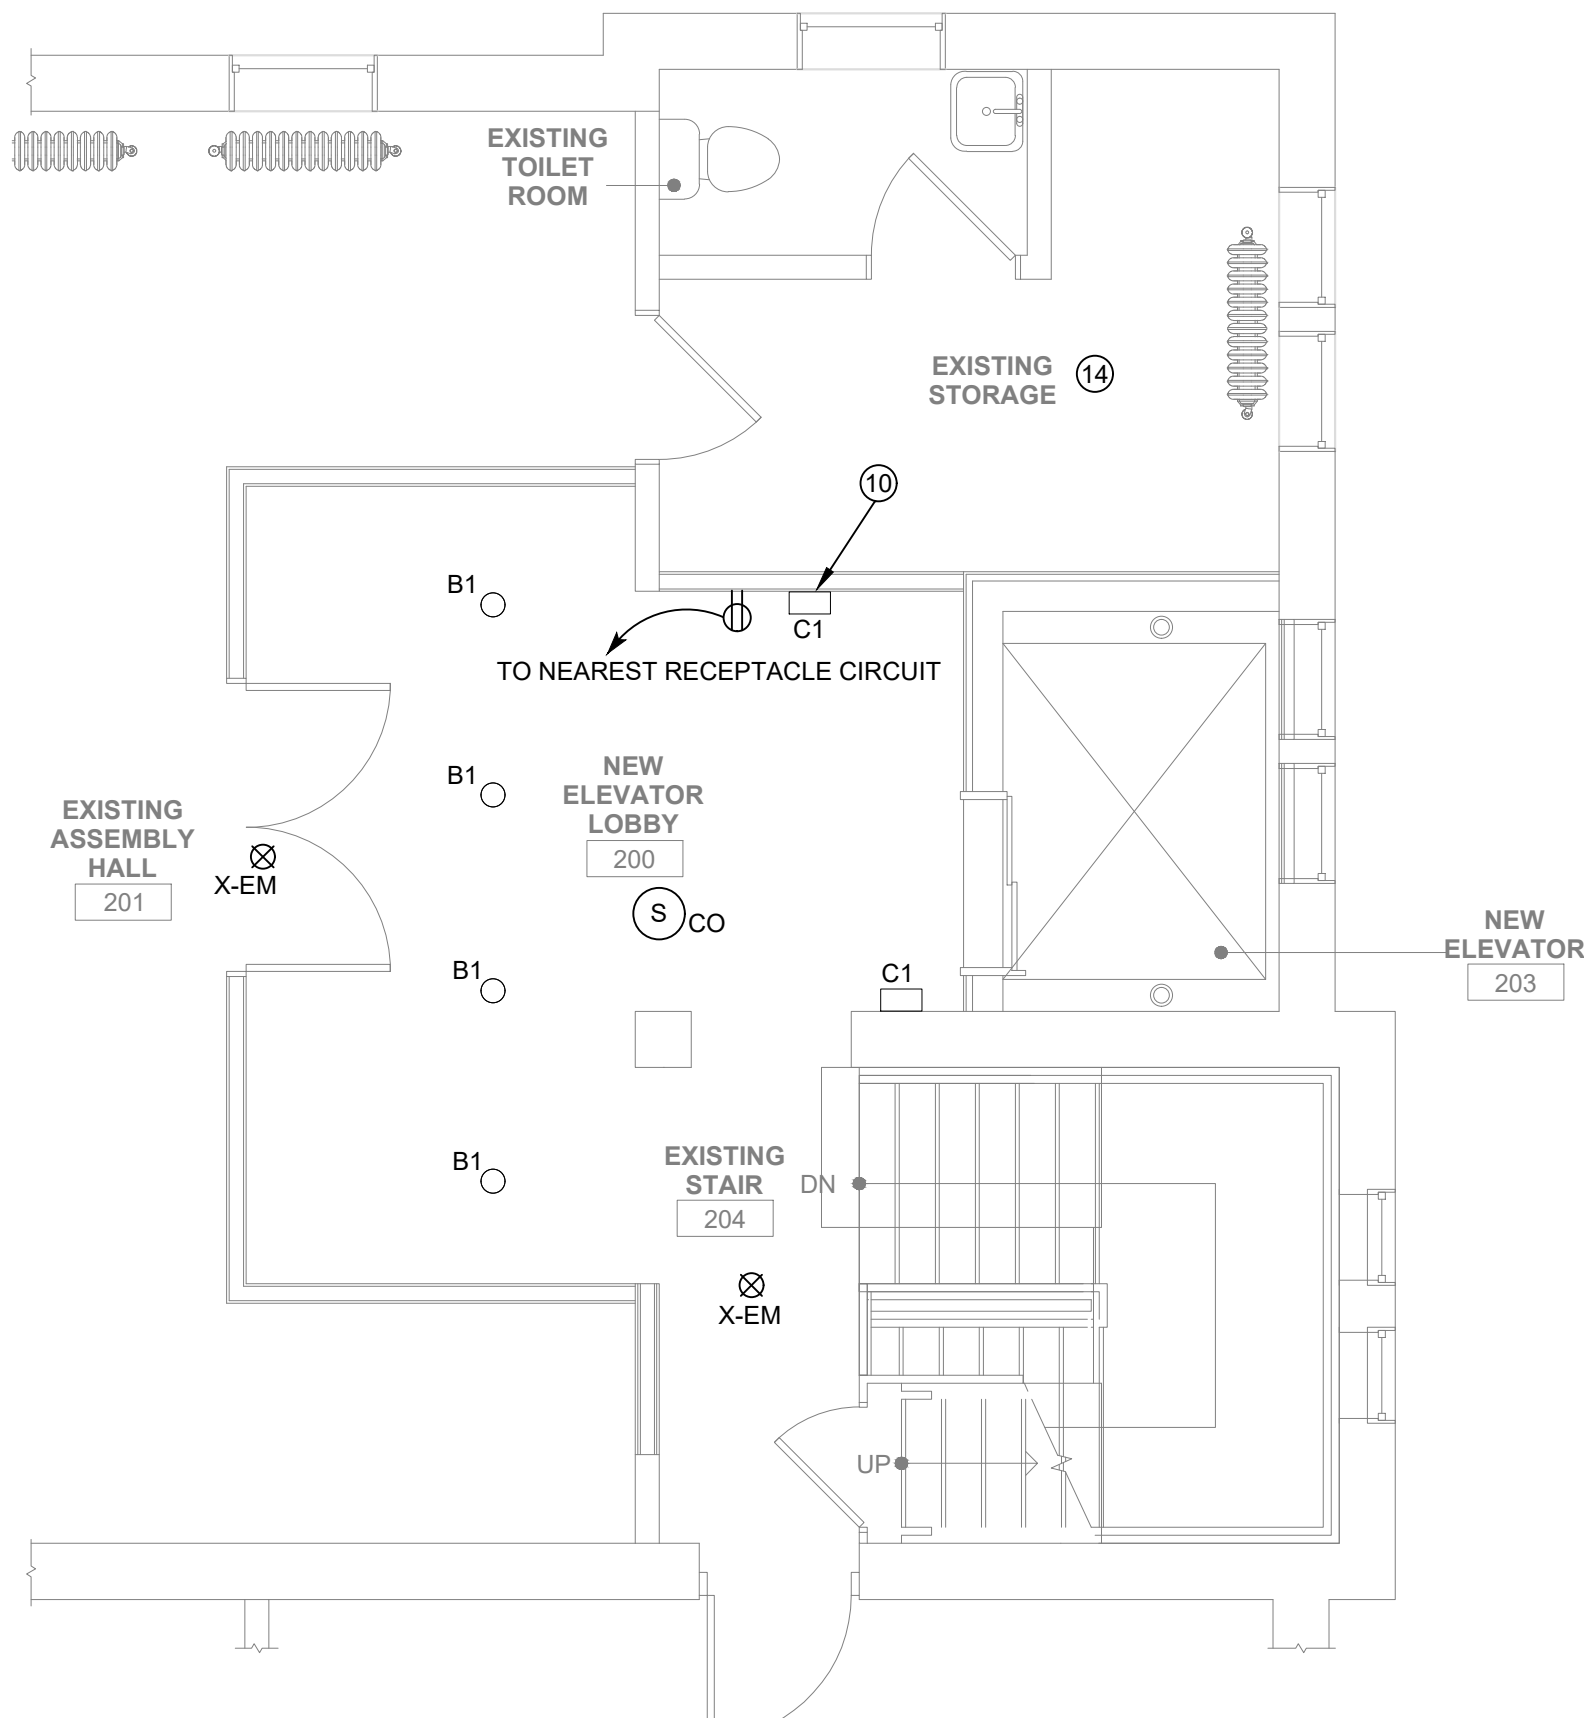
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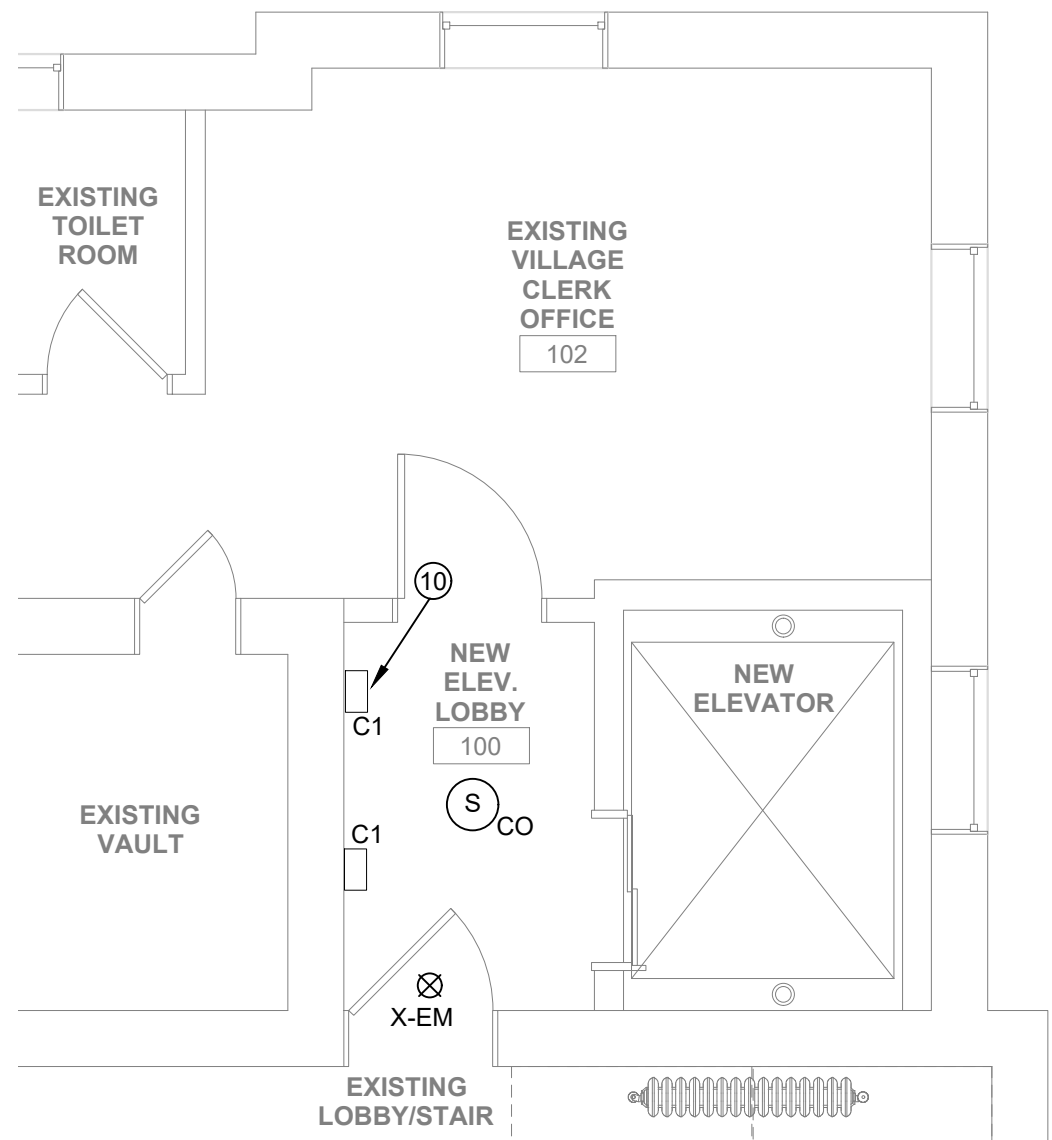




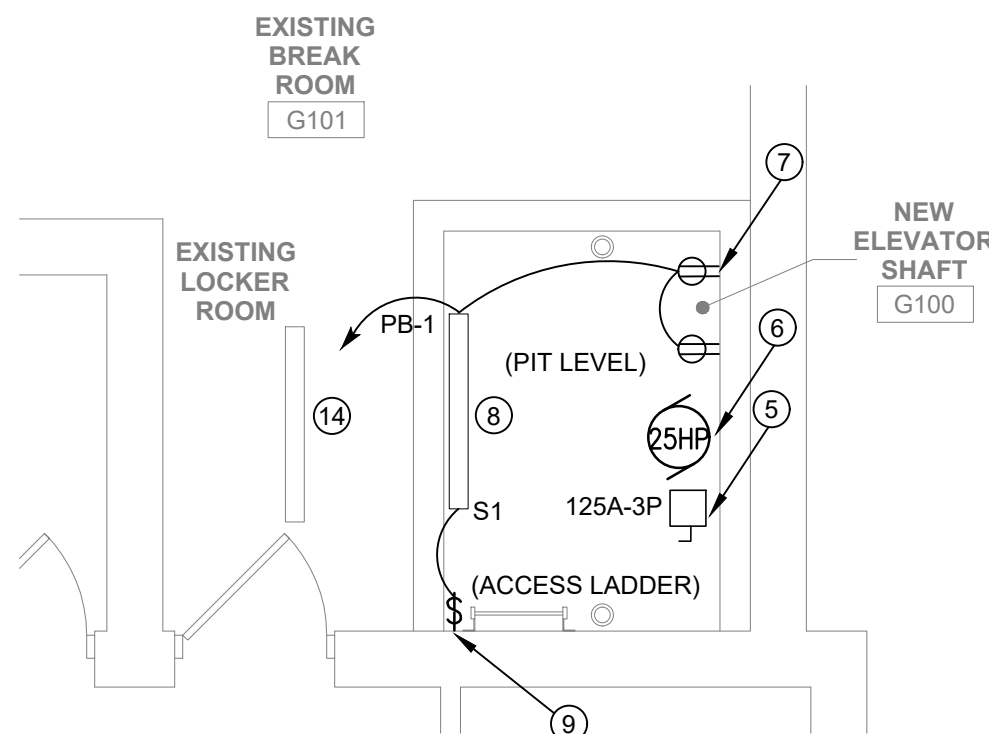
3 SECOND FLOOR ELEVATOR PLAN (ALTERNATE #1)  
1/4" = 1'-0"



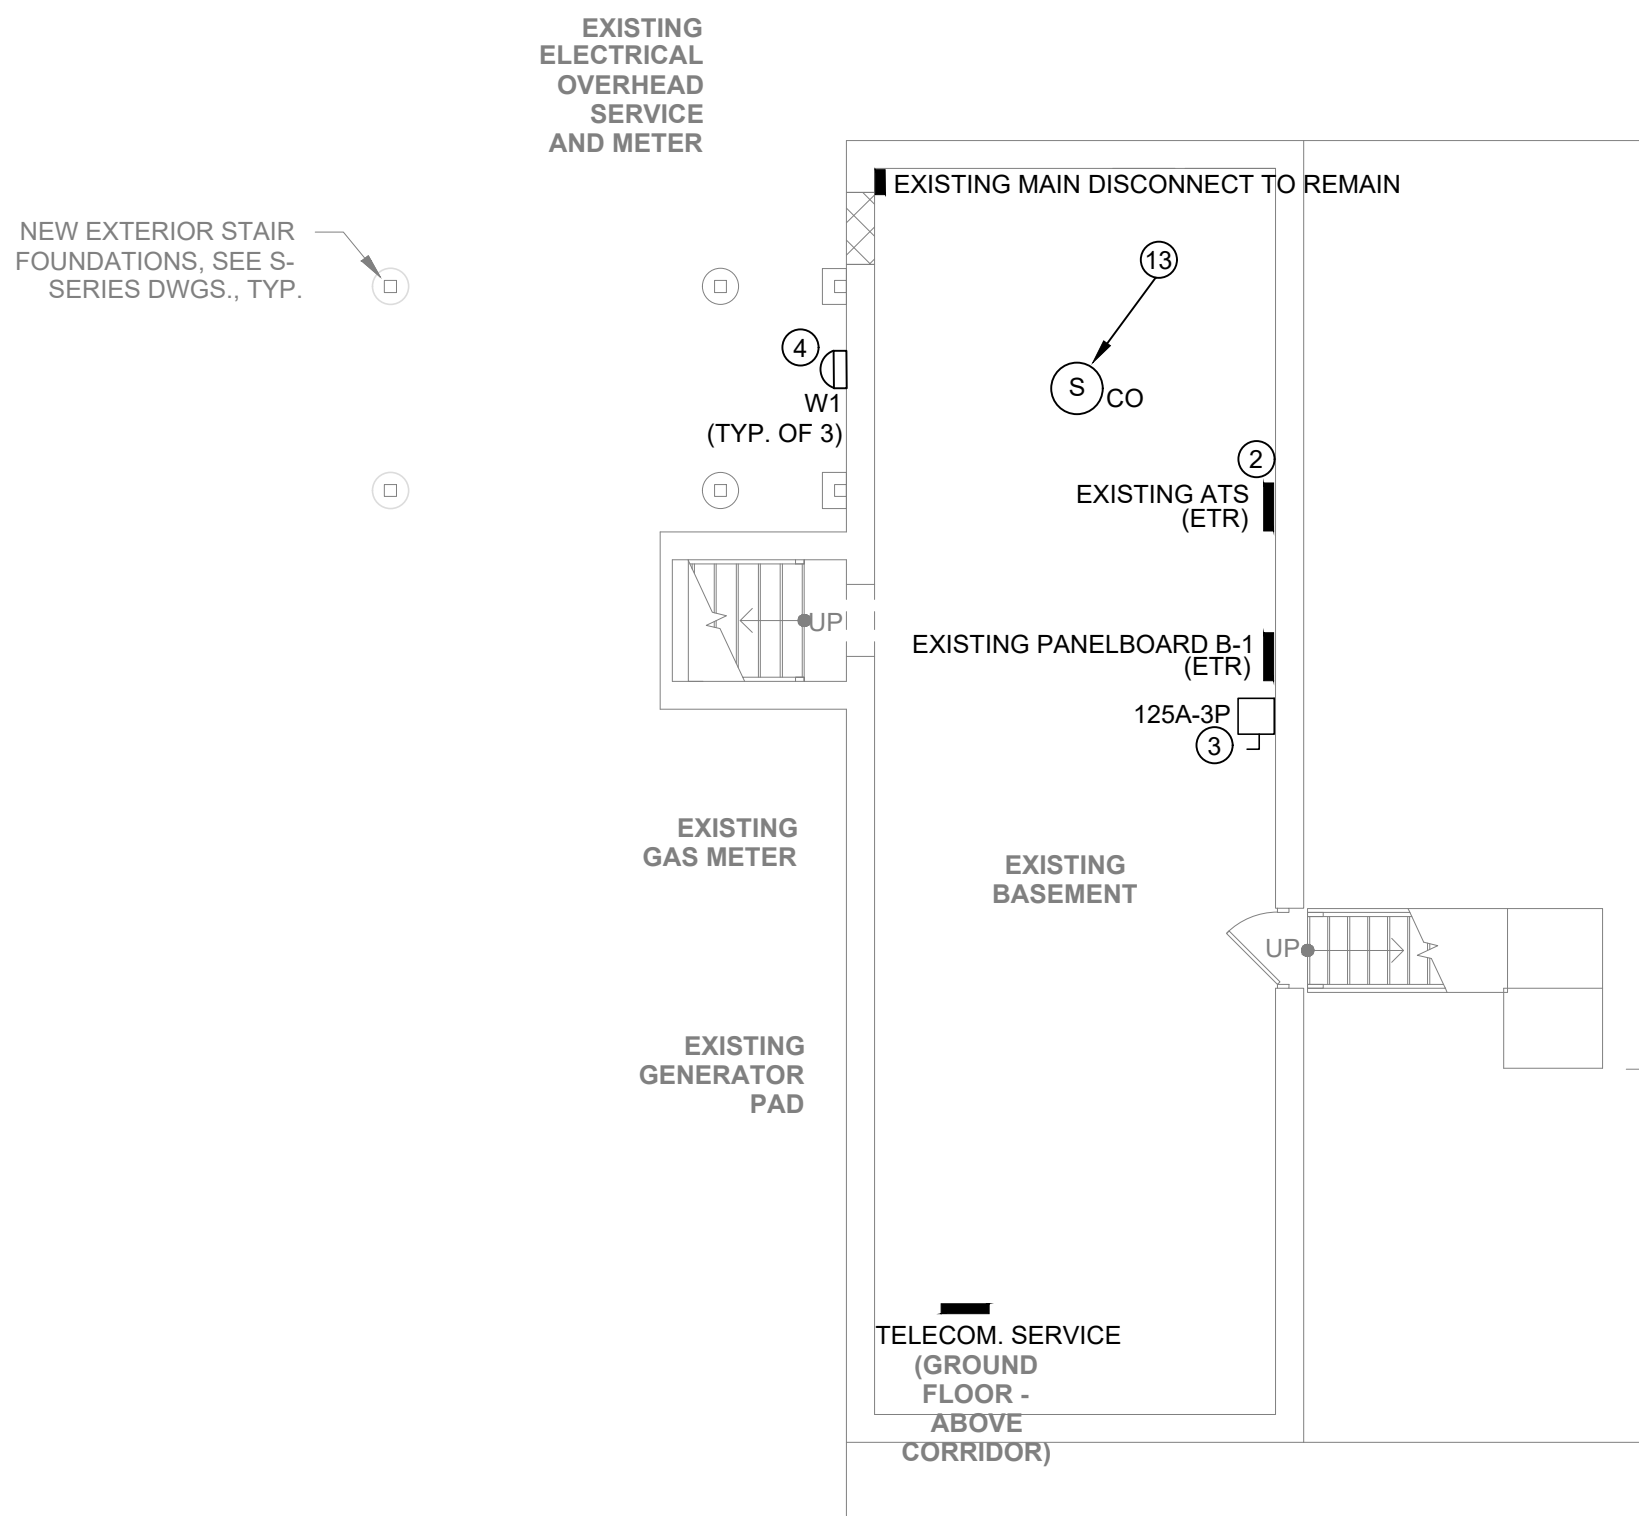
4 SECOND FLOOR ELEVATOR PLAN  
1/4" = 1'-0"



2 FIRST FLOOR ELEVATOR PLAN  
1/4" = 1'-0"



1 GROUND FLOOR ELEVATOR PLAN  
1/4" = 1'-0"



5 BASEMENT FLOOR LEVEL  
1/4" = 1'-0"

## GENERAL NOTES (ALL SHEETS)

- CONTRACTOR TO COORDINATE FINAL ELECTRICAL REQUIREMENTS WITH ELEVATOR CONTRACTOR.
- CONTRACTOR TO FOLLOW PERRY OF VILLAGE PROCEDURES FOR ACCESS AND WORK IN FACILITIES.
- AREAS OF WORK AND OTHER DISTURBED AREAS DO FOLLOW A PHASING PLAN AND/OR CONSTRUCTION SEQUENCE, REFER TO MASTER PLAN DOCUMENTS AND OTHER DISCIPLINES (IF APPLICABLE).
- RELATED POWER SHUT-DOWNS SHALL BE SCHEDULED IN ADVANCE WITH OWNER'S REPRESENTATIVE, INDICATING AFFECTED CIRCUITS, AREAS/ROOMS AND POWER SHUT-DOWN DATE(S) AND TIME(S). CONSIDER AFTER BUSINESS AND/OR WEEKEND HRS. TO COMPLETE PROJECT WORK WITH MINIMAL DISTURBANCE AND/OR INTERRUPTIONS.
- ALL ELECTRICAL MATERIALS AND EQUIPMENT SHALL BE SUITABLE FOR AREAS OF WORK. I.E. HOISTWAY. ALL EXPOSED RACEWAYS SHALL BE PAINTED AND MATCH TO EXISTING WALL COLOR. UTILIZE SURFACE MOUNT RACEWAYS IN FINISH SPACES.
- SALVAGE AND/OR RE-USED EQUIPMENT/MATERIAL SHALL BE PROTECTED FROM CONSTRUCTION OR STORED AND RE-INSTALL AS INDICATED. CLEAN AND PROVIDE NEW MOUNTING SUPPORTS AS REQUIRED.
- RELOCATE UNFORESEEN ELECTRICAL ITEM(S) IMPACTED BY NEW WORK AND NOT INDICATED SPECIFICALLY ON DOCUMENTS. MATCH WIRE, CONDUIT CHARACTERISTICS.
- CONTRACTOR TO PROVIDE WALL/FLOOR PENETRATIONS, AND PROVIDE FIREPROOF MATERIALS FOR INSTALLED CONDUIT(S) IN FIRE RATED FLOORS, WALLS SYSYEMS. REFER TO DIVISION 7 SPECIFICATIONS.
- CONTRACTOR TO PATCH, PAINT AND RESTORE TO ORIGINAL CONDITIONS DISTURBED AREAS OF WORK. MATCH TO FINISH COLOR, COORDINATE WITH GENERAL CONSTRUCTION CONTRACT.

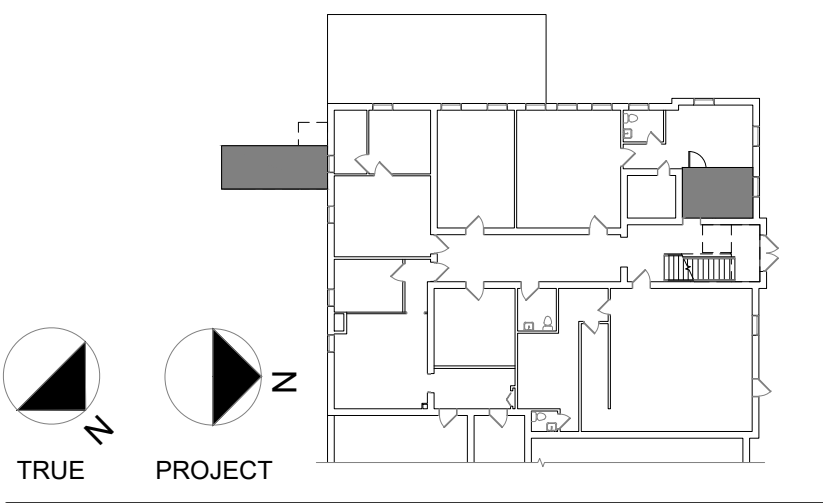
## GENERAL NOTES:

- LUMINAIRE WITH LASTING "EM" DESIGNATION SHALL BE PROVIDED WITH EMERGENCY BATTERY PACK.
- NEW EXIT SIGNS TIE TO UN-SWITCHED LOCAL LIGHTING CIRCUIT.
- REFER TO LUMINAIRE SCHEDULE FOR SPECIFIED FIXTURES.
- ALL LUMINAIRES SHALL BE CONNECTED TO NEAREST LIGHTING CIRCUIT. RUN MIN. 2-#12 AWG, 1-#12 AWG IN 3/4" C UNLESS OTHERWISE NOTED. RE-USE AS MUCH AS POSSIBLE OF EXISTING CIRCUITS.
- CONTRACTOR TO COORDINATE WITH ARCHITECT CEILING HEIGHT(S) AND FINAL MOUNTING HEIGHT(S).
- PROVIDE NEW SUPPORTS AND CIRCUITRY EXTENSION FOR ANY RELOCATED FIXTURE(S). COORDINATE FINAL LOCATION IN CEILING PRIOR TO INSTALLATION.
- CONTRACTOR TO PROVIDE ALL PATHWAYS, JUNCTION BOXES, WIRING AND DEVICES FOR A FUTURE FIRE ALARM SYSTEM. FIRE ALARM WIRING SHALL BE IN RACEWAYS IN VERTICAL RUNS.
- POWER RECEPTACLES TO BE CONNECTED AT INDICATED PANELBOARD. RUN #12AWG MIN. IN 3/4" C, UNLESS OTHERWISE NOTED.
- CONTRACTOR TO REFER TO EQUIPMENT CONNECTION SCHEDULE FOR ALL REQUIRED POWER CONNECTIONS NOT SHOWN IN THIS SHEET.
- REMOVED UN-USED ELECTRICAL DEVICES IN SCOPE AND PROVIDE BLANK COVERS. SAME APPLIES FOR ABANDONED POWER CONNECTIONS. DISCONNECT AND REMOVE WIRING UP TO THE PANELBOARD SOURCE.

## KEY NOTES:

- NOT USED.
- PROVIDE 1" CONDUIT WITH WIRING (MIN. 4-#16 AWG) TO ELEVATOR CONTROLLER FOR TWO (2) REQUIRED SIGNALS. ORIGINATE SIGNALS IN ATS UNIT. REPLACE ATS ELECTRONIC CONTROLLER TO ACCEPT SIGNALS (IF NEEDED). VERIFY ON FIELD ATS UNIT.
- TAP POWER FROM PANELBOARD "B-1" FOR NEW ELEVATOR FEEDER. PROVIDE 3-#1 AWG, 1-#6 GND. IN 2" CONDUIT TO NEW 200AMP. DISCONNECT, 3P, FUSED AT 125AMP. MOUNT DISCONNECT NEXT TO PANELBOARD B-1. RECONFIGURE EXISTING CONDUITS, EQUIPMENT AS NEEDED.
- NEW WALLPACK FIXTURE (TYP. OF 4), MOUNT FIXTURES AT DIFFERENT HEIGHTS IN THE NEW STAIRWELL. VERIFY ON FIELD AND CONNECT TO EXISTING LIGHTING CIRCUIT, EXTEND CONDUIT, WIRING AS REQUIRED. PAINT CONDUIT TO MATCH EXTERIOR FINISH COLORS.
- NEW 200AMP. DISCONNECT, 3P, FUSED AT 125 AMP. MOUNT NEXT TO ELEVATOR POWER UNIT.
- ELEVATOR MOTOR. CONFIRM FINAL MOTOR RATING PRIOR TO ELECTRICAL INSTALLATION.
- PROVIDE 120V SERVICE RECEPTACLE (TYP. OF 2) MOUNTED ON THE PIT LEVEL. RUN 2-#12 AWG, 1-#12 AWG IN 3/4" C CIRCUIT ALONG WITH LIGHTING LOAD TO NEAREST POWER SOURCE. OTHERWISE CONNECT TO PANELBOARD B-1. ONE 120V RECEPTACLE DEVICE WILL SERVE NEW SUMP PUMP.
- PROVIDE AND MOUNT LUMINAIRE IN THE PIT LEVEL. REFER TO LUMINAIRE SCHEDULE.
- PROVIDE 15A, 120V LIGHT SWITCH. LOCATE SWITCH BY ACCESS LADDER AS REQUIRED.
- PROVIDE LED WALL SCONCE. REFER TO LUMINAIRE SCHEDULE. CONNECT TO NEAREST AVAILABLE LIGHTING CIRCUIT OR PANELBOARD SOURCE. RUN CONDUIT, WIRING AS REQUIRED.
- PROVIDE LUMINAIRE AND CIRCUITRY. MOUNT FIXTURE ON TOP BEAM OR TOP LEVEL OF ELEVATOR SHAFT. CONTROL LIGHT FROM PIT LEVEL SWITCH, UNLESS OTHERWISE NOTED.
- PROVIDE POWER TO NEW EXHAUST FAN IN THE ATTIC SPACE. REFER TO EQUIPMENT CONNECTION SCHEDULE. COORDINATE FINAL LOCATION ON FIELD.
- UNDER THIS PHASE PROVIDE COMBINATION SMOKE AND CARBON MONOXIDE DETECTOR, CEILING DEVICE, WITH INTEGRATED ALARM AND 10 YEAR SEALED LITHIUM BATTERY OR APPROVED EQUAL (TYP.).
- RELOCATE AND REINSTALL PENDANT/SURFACE LUMINAIRE(S) AND CENTER WITHIN THE SPACE. CLEAN, RE-LAMP AND EXTEND CIRCUITRY, CONTROL WIRING AS NEEDED.

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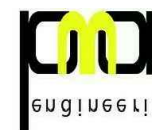
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#### NOTES & REVISIONS:

Revision Schedule		
Revision Number	Date	Description

DRAWING ISSUED: APRIL 5, 2021

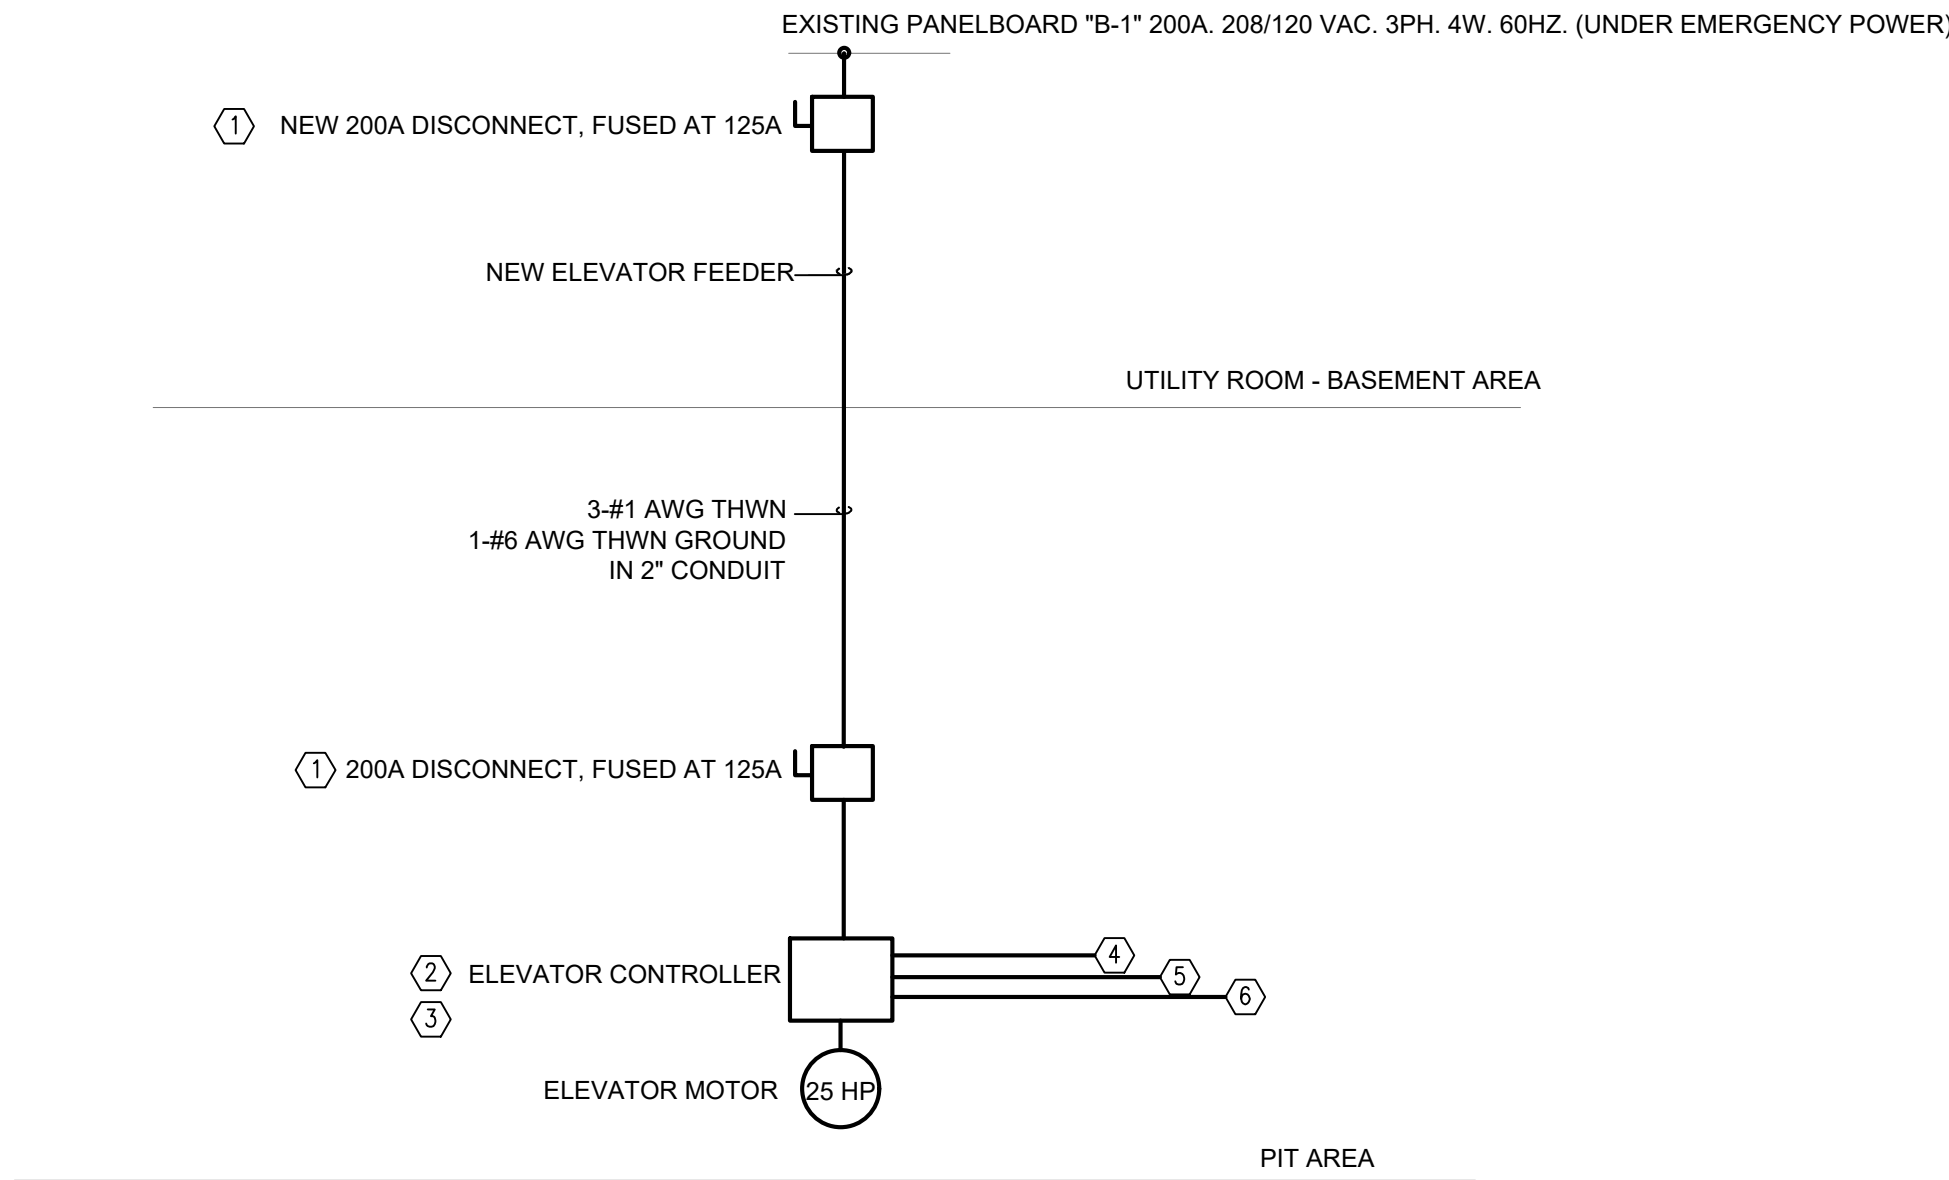
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Drawn By: AD	Checked By: AP

Drawing Title

ELECTRICAL  
FLOOR PLANS

Drawing Number

E-01

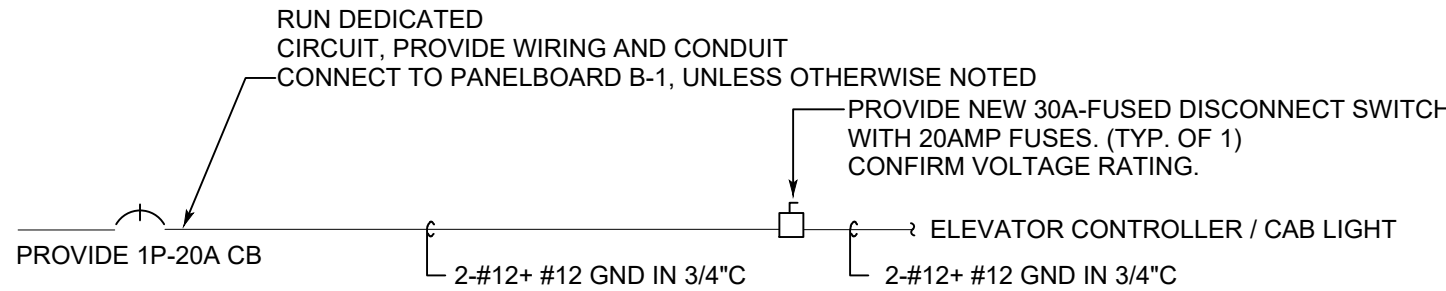


### KEY NOTES

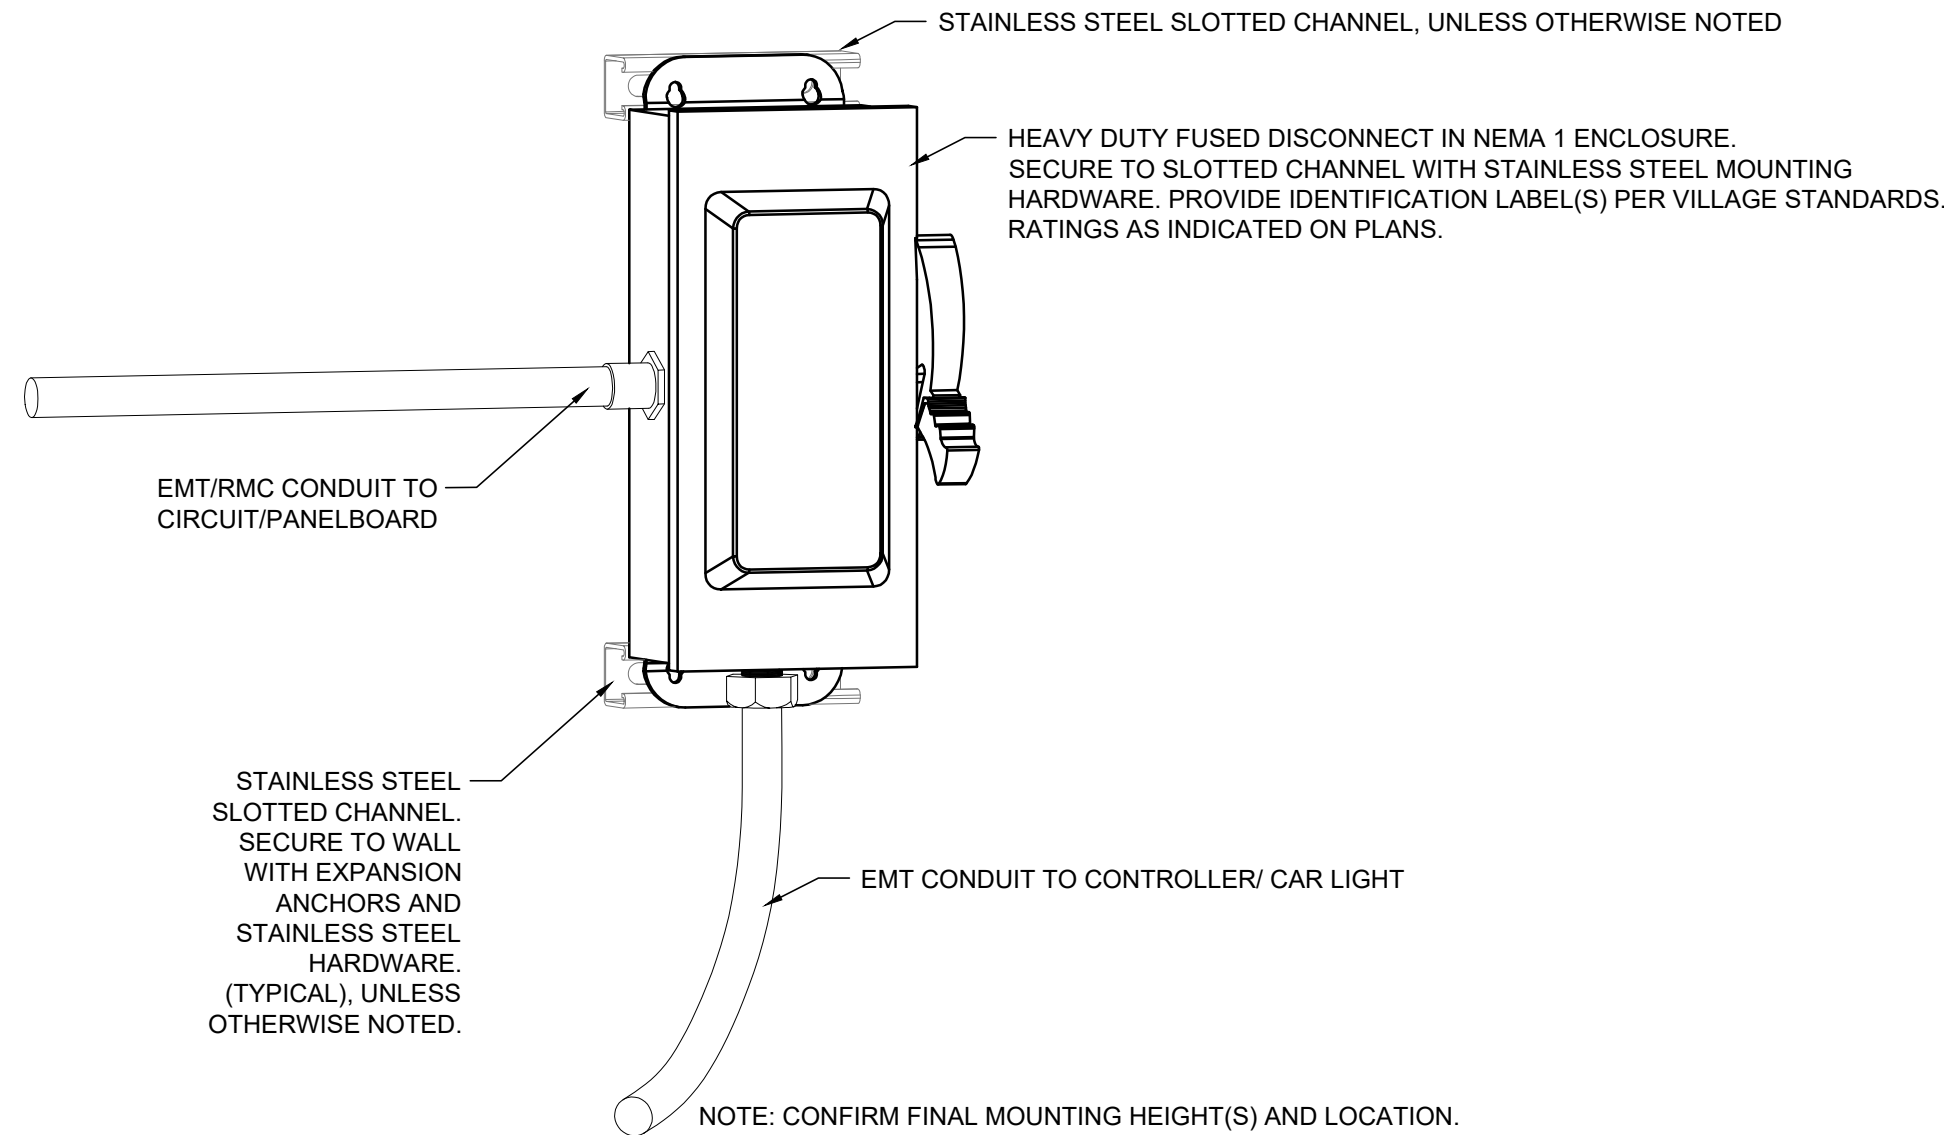
AS INDICATED BY: ⑧

- PROVIDE 200AMP DISCONNECT, FUSED AT 125 AMP, "R" TYPE OR AS INDICATED OTHERWISE.
- ELEVATOR CONTROLLER AND MOTOR BY ELEVATOR CONTRACTOR.
- ALL SIGNAL AND LOW VOLTAGE CONTROL WIRING BY ELEVATOR CONTRACTOR.
- PROVIDE NEW PHONE DIGITAL OR ANALOG LINE TO CONTROLLER. ORIGINATE AT POINT OF TELECOM. ENTRY.
- PROVIDE EXTERNAL JUNCTION BOX TO RECEIVE AUTOMATIC TRANSFER SIGNALS. PRE-TRANSFER AND EMERGENCY POWER OPERATION. RUN SIGNALS FROM ATS UNIT, BASEMENT AREA.
- PROVIDE EXTERNAL JUNCTION BOX TO RECEIVE FUTURE FIRE ALARM SIGNALS.

#### ① PARTIAL POWER RISER DIAGRAM FOR ELEVATOR SYSTEM SCALE: NONE



#### ② PARTIAL POWER RISER DIAGRAM FOR CAB LIGHTING SCALE: NONE



#### ③ LOCKABLE FUSED DISCONNECT DETAIL (TYP.) SCALE: NONE

### EQUIPMENT CONNECTION SCHEDULE

ITEM NO.	EQUIPMENT	LOCATION	LOAD DATA			SUPPLY DATA				CONTROLS					REMARKS
			KW HP AMPS	VOLTS	PHASE	PANEL	CKT. BRK.	WIRE	CDT.	VARIABLE FREQUENCY DRIVE	COMBINATION MAGNETIC MOTOR STARTER				
EF-1	EXHAUST FAN UNIT	ATTIC AREA	1/10HP	120	1	B-1	20A-1P	2#12+#12G	3/4"	DIV. 23	DIV. 23				

#### EQUIPMENT C & C SCHEDULE GENERAL NOTES:

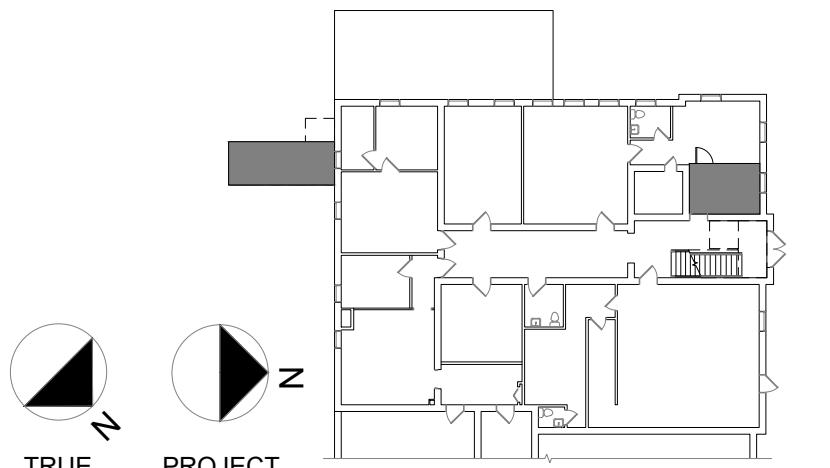
- ELECTRICAL CONTRACTOR SHALL ROUTE AND WIRE TO ALL EQUIPMENT AND SUPPLY 120V POWER FOR CONTROLS.
- ELECTRICAL CONTRACTOR SHALL PROVIDE ALL WIRING, CONDUIT FOR FIRE ALARM INTERFACE (IF APPLICABLE). LEAVE FOR FUTURE PROVISIONS.
- PROVIDE FIRE ALARM INTERFACE BETWEEN SMOKE DETECTOR, EXHAUST FAN AND MOTORIZED LOUVER. LEAVE FOR FUTURE PROVISIONS.

### LUMINAIRE SCHEDULE

FIXTURE TYPE	DESCRIPTION AND CATALOG NUMBER	VOLTAGE	LAMPS
B1	LED DOWNLIGHT, RECESSED TYPE. 1500-1700 LUMENS. LITHONIA LIGHTING, LRM4 SERIES OR APPROVED EQUAL. INCLUDE FLANGE KIT ADAPTORS.	120-208V	14W LED
C1	WALL SCONCE LED. 1450 LUMENS. PROGRESS LIGHTING. MODEL P560001-129-30 OR APPROVED EQUAL. INCLUDE MOUNTING ACCESORIES.	120-208V	18W LED
S1	LINEAR LED 4FT. LITHONIA FEM SERIES. 4000K. 3000LM. WHITE FINISH OR APPROVED EQUAL. PROVIDE ALL ACCESSORIES FOR MOUNTING.	120/208V	19W LED
W1	WALLPACK, OUTDOOR TYPE. LITHONIA MODEL OLWX1 LED 40W 50K 5. DARK BRONZE FINISH OR APPROVED EQUAL. ADD INTEGRAL PHOTOCELL.	120-208V	37W LED
X	EMERGENCY EXIT SIGN FIXTURE. LITHONIA, EDG SERIES. SURFACE MOUNT. BRUSH AL FINISH. AC OPTION OR APPROVED EQUAL.	120-208V	5W LED

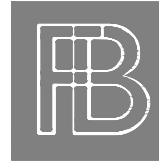
NOTE: COORDINATE FINAL FIXTURE MOUNTING LOCATION AND COLOR TEMPERATURE. PROVIDE ALL ACCESSORIES. COORDINATE WITH ARCHITECT COLOR FINISHES AND FINAL MOUNTING HEIGHTS. CONTRACTOR TO FIELD VERIFY EXISTING CIRCUIT VOLTAGE(S). PROVIDE ALL FIXTURES WITH DLC OR ENERGY STAR RATINGS AND WITH DIMMABLE CAPABILITIES.

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Drawing Title

## ELECTRICAL DETAILS AND SCHEDULES

Drawing Number

# E-02