ABBREVIATIONS

			ARRKEA	IAIIC)NS
&	AND	EP	ELECTRICAL PANEL	MAS	MASONRY
@ AB	AT ANCHOR BOLT	EPDM	ETHYLENE PROPYLENE DIENE	MATL MAX	MATERIAL MAXIMUM
AC	AIR CONDITIONING		M-CLASS	MECH	MECHANICAL
ACC ACOUST	ACCESSIBLE ACOUSTICAL	EQ EQUIP	EQUAL EQUIPMENT	MED MEMBR	MEDIUM MEMBRANE
ACCOUST	ACOUSTIC CEILING	EXH	EXHAUST	MH	MAN HOLE
AD	TILE ACCESS DOOR	EXIST EXP	EXISTING EXPANSION	MIN	MINIMUM
ADD	ADDENDUM	EXP'D	EXPOSED	MISC MO	MISCELLANEOUS MASONRY OPENING
ADJ AFF	ADJACENT ABOVE FINISHED	EXT FA	EXTERIOR FIRE ALARM	MR	MOISTURE RESISTANT
	FLOOR	FB	FACE BRICK	MTD	MOUNTED
AFG	ABOVE FINISHED GRADE	FD FDC	FLOOR DRAIN FIRE DEPARTMENT	MTG MTL	MOUNTING METAL
AGGR	AGGREGATE		CONNECTION	MULL	MULLION
ALT ALUM	ALTERNATE ALUMINUM	FE	FIRE EXTINGUISHER (WALL MOUNT)	N NA	NORTH NOT APPLICABLE
ANOD	ANODIZED	FEC	FIRE EXTINGUISHER CABINET	NC	NOISE CRITERIA
APC	ACOUSTICAL PANEL CEILING	FF&E	FURNITURE,	NIC NO	NOT IN CONTRACT NUMBER
APPROX ARCH	APPROXIMATE ARCHITECTURAL		FIXTURES AND EQUIPMENT	NOM	NOMINAL
ASPH	ASPHALT	FFB FFEL	FLUSH FLOOR BOX FINISH FLOOR	NON COMB NTS	NON COMBUSTIBLE NOT TO SCALE
ATTN AUTO	ATTENTION AUTOMATIC		ELEVATION	NW	NORTHWEST
AV	AUDIOVISUAL	FH FHC	FLAT HEAD FIRE HOSE CABINET	OA OC	OUTSIDE AIR ON CENTER
BD BET, BTW	BOARD BETWEEN	FIN	FINISH	OD	OUTSIDE DIAMETER
BIT	BITUMINOUS	FIXT FL	FIXTURE FLOOR	OD OFCI	OVERFLOW DRAIN OWNER FURNISHED,
BLDG BLK	BUILDING BLOCK	FLASH	FLASHING	O1 O1	CONTRACTOR INSTALLED
BLKG	BLOCKING	FLUOR FND	FLUORESCENT FOUNDATION	OFF	OFFICE
BM BO	BEAM BOTTOM OF	FO	FACE OF	OFOI	OWNER FURNISHED, OWNER INSTALLED
BOT	BOTTOM	FP FPG	FIRE PROTECTION FIREPROOFING	ОН	OPPOSITE HAND
BRG BRK	BEARING BRICK	FR	FIRE RESISTANT	OPNG OPP	OPENING OPPOSITE
BRKT	BRACKET	FRC	FIBER REINFORCED CONCRETE	OPP	OVERFLOW ROOF
BSMNT C	BASEMENT CHANNEL	FRT	FIRE RETARDANT TREATED	OVR	DRAIN OVERHEAD
CAB	CABINET	FT	FEET/FOOT	PAV	PAVING
CAT CB	CATEGORY CATCH BASIN	FTG FURN	FOOTING FURNITURE	PBD PC	PARTICLE BOARD PRECAST
СВ	CEMENT BOARD	FURN	FURRING	PDF	POWER DRIVEN
CBU	CEMENTITIOUS BACKER UNIT	FWC	FABRIC WALL COVERING	PERF	FASTENER PERFORATED
CC	CENTER TO CENTER	FWP	FABRIC WRAPPED	PERIM	PERIMETER
CCTV	CLOSED CIRCUIT TELEVISION	GA	PANEL GAUGE	PERP Pl.	PERPENDICULAR PLATE
CEM	CEMENT	GALV	GALVANIZED	PLAM	PLASTIC LAMINATE
CER CG	CERAMIC CORNER GUARD	GB GC	GRAB BAR GENERAL	PLAS PLBG	PLASTER PLUMBING
CH CI	CHILLER CAST IRON	GEN	CONTRACT(OR) GENERAL	PLF	POUNDS PER LINEAR FOOT
CIP	CAST-IN-PLACE	GFRC	GLASS FIBER	PLYWD	PLYWOOD
CJ CL	CONTROL JOINT CENTERLINE		REINFORCED CONCRETE	PNL PNT	PANEL PAINT OR PAINTED
CLG	CEILING	GL GLAZ	GLASS GLAZING	POL	POLISHED
CLR CLT	CLEAR CLOSET	GRAN	GRANULAR	POLYISO PR	POLYISOCYANURATE PAIR
CMT	CERAMIC MOSAIC	GRD GRFG	GROUND GLASS FIBER	PREFAB	PREFABRICATED
CMU	TILE CONCRETE	O O	REINFORCED GYPSUM	PROJ PSF	PROJECT POUNDS PER
CNTR	MASONRY UNIT COUNTER	GSM	GALVANIZED SHEET	PT	SQUARE FOOT PRESSURE TREATED
СО	CLEANOUT	GV	METAL GAS VALVE	PTN	PARTITION
COL	COLUMN CONCRETE	GWB	GYPSUM WALL	PVC	POLYVINYL CHLORIDE
COND	CONDITION	GYP	BOARD GYPSUM	QT QTV	QUARRY TILE
CONN CONST	CONNECTION CONSTRUCTION	H HB	HIGH/HEIGHT HOSE BIB	QTY R	QUANTITY RADIUS/RISER
CONT	CONTINUOUS	HC	HANDICAPPED	RA	RETURN AIR
CONTR	CONTRACTOR COORDINATE	HDWD	HARDWARE	RAD RB	RADIUS RESILIENT BASE
CORR	CORRIDOR	HDWD HM	HARDWOOD HOLLOW METAL	RBR	RUBBER
CPT CT	CARPET CERAMIC TILE	HNDRL	HANDRAIL HOLD OPEN	RCP	REFLECTED CEILING PLAN
CTR	CENTER	HO HORIZ	HOLD OPEN HORIZONTAL	RD REC	ROOF DRAIN RECESSED
CTSK CW	COUNTERSUNK COLD WATER	HP HR	HIGH POINT HOUR	RECPT	RECEPTACLE
CWT	CERAMIC WALL TILE	HRC	HOSE REEL CABINET	REF REFR	REFERENCE REFRIGERATOR
D DBL	DEEP, DEPTH DOUBLE	HT HTR	HEIGHT HEATER	REG	REGISTER
DEG DEMO	DEGREE DEMOLISH OR	HVAC	HEATING	REINF	REINFORCED/REINFO RCING
DEMO	DEMOLITION		VENTILATION AND AIR CONDITIONING	REL	RELOCATE
DEPT DET	DEPARTMENT DETAIL	HW ID	HOT WATER INSIDE DIAMETER	REM REOOM	REMOVABLE RECOMMENDED
DF	DRINKING FOUNTAIN	IGU	INSULATED GLASS	REQ RESII	REQUIRE/REQUIRED
DIA DIFF	DIAMETER DIFFUSER	IN	UNIT INCH/INCHES	RESIL REV	RESILIENT REVISION/REVISED
DIM	DIMENSION	INCAND	INCANDESCENT	RM RND	ROOM ROUND
DIMS DISP	DIMENSIONS DISPENSER	INCL	INCLUDED/INCLUDIN G	RO	ROUGH OPENING
DIV	DIVISION	INFO INSUL	INFORMATION INSULATION OR	ROW RTD	RIGHT OF WAY RATED
DMPF DN	DAMP PROOFING DOWN		INSULATED	RTG	RATING
DO DR	DOOR OPENING DOOR	INT INTERM	INTERIOR INTERMEDIATE	RWL S	RAIN WATER LEADER SOUTH
DRN	DRAIN	INV JAN	INVERT JANITOR	S/S	SANITARY/STORM SEWER
DS DTL	DOWNSPOUT DETAIL	JAN JC	JANITOR JANITOR'S CLOSET	SA	SUPPLY AIR
DW	DISHWASHER	JST JT	JOIST JOINT	SAF	SELF ADHERED FLASHING
DWG DWR	DRAWING DRAWER	KIT	KITCHEN	SC	SOLID CORE
E	EAST	KO LAM	KNOCK OUT LAMINATED	SCHED SD	SCHEDULE STORM DRAIN
EA EB	EACH EXPANSION BOLT	LAV	LAVATORY	SE	SOUTHEAST
EJ	EXPANSION JOINT	LB LF	POUNDS LINEAR FEET	SECT SF	SECTION SQUARE FEET/FOOT
EL ELEC	ELEVATION ELECTRICAL	LLH	LONG LEG	SH SHR	SPRINKLER HEAD SHOWER
ELEV EMER	ELEVATOR EMERGENCY	LLV	HORIZONTAL LONG LEG VERTICAL	SHT	SHEET
ENCL	ENCLOSURE	LT LWT	LIGHT LIGHTWEIGHT	SIM SM	SIMILAR SHEET METAL
ENG	ENGINEER	MANUF	MANUFACTURER	SM	SURFACE MOUNTED

LOCATION PLAN



VILLAGE OF PERRY, NEW YORK

PERRY VILLAGE HALL **ADA IMPROVEMENTS**

VILLAGE OF PERRY 46 N. MAIN ST. **PERRY, NY 14530 CONSTRUCTION BID SET**

APRIL 5, 2021

GRANT REQUIREMENTS & HISTORIC SIGNIFICANCE:

HISTORIC SIGNIFICANCE:

SANITARY NAPKIN

STAINLESS STEEL SERVICE SINK STAIN & VARNISH

STATION SOUND

COEFFICIENT **STANDARD SEATING** STEEL **STORAGE**

STRINGER

STRUCTURAL

SHEET VINYL SOUTHWEST SYMMETRICAL SYSTEM

TOP AND BOTTOM

TELEPHONE/TELECO

TONGUE AND **GROOVE**

TOWEL BAR

TEMPORARY THICKNESS THRESHOLD

THROUGH TACK BOARD TOILET

TEMPERED TOP OF

TOP OF BEAM

TOP OF STEEL

TOILET PAPER

UNDERWRITERS

LABORATORIES

UNLESS OTHERWISE

VENTILATION AND AIR CONDITIONING

VINYL ASBESTOS

VAPOR BARRIER VINYL COMPOSITION

VERIFY IN FIELD

VAPOR RETARDER

VISION PANEL

UNFINISHED

OTHERWISE

NOTED

URINAL

VARIES

VERTICAL

VESTIBULE

VINYL TILE VENT THROUGH

VINYL WALL

COVERING

WIDE/WEST

WATER CLOSET

WATERPROOF/WATE

WEATHER-STRIPPING

WITH

WITHOUT

WOOD

WINDOW

WIRE MESH

WATERPROOF

WATER VALVE

WELDED WIRE

WELDED WIRE MESH

MEMBRANE

WAINSCOT

WEIGHT

FABRIC

TILE

VAT

VCT

VERT

VEST

VTR

WSCT

WT

WWF

DISPENSER

TYPICAL

TOP OF CONCRETE

TREAD

STA

DISPOSAL **SEALANT** STANDPIPE SPECIFIED OR SPECIFICATION SPRINKLER OR SPEAKER SPEAKER **SQUARE**

> PERRY VILLAGE HALL HAS BEEN DETERMINED ELIGIBLE FOR LISTING ON THE NATIONAL REGISTER OF HISTORIC PLACES. ALL WORK OF THIS PROJECT MUST BE COMPLETED IN ACCORDANCE WITH THE "SECRETARY OF THE INTERIOR'S STANDARDS",

GRANT FUNDING REQUIREMENTS:

THIS PROJECT IS FUNDED BY A COMMUNITY WORK MUST BE COMPLETED ACCORDING TO THE

ARCHITECTURE

FLYNN BATTAGLIA ARCHITECTS, D.P.C. 617 Main Street Suite 40 I

Buffalo, New York 14203 Telephone (716) 854-2424

STRUCTURAL ENGINEERING

PETRILLI ENGINEERING, P.C. 245 Kinsey Ave.

Kenmore, New York 14217 Telephone (716) 854-3508

MEP/F ENGINEERING

P.MAX ENGINEERING, P.C.

598 Lafayette Ave. Suite 6 Buffalo, NY 14222 Telephone (716) 381-9389

DRAWING LIST

CODE CONFORMANCE

CODE CONFORMANCE

SITEWORK A1-00

SITE PLAN

DEMOLITION AD-01 AD-02

DEMOLITION PLANS DEMOLITION PLANS

ARCHITECTURAL A1-01

BASEMENT AND GROUND FLOOR PLANS A1-02 FIRST AND SECOND FLOOR PLANS A2-01 **ELEVATIONS** A5-01 ELEVATOR PLANS, SECTION & DETAILS A5-02 STAIR PLANS, SECTION & DETAILS A6-01 WINDOW & DOOR SCHEDULES, TYPES & DETAILS

ELEVATOR PLANS

A6-02 PARTITION & FINISH SCHEDULES REFLECTED CEILING PLANS A7-01

STRUCTURAL S1-01

PLUMBING

P1-01

M1-01

E-03

S1-02 STAIR PLANS S2-01 **DETAILS** S2-02 **DETAILS**

MECHANICAL


ATTIC PLAN - MECHANICAL

ELECTRICAL ED-01 E-01


ELECTRICAL DEMOLITION PLAN ELECTRICAL FLOOR PLANS **ELECTRICAL DETAILS AND SCHEDULES**


FIRST FLOOR PLAN - PLUMBING

REFERENCE SYSTEMS

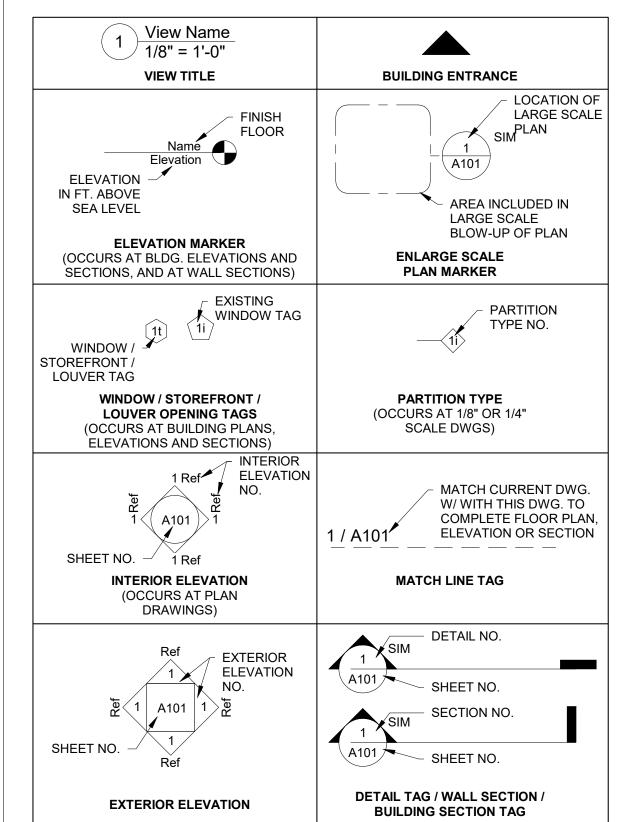


KEY TO MATERIALS

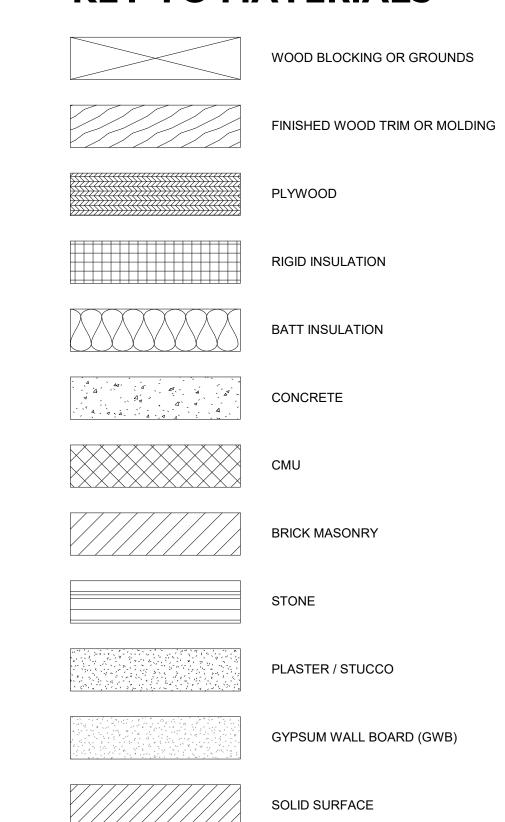

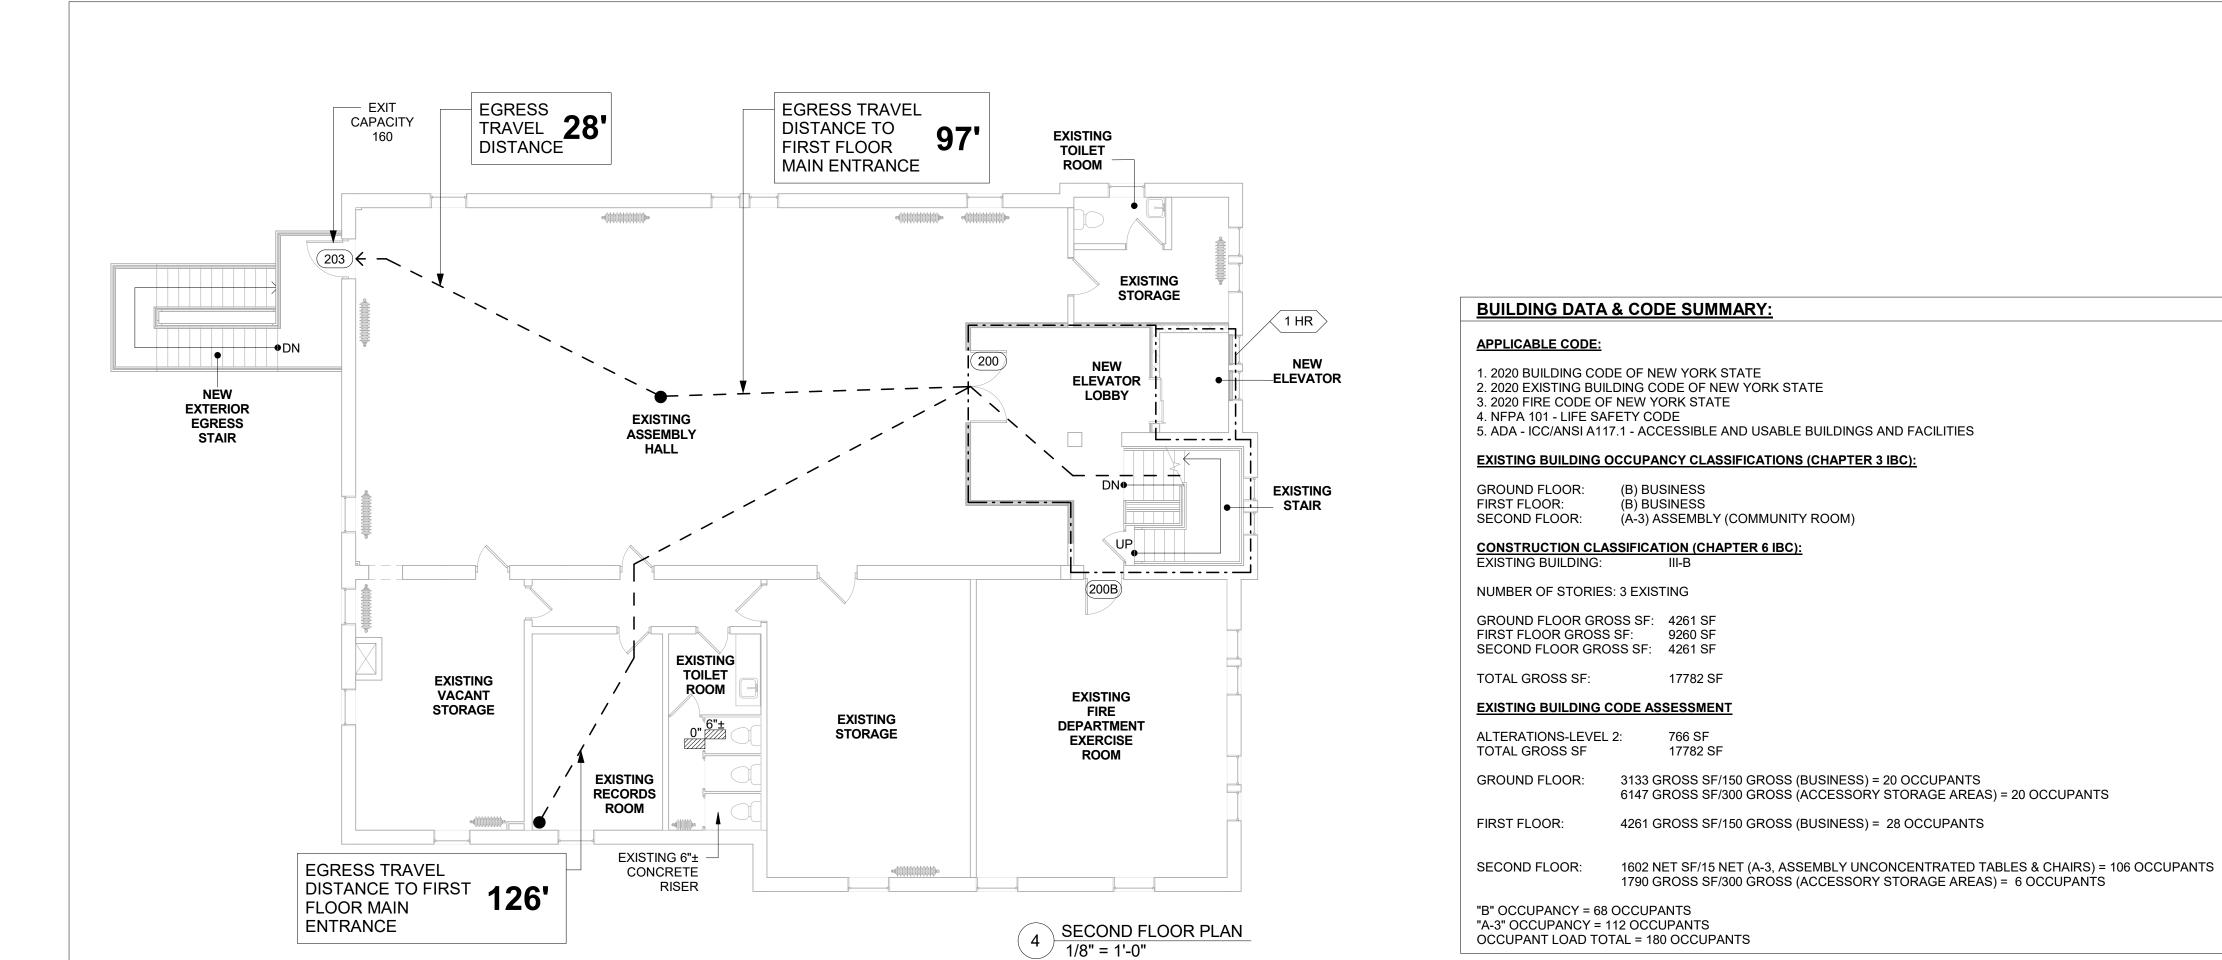

FIRST FLOOR PLAN

1/8" = 1'-0"

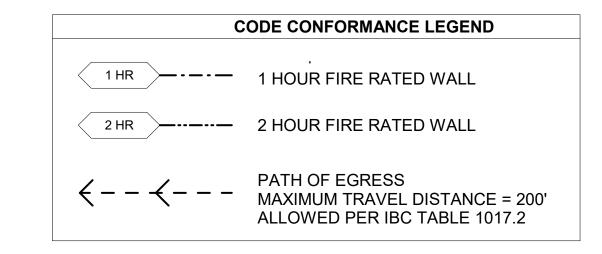


PLUMBING SYSTEMS							
	CODE OF NEW	S PER BUILDING / YORK STATE, R "B" OCCUPANCY	REQUIREMENTS PER BUILDING CODE OF NEW YORK STATE, TABLE 2902.1 FOR "A-3" OCCUPANCY				
	MALE	FEMALE	MALE	FEMALE			
WATER CLOSETS	1 PER 25 FOR THE FIRST 50 AND 1 PER 50 FOR THE REMAINDER EXCEEDING 50	1 PER 25 FOR THE FIRST 50 AND 1 PER 50 FOR THE REMAINDER EXCEEDING 50	1 PER 125	1 PER 65			
LAVATORIES	1 PER 40 FOR THE FIRST 80 AND 1 PER 80 FOR THE REMAINDER EXCEEDING 80	1 PER 40 FOR THE FIRST 80 AND 1 PER 80 FOR THE REMAINDER EXCEEDING 80	1 PER 200	1 PER 200			
DRINKING FOUNTAINS	1 PER	100	1 PER	500			
SERVICE SINKS	1 PEF	RFL	1 PER	R FL			

<u>PLUMBING CALCULATIONS:</u> NUMBER OF "B" OCCUPANTS = 68/2 = 32 MALE & 32 FEMALE NUMBER OF "A-3" OCCUPANTS = 112/2 = 56 MALE & 56 FEMALE

		PLUM	IBING	SYS	TEMS					
	REQUIREMENTS PER BUILDING CODE OF NEW YORK STATE, TABLE 2902.1 FOR "B" OCCUPANCY				REQUIREMENTS PER BUILDING CODE OF NEW YORK STATE, TABI 2902.1 FOR "A-3" OCCUPANCY			ABLE		
	REQUIRED PROVIDED		REQUIRED		PROVIDED					
	М	F	М	F	U	М	F	М	F	U
WATER CLOSETS	2	2	-	-	5	1	2	-	3	1
LAVATORIES	1	1	-	-	5	1	1	-	1	1
DRINKING FOUNTAINS	1	1		0			1		0	
SERVICE SINKS	1			0			1		0	

2 GROUND FLOOR PLAN
1/8" = 1'-0"

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THE REGISTERED PROFESSIONAL

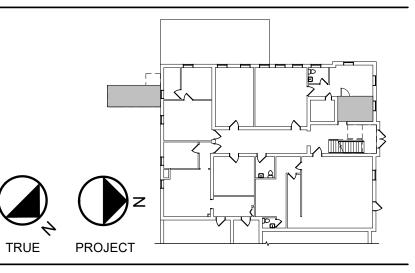DATE 01/05/2020



FLYNN BATTAGLIA

617 Main Street, Suite 401 Buffalo, New York 14203 Telephone (716) 854-2424



PETRILLI STRUCTURAL & CONSULTING ENGINEERING, P.C.

245 Kinsey Ave Kenmore, New York 14217 Telephone (716) 854-3508



P.MAX ENGINEERING, P.C.

598 Lafayette Ave Buffalo, New York 14222 Telephone (716) 381-9389

PERRY VILLAGE HALL ADA IMPROVEMENTS

VILLAGE OF PERRY 46 N. MAIN ST. **PERRY, NY 14530**

> **100% CONSTRUCTION DOCUMENT BID SET**

NOTES & REVISIONS:

Revision Schedule Revision Number Description


DRAWING ISSUED: APRIL 5, 2021 Project Number: Scale: As indicated Drawn By: Checked By: MM, LM


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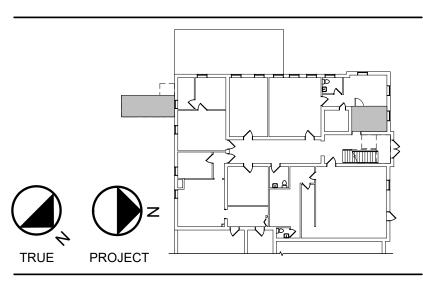
CODE CONFORMANCE

Drawing Number

CC-01



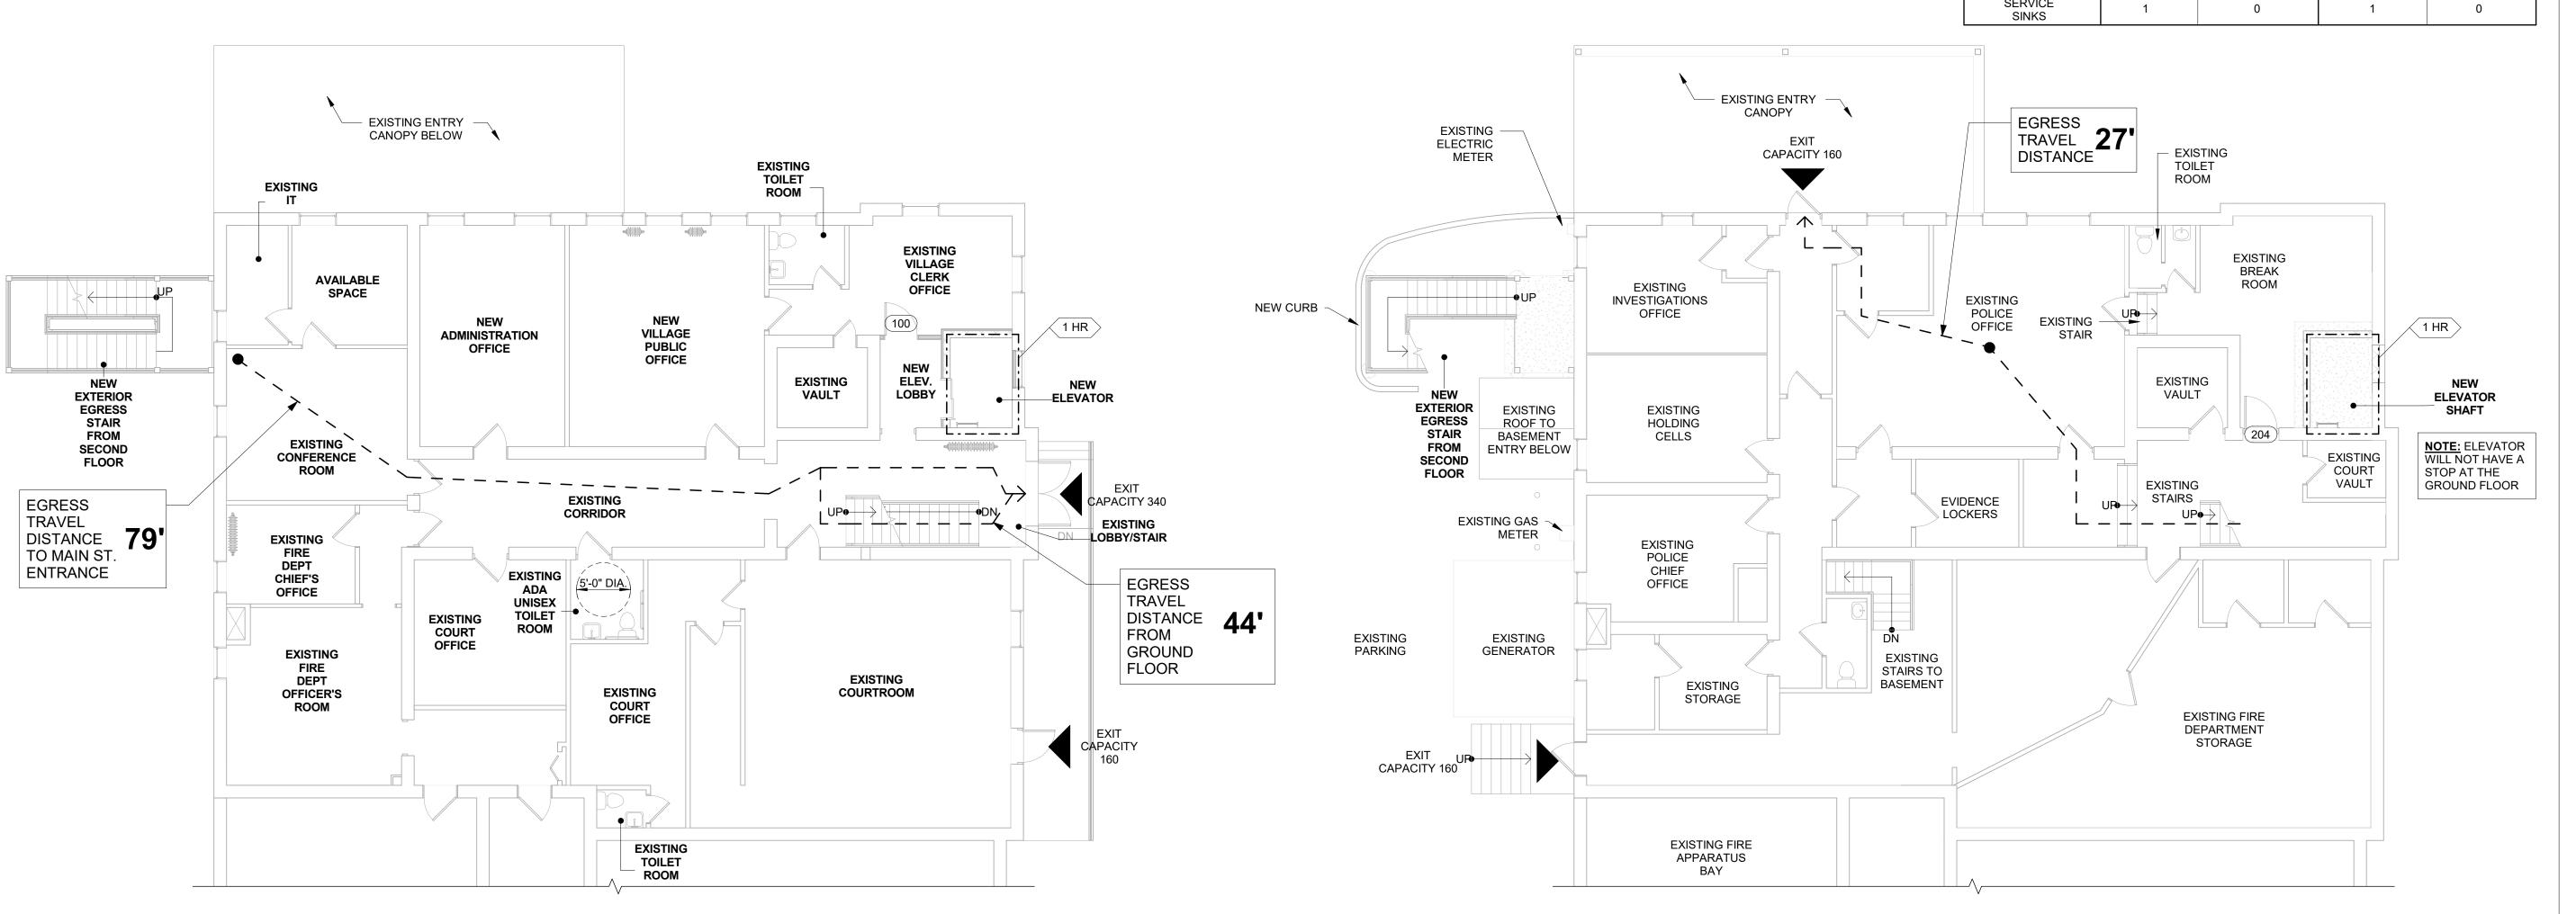

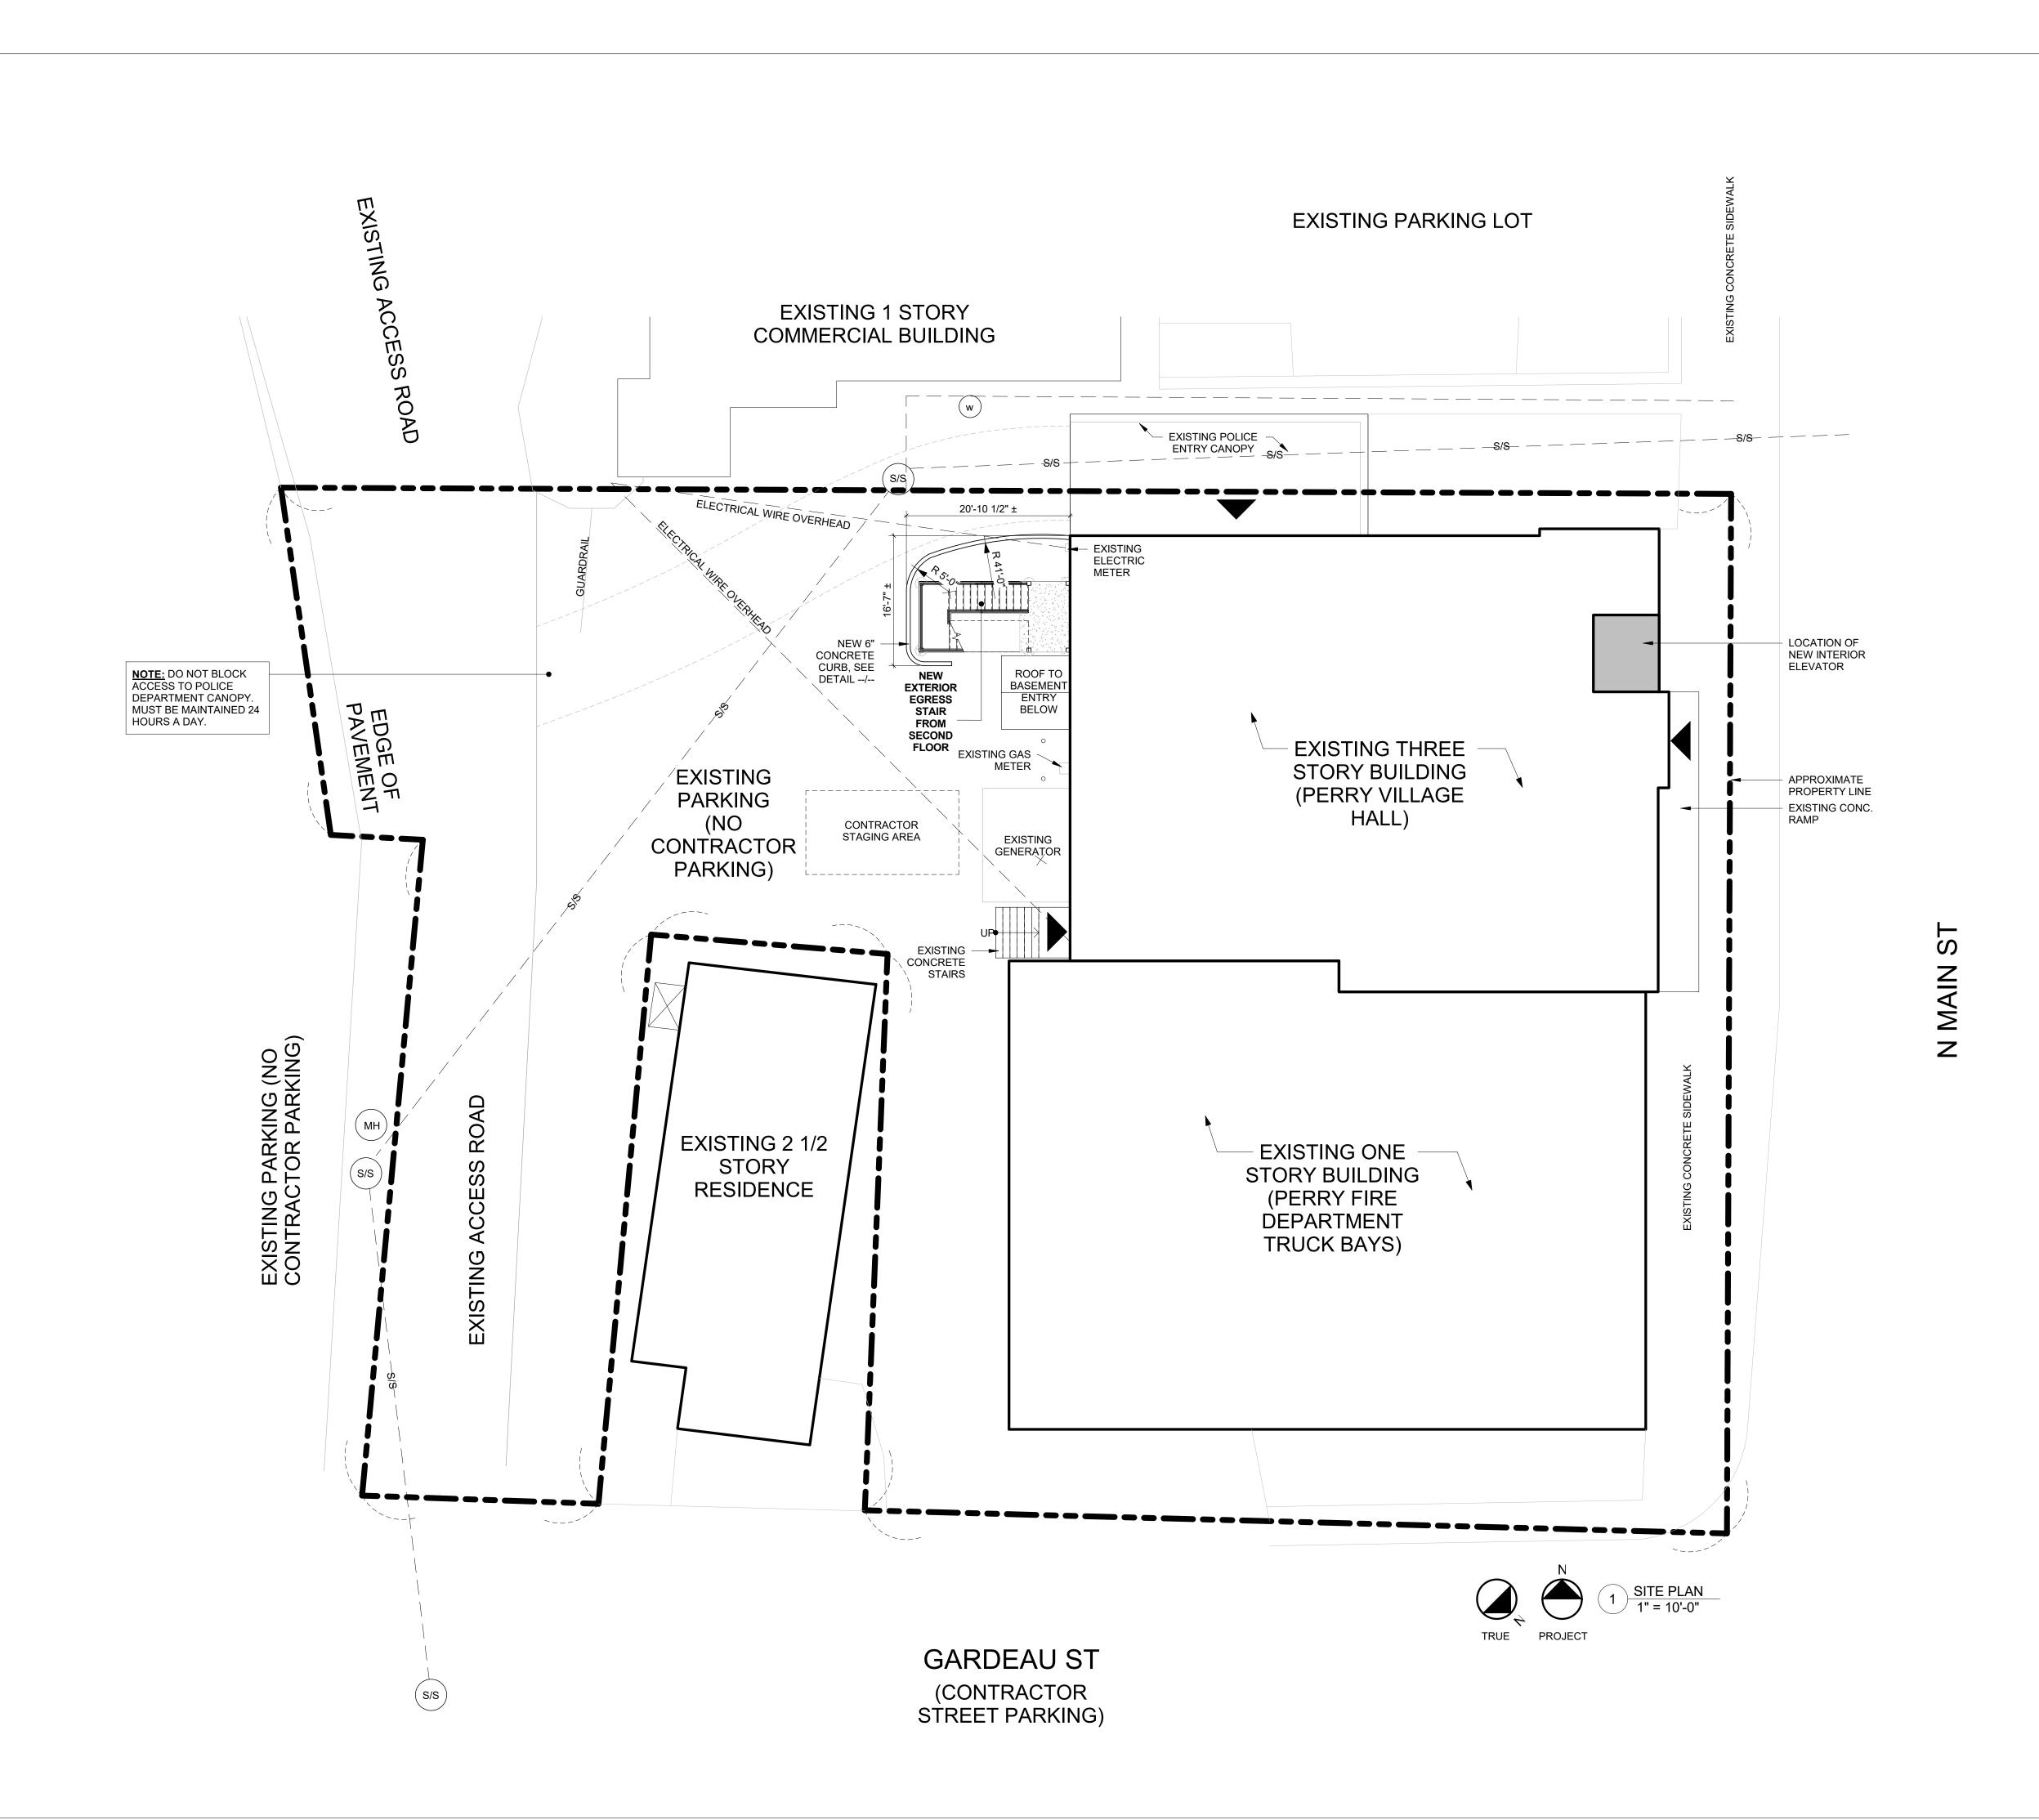

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FLYNN | BATTAGLIA

617 Main Street, Suite 401 Buffalo, New York 14203 Telephone (716) 854-2424



PETRILLI STRUCTURAL & CONSULTING ENGINEERING, P.C.

245 Kinsey Ave Kenmore, New York 14217 Telephone (716) 854-3508



P.MAX ENGINEERING, P.C.

598 Lafayette Ave Buffalo, New York 14222

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100% CONSTRUCTION **DOCUMENT BID SET**

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Revision Number	Date	Description							


DRAWING ISSUED:	APRIL 5, 2021
Project Number:	Scale:
00370	1" = 10'-0"
Drawn By:	Checked By:
MB	MM, LM

Drawing Title

SITE PLAN

Drawing Number

A1-00

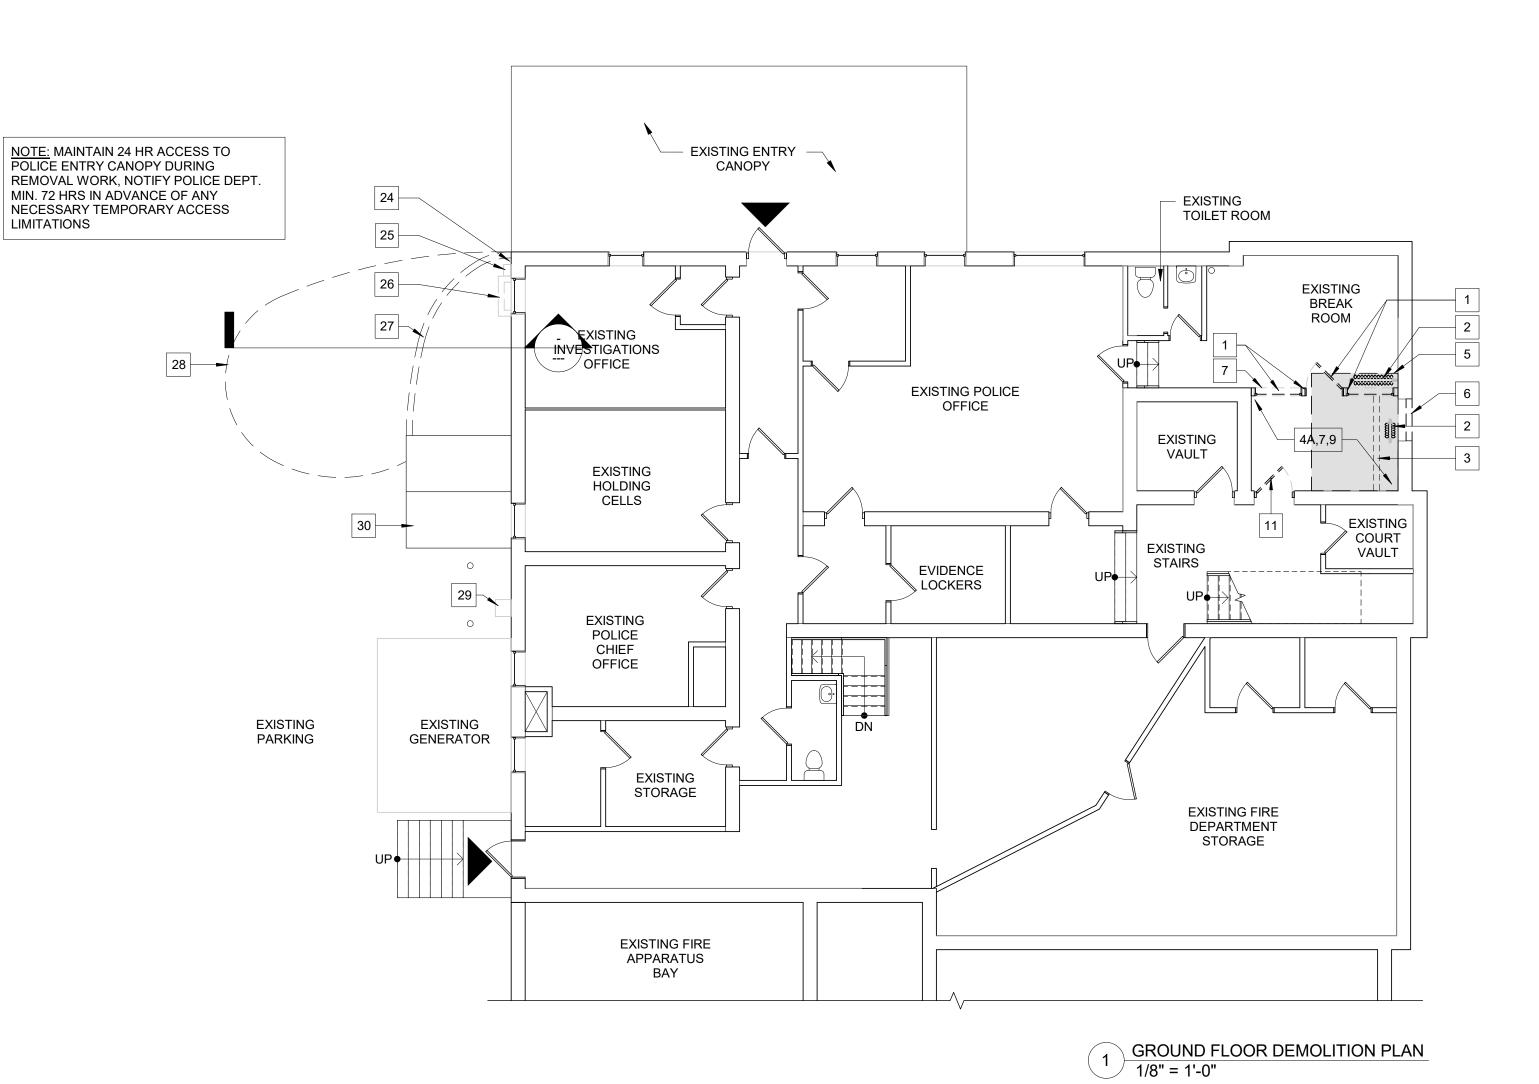


- DRAWINGS MAY NOT INDICATE ALL DEMOLITION / REMOVALS. CONTRACTOR IS TO REFER TO ALL DRAWINGS, SPECIFICATIONS AND FIELD CONDITIONS TO DETERMINE FULL SCOPE AND PARTICULARS OF REMOVAL REQUIREMENTS PRIOR TO CONSTRUCTION.
- ALL DIMENSIONS ARE +/- AND ARE TO BE VERIFIED IN FIELD BEFORE PROCEEDING WITH WORK
- RESTORE ALL EXIST. CONDITIONS DAMAGED DURING REMOVAL WORK AND NOT SCHEDULED TO BE REMOVED, TO MATCH EXIST. CONDITIONS. ALL AREAS REQUIRING CUTTING AND PATCHING SHALL BE FINISHED TO MATCH ADJACENT SURFACES UNLESS NOTED OTHERWISE. PATCH ALL HOLES IN FLOORS AND WALLS WITH A FIRE STOP MATERIAL (SEE SPECS) WHERE CONDUIT, PIPING, DUCTWORK, ETC. HAS BEEN REMOVED. COORD. WITH ELEC AND PLUMB. DRAWINGS.
- UNLESS OTHERWISE NOTED, ALL REMOVALS IDENTIFIED IN THESE NOTES BECOME PROPERTY OF THE CONTRACTOR MAKING THE REMOVAL.
- COORDINATE ALL DEMOLITION WORK INDICATED ON THIS DRAWING WITH THAT OF THE OTHER TRADES. COORD. WITH ELEC AND PLUMB. DRAWINGS FOR ADDITIONAL DEMOLITION WORK.
- F. STABILIZATION OF THE EXISTING PORTIONS OF THIS BUILDING SCHEDULED TO REMAIN DURING AND AFTER THE DEMOLITION WORK WILL REQUIRE A PARTICULAR SEQUENCE OF WORK.
- REFER TO ASBESTOS CONTAINING MATERIALS REPORT IN PROJECT MANUAL FOR REMOVALS REQUIRED IN THIS PROJECT'S SCOPE OF WORK PRIOR TO START OF CONSTRUCTION.
- ALL WORK AREAS INVOLVING DEMOLITION, CUTTING, MODIFICATION, ETC. TO ANY EXISTING MATERIALS SHALL BE CONSIDERED A LEAD HAZARD AREA.
- DUE TO THE HISTORIC NATURE OF THIS EXISTING BUILDING, ALL WORK AREAS SHOULD BE PROPERLY PROTECTED AND THOROUGHLY CLEANED AT THE END OF CONSTRUCTION.

SPECIFIC FLOOR PLAN DEMOLITION NOTES:

GENERAL DEMOLITION NOTES (FLOOR PLANS):

- REMOVE EXISTING WALL, INCLUDING EXISTING DOOR AND WINDOW ASSEMBLIES IN THEIR ENTIRETY (SALVAGE AND RETURN TO OWNER), PROVIDE SUPPORT AT WALL REMOVAL AS REQUIRED.
- SALVAGE EXISTING RADIATOR FOR REINSTALLATION, SEE MEP DRAWINGS FOR MORE INFORMATION.
- REMOVE EXISTING STEAM PIPING AS REQUIRED FOR NEW ELEVATOR SHAFT WALLS, SEE MEP DRAWINGS FOR MORE INFORMATION.
- REMOVE EXISTING FLOOR TILE IN ITS ENTIRETY INCLUDING MASTIC TO CONCRETE FLOOR BELOW. FLOOR TILE IS KNOWN TO BE ASBESTOS-CONTAINING, SEE HAZMAT REPORT IN PROJECT MANUAL FOR MORE INFORMATION.
- REMOVE EXISTING FLOOR TILE IN ITS ENTIRETY.
- SAWCUT EXISTING CONCRETE SLAB AS REQUIRED FOR NEW FOUNDATIONS, SEE S-SERIES DRAWINGS FOR MORE INFORMATION.
- REMOVE EXISTING INFILL, WOOD SILL AND TRIM AT EXISTING OPENING IN WALL, PREP FOR INFILL.
- REMOVE EXISTING WOOD CHAIR RAIL AT WALLS IN THEIR ENTIRETY, SALVAGE AND RETURN TO
- CAREFULLY REMOVE EXISTING WOOD DOOR & FRAME IN ITS ENTIRETY. SALVAGE FOR RE-
- SALVAGE EXISTING SURFACE MOUNTED LIGHT AT CEILING FOR REINSTALLATION, SEE E-SERIES DRAWINGS FOR MORE INFORMATION.
- REMOVE PORTION OF LOAD-BEARING WALL (ASSUMED) AS REQUIRED FOR NEW OPENING, SHORE AS REQUIRED, SEE S-SERIES DWGS.
- TEMPORARILY REMOVE DOOR FROM HINGES AND STORE AWAY FROM WORK AREA, REINSTALL AT
- CONCLUSION OF WORK. PROTECT DOOR FRAME DURING CONSTRUCTION.
- REMOVE EXISTING WINDOW IN ITS ENTIRETY, REMOVE PORTION OF EXISTING BRICK WALL BELOW WINDOW TO EXISTING SECOND FINISHED FLOOR ELEVATION, PREP FOR NEW DOOR, MODIFY EXISTING LINTEL AS REQUIRED FOR NEW DOOR OPENING.
- REMOVE PORTION OF LOAD-BEARING (ASSUMED) AS REQUIRED FOR NEW DOOR OPENING, SHORE AS REQUIRED, SEE S-SERIES DWGS.
- REMOVE EXISTING METAL DOOR & FRAME IN ITS ENTIRETY.
- REMOVE EXISTING PLUMBING FIXTURES IN THEIR ENTIRETY, CAP PLUMBING AS REQUIRED, SEE P-
- REMOVE SURFACE MOUNTED LIGHT AT CEILING ABOVE, SALVAGE FOR REINSTALLATION, SEE E-SERIES DWGS FOR MORE INFORMATION.
- REMOVE EXISTING WINDOWS IN THEIR ENTIRETY, PREP FOR NEW WINDOW.
- REMOVE PORTION OF EXISTING WOOD FLOOR STRUCTURE AS REQUIRED FOR NEW ELEVATOR, SHORE AS REQUIRED, SEE S-SERIES DWGS FOR DETAILS FOR RE-SUPPORTING FLOOR SURROUNDING OPENING.
- EXISTING WOOD FLOOR TO BE PROTECTED DURING CONSTRUCTION.
- REMOVE EXISTING CARPET IN ITS ENTIRETY. NOTIFY ARCHITECT OF CONDITION OF EXISTING TILE INCLUDING AREAS OF DAMAGED OR MISSING TILE. IF ARCHITECT DECIDES THAT THE TILE IS ARE IN ACCEPTABLE CONDTION, CONTRACTOR TO CAREFULLY CLEAN ADHESIVE FROM THE EXISTING TILE. USE A MIXTURE OF WARM WATER, AMMONIA, AND A TEASPOON OF MILD DISH DETERGENT PER BUCKET OF WATER. SCRUB USING A NYLON OR NATURAL BRISTLE BRUSH. IF THIS MIXTURE IS INSUFFICIENT TO FULLY REMOVE ADHESIVE, COORDINATE WITH ARCHITECT. DO NOT USE A MORE ABRASIVE METHOD WITHOUT ARCHITECT'S APPROVAL. WHERE TILE IS MISSING OR DAMAGED, REPLACE WITH SALVAGED OR NEW MOSAIC TILE TO MATCH (INCLUDING GROUT COLOR). REPLACEMENT TILE CAN BE SOURCED FROM MULTIPLE MANUFACTURERS INCLUDING: AMERICAN RESTORATION TILE, MABELVALE, AR, PH: (501) 455-1000.
- REMOVE PORTION OF EXISTING CONCRETE FLOOR STRUCTURE AS REQUIRED FOR NEW ELEVATOR, SHORE AS REQUIRED, SEE S-SERIES DWGS FOR DETAILS FOR RE-SUPPORTING FLOOR SURROUNDING OPENING.
- REMOVE EXISTING NON-LOAD BEARING WALL AS SHOWN. PATCH AND REPAIR EXISTING WALL AND ADJACENT FINISHES TO REMAIN (MATCH EXISTING).
- CAREFULLY REMOVE WOOD DOOR & FRAME IN ITS ENTIRETY, SALVAGE AND RETURN TO OWNER.
- REMOVE EXISTING EXTENSION AT BASE OF DOWNSPOUT.
- EXISTING ELECTRIC METER TO REMAIN.
- REMOVE EXISTING WINDOW & CONCRETE WINDOW WELL AT BASEMENT LEVEL (GROUND FLOOR LEVEL WINDOW TO REMAIN).
- REMOVE EXISTING CONCRETE CURB AND ROCK BED, SALVAGE ROCKS FOR REINSTALLATION.
- REMOVE PORTION OF EXISTING ASPHALT PARKING AREA AS REQUIRED FOR NEW EXTERIOR STAIR.
- EXISTING GAS METER TO REMAIN.
- EXISTING ROOF TO BASEMENT ENTRY BELOW.
- EXISTING TILE FLOOR TO REMAIN.
- EXISTING CARPET TO REMAIN.

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DATE 01/05/2020

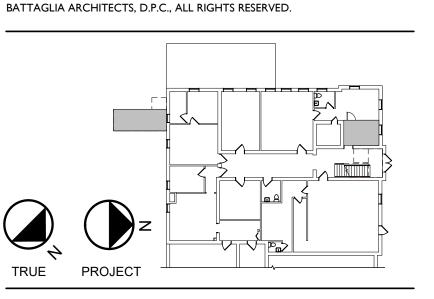FLYNN BATTAGLIA

617 Main Street, Suite 401 Buffalo, New York 14203 Telephone (716) 854-2424



ENGINEERING, P.C. 245 Kinsey Ave Kenmore, New York 14217 Telephone (716) 854-3508



P.MAX ENGINEERING, P.C.

598 Lafayette Ave Buffalo, New York 14222 Telephone (716) 381-9389

PERRY VILLAGE HALL ADA IMPROVEMENTS

VILLAGE OF PERRY 46 N. MAIN ST. **PERRY, NY 14530**

> 100% CONSTRUCTION **DOCUMENT BID SET**

NOTES & REVISIONS:


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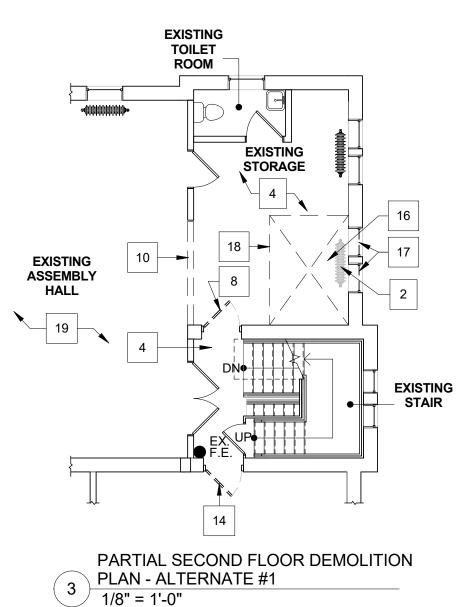
DRAWING ISSUED: APRIL 5, 2021 **Project Number:** Scale: As indicated Drawn By: Checked By: MM, LM


Drawing Title

DEMOLITION PLANS

Drawing Number



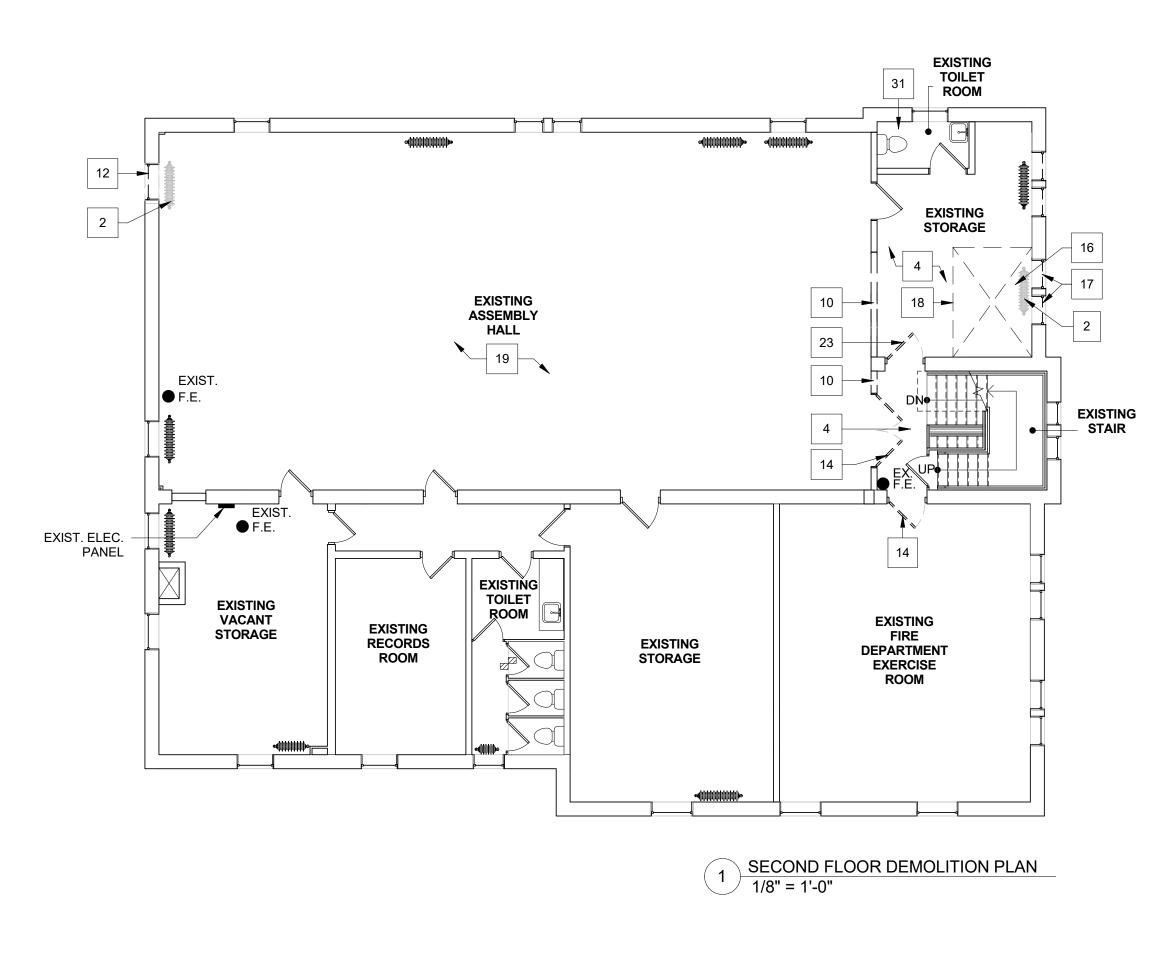

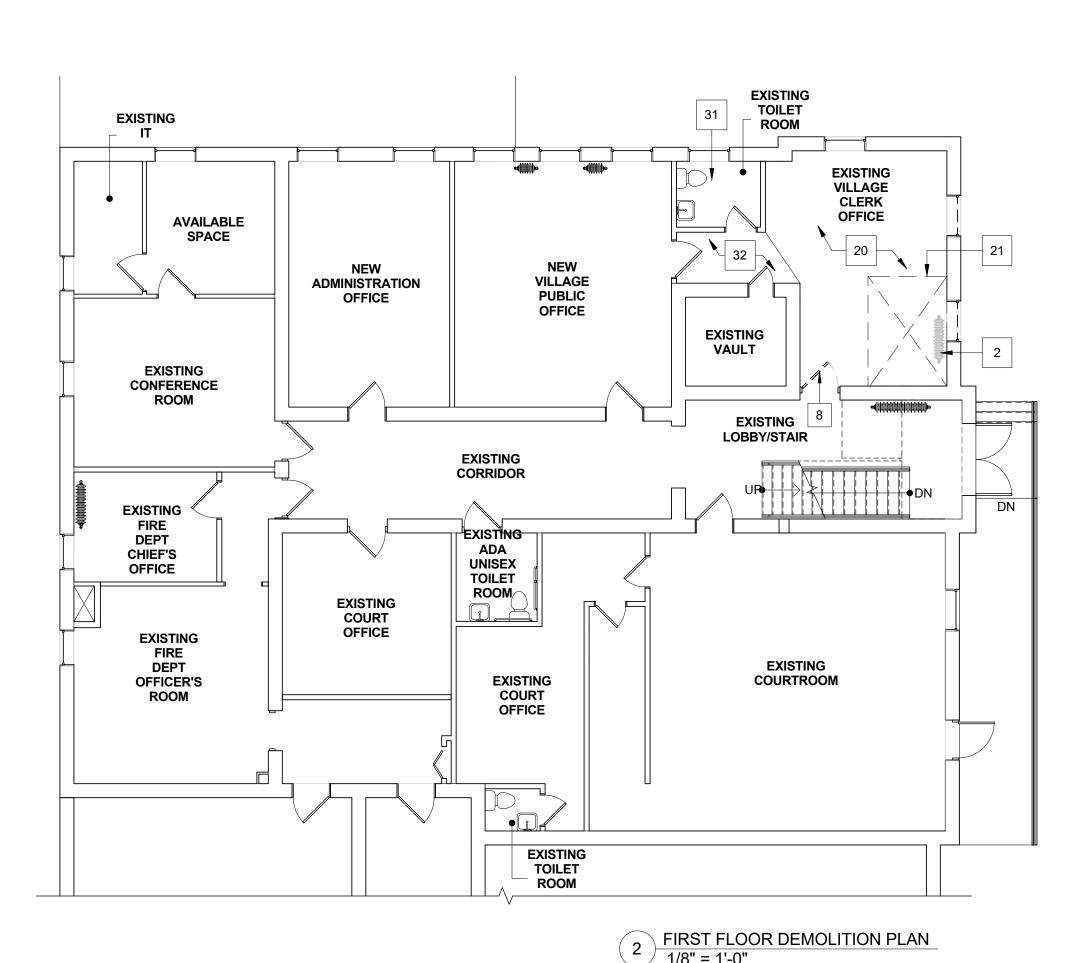

GENERAL DEMOLITION NOTES (FLOOR PLANS):

- DRAWINGS MAY NOT INDICATE ALL DEMOLITION / REMOVALS. CONTRACTOR IS TO REFER TO ALL DRAWINGS, SPECIFICATIONS AND FIELD CONDITIONS TO DETERMINE FULL SCOPE AND PARTICULARS OF REMOVAL REQUIREMENTS PRIOR TO CONSTRUCTION.
- ALL DIMENSIONS ARE +/- AND ARE TO BE VERIFIED IN FIELD BEFORE PROCEEDING WITH WORK
- C. RESTORE ALL EXIST. CONDITIONS DAMAGED DURING REMOVAL WORK AND NOT SCHEDULED TO BE REMOVED, TO MATCH EXIST. CONDITIONS. ALL AREAS REQUIRING CUTTING AND PATCHING SHALL BE FINISHED TO MATCH ADJACENT SURFACES UNLESS NOTED OTHERWISE. PATCH ALL HOLES IN FLOORS AND WALLS WITH A FIRE STOP MATERIAL (SEE SPECS) WHERE CONDUIT, PIPING, DUCTWORK, ETC. HAS BEEN REMOVED. COORD. WITH ELEC AND PLUMB. DRAWINGS.
- D. UNLESS OTHERWISE NOTED, ALL REMOVALS IDENTIFIED IN THESE NOTES BECOME PROPERTY OF THE CONTRACTOR MAKING THE REMOVAL.
- COORDINATE ALL DEMOLITION WORK INDICATED ON THIS DRAWING WITH THAT OF THE OTHER TRADES. COORD. WITH ELEC AND PLUMB. DRAWINGS FOR ADDITIONAL DEMOLITION WORK.
- F. STABILIZATION OF THE EXISTING PORTIONS OF THIS BUILDING SCHEDULED TO REMAIN DURING AND AFTER THE DEMOLITION WORK WILL REQUIRE A PARTICULAR SEQUENCE OF WORK.
- REFER TO ASBESTOS CONTAINING MATERIALS REPORT IN PROJECT MANUAL FOR REMOVALS REQUIRED IN THIS PROJECT'S SCOPE OF WORK PRIOR TO START OF CONSTRUCTION.
- H. ALL WORK AREAS INVOLVING DEMOLITION, CUTTING, MODIFICATION, ETC. TO ANY EXISTING MATERIALS SHALL BE CONSIDERED A LEAD HAZARD AREA.
- J. DUE TO THE HISTORIC NATURE OF THIS EXISTING BUILDING, ALL WORK AREAS SHOULD BE PROPERLY PROTECTED AND THOROUGHLY CLEANED AT THE END OF CONSTRUCTION.

SPECIFIC FLOOR PLAN DEMOLITION NOTES:

- REMOVE EXISTING WALL, INCLUDING EXISTING DOOR AND WINDOW ASSEMBLIES IN THEIR ENTIRETY (SALVAGE AND RETURN TO OWNER), PROVIDE SUPPORT AT WALL REMOVAL AS REQUIRED.
- SALVAGE EXISTING RADIATOR FOR REINSTALLATION, SEE MEP DRAWINGS FOR MORE INFORMATION.
- 3. REMOVE EXISTING STEAM PIPING AS REQUIRED FOR NEW ELEVATOR SHAFT WALLS, SEE MEP DRAWINGS FOR MORE INFORMATION.
- 4. REMOVE EXISTING FLOOR TILE IN ITS ENTIRETY INCLUDING MASTIC TO CONCRETE FLOOR BELOW. FLOOR TILE IS KNOWN TO BE ASBESTOS-CONTAINING, SEE HAZMAT REPORT IN PROJECT MANUAL FOR MORE INFORMATION.
- 4A. REMOVE EXISTING FLOOR TILE IN ITS ENTIRETY.


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- 5. SAWCUT EXISTING CONCRETE SLAB AS REQUIRED FOR NEW FOUNDATIONS, SEE S-SERIES DRAWINGS FOR MORE INFORMATION.
- 6. REMOVE EXISTING INFILL, WOOD SILL AND TRIM AT EXISTING OPENING IN WALL, PREP FOR INFILL.
- 7. REMOVE EXISTING WOOD CHAIR RAIL AT WALLS IN THEIR ENTIRETY, SALVAGE AND RETURN TO
- 8. CAREFULLY REMOVE EXISTING WOOD DOOR & FRAME IN ITS ENTIRETY. SALVAGE FOR RE-
- 9. SALVAGE EXISTING SURFACE MOUNTED LIGHT AT CEILING FOR REINSTALLATION, SEE E-SERIES DRAWINGS FOR MORE INFORMATION.
- 10. REMOVE PORTION OF LOAD-BEARING WALL (ASSUMED) AS REQUIRED FOR NEW OPENING, SHORE AS
- REQUIRED, SEE S-SERIES DWGS.

 TEMPORARILY REMOVE DOOR FROM HINGES AND STORE AWAY FROM WORK AREA, REINSTALL AT
- CONCLUSION OF WORK. PROTECT DOOR FRAME DURING CONSTRUCTION.

 12. REMOVE EXISTING WINDOW IN ITS ENTIRETY, REMOVE PORTION OF EXISTING BRICK WALL BELOW WINDOW TO EXISTING SECOND FINISHED ELOOP ELEVATION, PREP FOR NEW DOOR, MODIEY
- WINDOW TO EXISTING SECOND FINISHED FLOOR ELEVATION, PREP FOR NEW DOOR, MODIFY EXISTING LINTEL AS REQUIRED FOR NEW DOOR OPENING.
- 13. REMOVE PORTION OF LOAD-BEARING (ASSUMED) AS REQUIRED FOR NEW DOOR OPENING, SHORE AS REQUIRED, SEE S-SERIES DWGS.
- 14. REMOVE EXISTING METAL DOOR & FRAME IN ITS ENTIRETY.
- REMOVE EXISTING PLUMBING FIXTURES IN THEIR ENTIRETY, CAP PLUMBING AS REQUIRED, SEE P-SERIES DWGS.
- REMOVE SURFACE MOUNTED LIGHT AT CEILING ABOVE, SALVAGE FOR REINSTALLATION, SEE E-SERIES DWGS FOR MORE INFORMATION.
- 17. REMOVE EXISTING WINDOWS IN THEIR ENTIRETY, PREP FOR NEW WINDOW.
- 18. REMOVE PORTION OF EXISTING WOOD FLOOR STRUCTURE AS REQUIRED FOR NEW ELEVATOR, SHORE AS REQUIRED, SEE S-SERIES DWGS FOR DETAILS FOR RE-SUPPORTING FLOOR SURROUNDING OPENING.
- 19. EXISTING WOOD FLOOR TO BE PROTECTED DURING CONSTRUCTION.
- REMOVE EXISTING CARPET IN ITS ENTIRETY. NOTIFY ARCHITECT OF CONDITION OF EXISTING TILE INCLUDING AREAS OF DAMAGED OR MISSING TILE. IF ARCHITECT DECIDES THAT THE TILE IS ARE IN ACCEPTABLE CONDTION, CONTRACTOR TO CAREFULLY CLEAN ADHESIVE FROM THE EXISTING TILE. USE A MIXTURE OF WARM WATER, AMMONIA, AND A TEASPOON OF MILD DISH DETERGENT PER BUCKET OF WATER. SCRUB USING A NYLON OR NATURAL BRISTLE BRUSH. IF THIS MIXTURE IS INSUFFICIENT TO FULLY REMOVE ADHESIVE, COORDINATE WITH ARCHITECT. DO NOT USE A MORE ABRASIVE METHOD WITHOUT ARCHITECT'S APPROVAL. WHERE TILE IS MISSING OR DAMAGED, REPLACE WITH SALVAGED OR NEW MOSAIC TILE TO MATCH (INCLUDING GROUT COLOR). REPLACEMENT TILE CAN BE SOURCED FROM MULTIPLE MANUFACTURERS INCLUDING: AMERICAN RESTORATION TILE, MABELVALE, AR, PH: (501) 455-1000.
- 21. REMOVE PORTION OF EXISTING CONCRETE FLOOR STRUCTURE AS REQUIRED FOR NEW ELEVATOR, SHORE AS REQUIRED, SEE S-SERIES DWGS FOR DETAILS FOR RE-SUPPORTING FLOOR SURROUNDING OPENING.
- 22. REMOVE EXISTING NON-LOAD BEARING WALL AS SHOWN. PATCH AND REPAIR EXISTING WALL AND ADJACENT FINISHES TO REMAIN (MATCH EXISTING).
- 23. CAREFULLY REMOVE WOOD DOOR & FRAME IN ITS ENTIRETY, SALVAGE AND RETURN TO OWNER.
- 24. REMOVE EXISTING EXTENSION AT BASE OF DOWNSPOUT.
- 25. EXISTING ELECTRIC METER TO REMAIN.
- 26. REMOVE EXISTING WINDOW & CONCRETE WINDOW WELL AT BASEMENT LEVEL (GROUND FLOOR LEVEL WINDOW TO REMAIN).
- 27. REMOVE EXISTING CONCRETE CURB AND ROCK BED, SALVAGE ROCKS FOR REINSTALLATION.
- 28. REMOVE PORTION OF EXISTING ASPHALT PARKING AREA AS REQUIRED FOR NEW EXTERIOR STAIR.
- 29. EXISTING GAS METER TO REMAIN.
- 30. EXISTING ROOF TO BASEMENT ENTRY BELOW.
- 1. EXISTING TILE FLOOR TO REMAIN.
- 32. EXISTING CARPET TO REMAIN.

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FLYNN | BATTAGLIA

617 Main Street, Suite 401 Buffalo, New York 14203 Telephone (716) 854-2424

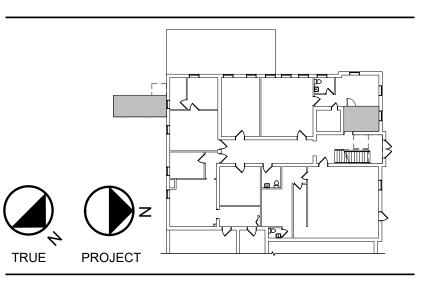

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245 Kinsey Ave Kenmore, New York 14217 Telephone (716) 854-3508



598 Lafayette Ave Buffalo, New York 14222 Telephone (716) 381-9389

PERRY VILLAGE HALL ADA IMPROVEMENTS

VILLAGE OF PERRY 46 N. MAIN ST. PERRY, NY 14530

100% CONSTRUCTION
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NOTES & REVISIONS:

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Revision Schedule

Revision Number Date Description

DRAWING ISSUED:

Project Number:

00370

Drawn By:

MB

Checked By:


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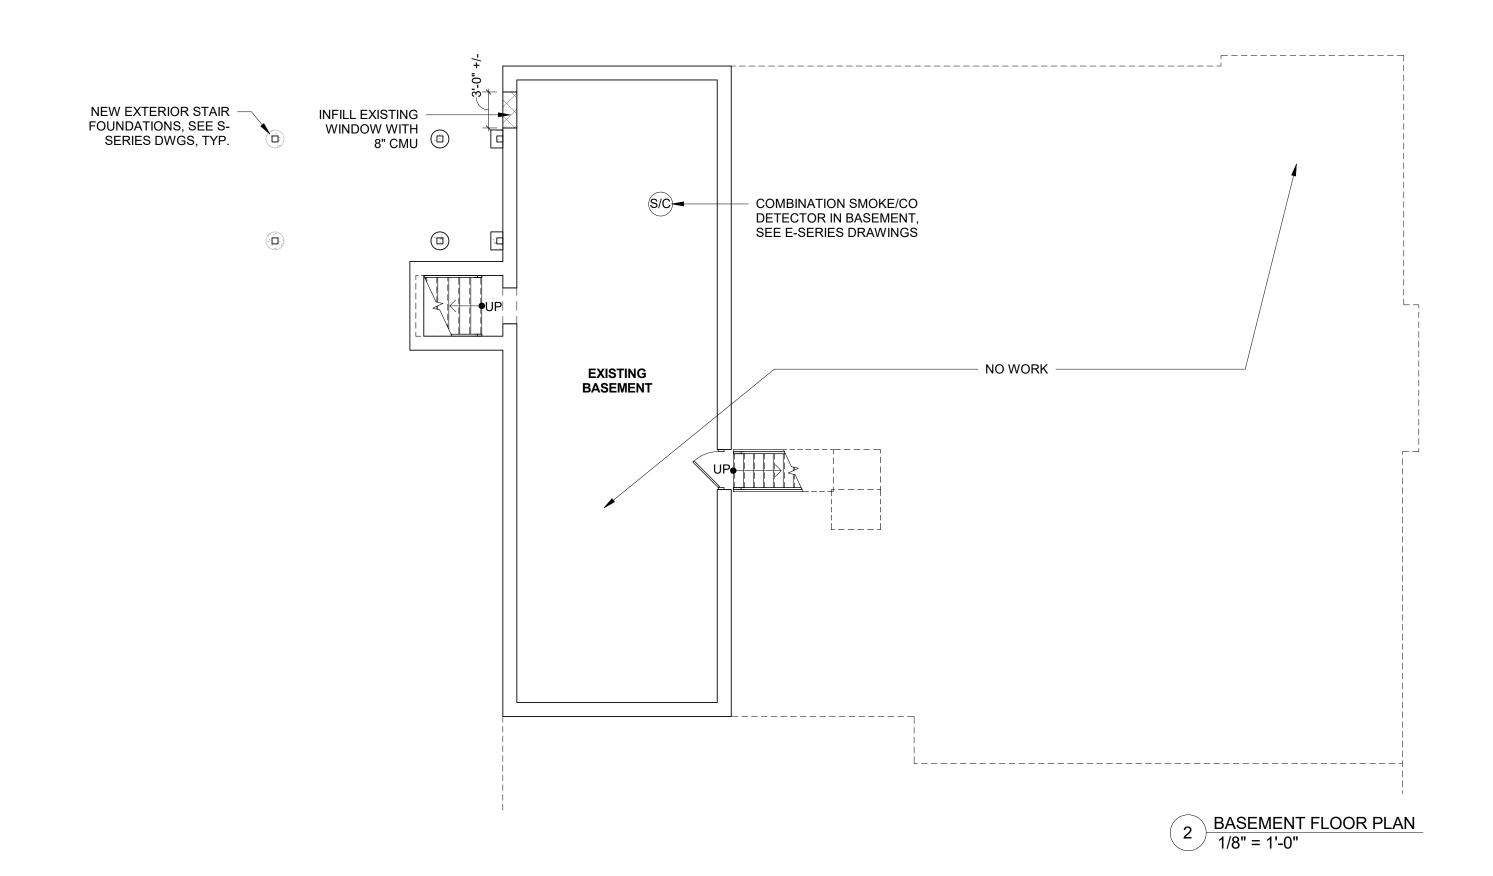
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DEMOLITION PLANS

Drawing Number

AD-02



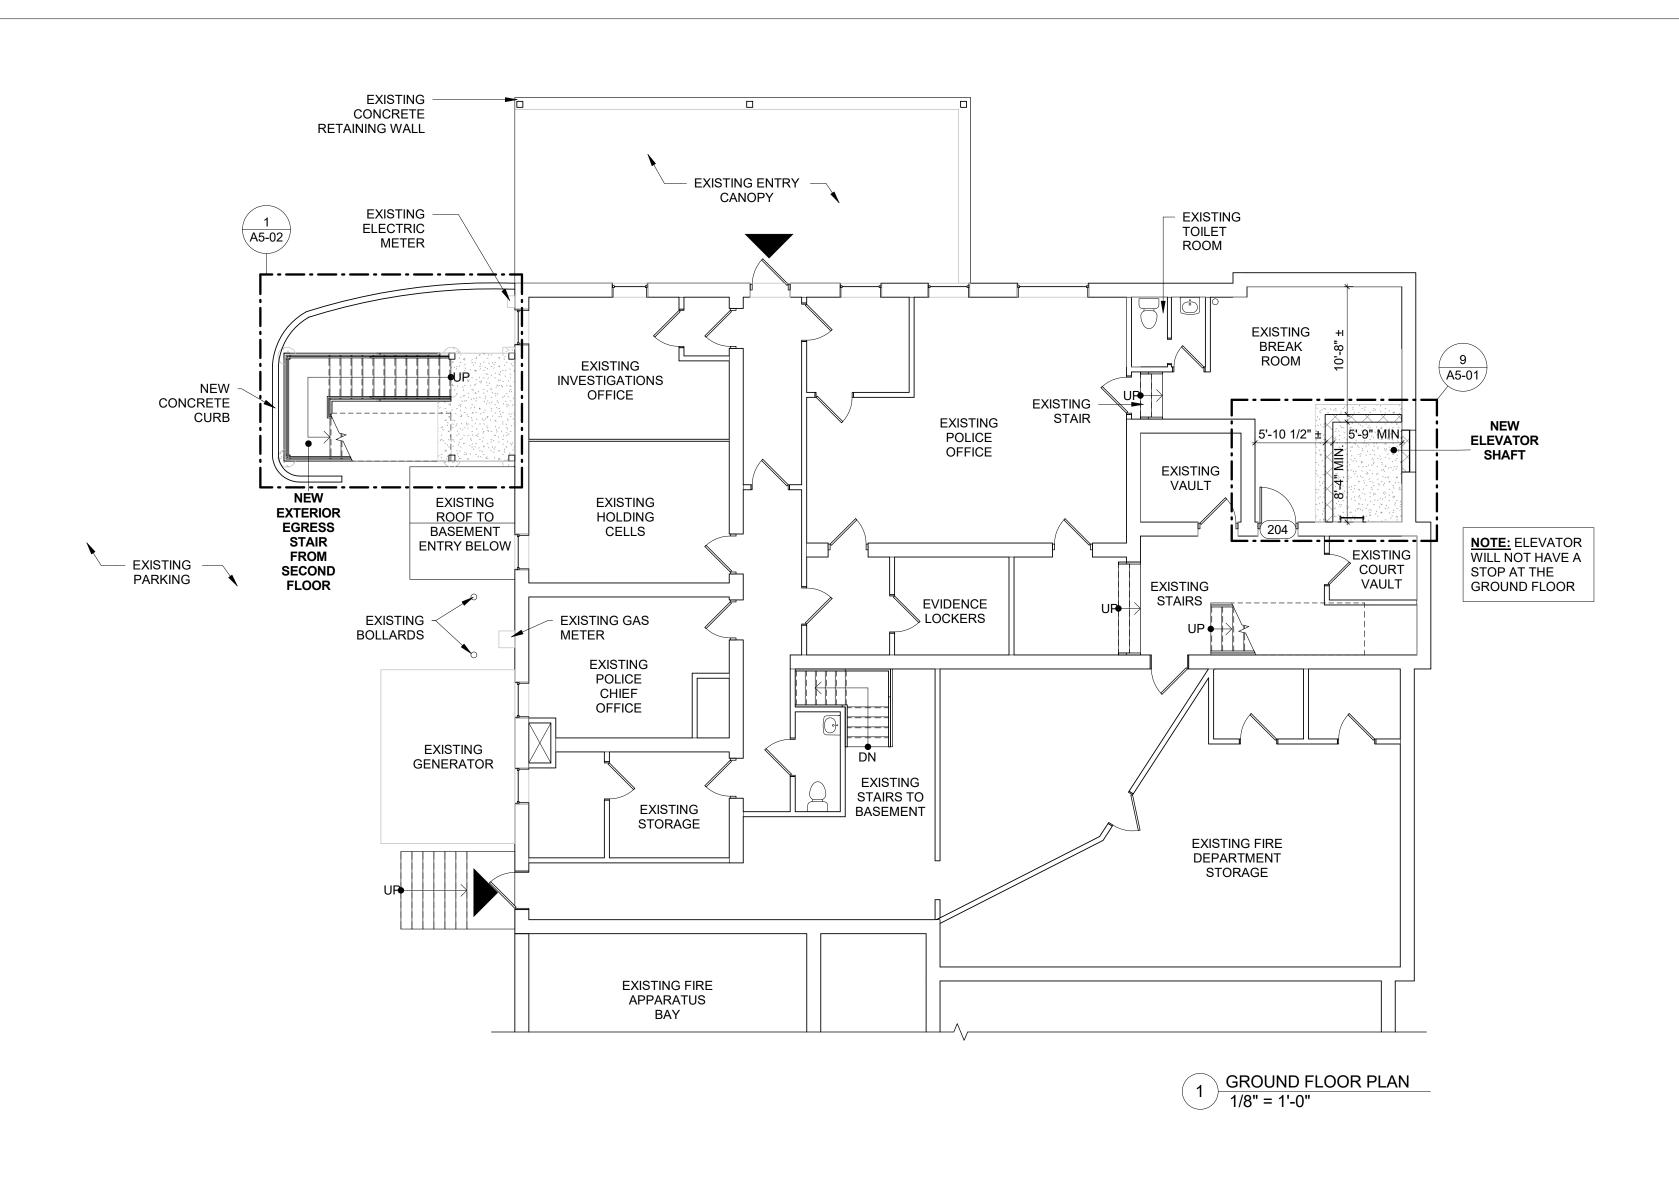


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- F. FURNITURE IS N.I.C.
- SEE SPECS FOR FIXTURE AND MATERIAL INFORMATION.
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ALTERNATE NOTES:

ALTERNATE #1: THE NEW ELEVATOR LOBBY IS TO BE REDUCED IN SIZE, SEE SHEET A5-01 FOR DETAILS.

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FLYNN | BATTAGLIA

617 Main Street, Suite 401 Buffalo, New York 14203 Telephone (716) 854-2424

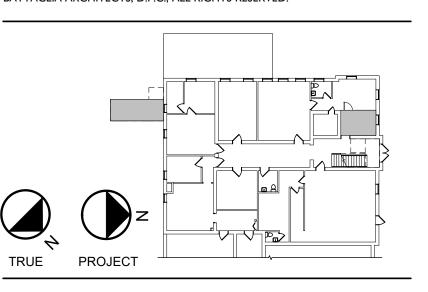

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245 Kinsey Ave Kenmore, New York 14217 Telephone (716) 854-3508



P.MAX ENGINEERING, P.C.

598 Lafayette Ave Buffalo, New York 14222 Telephone (716) 381-9389

PERRY VILLAGE HALL ADA IMPROVEMENTS

VILLAGE OF PERRY 46 N. MAIN ST. **PERRY, NY 14530**

100% CONSTRUCTION **DOCUMENT BID SET**

NOTES & REVISIONS:

Revision Schedule Revision Number


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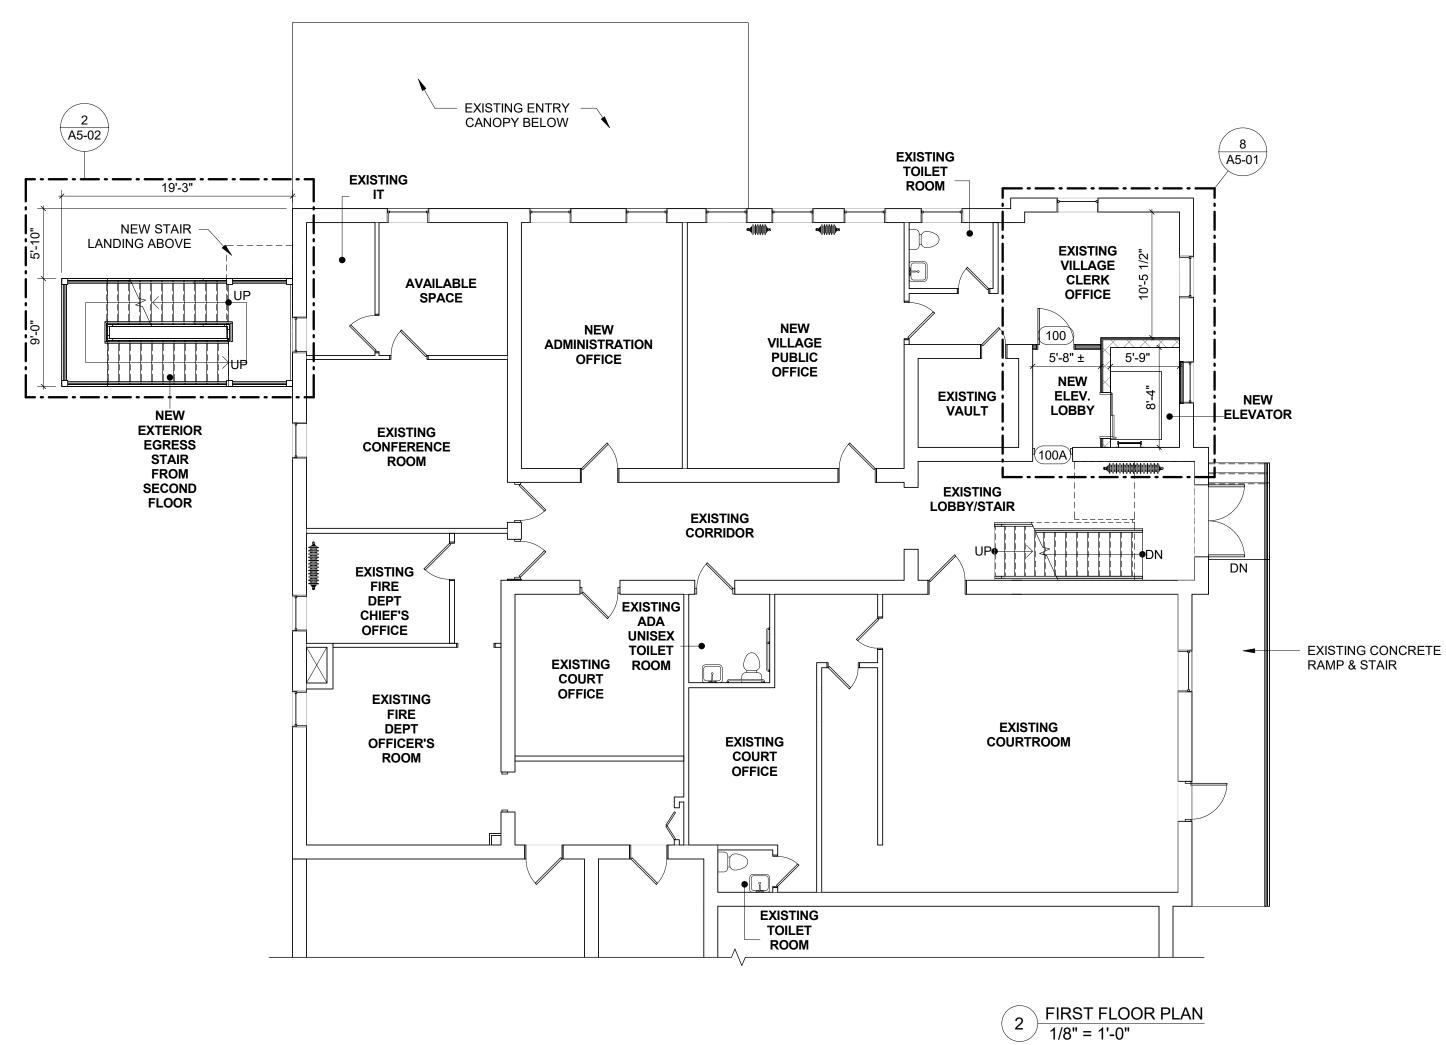
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BASEMENT AND GROUND FLOOR **PLANS**

Drawing Number

A1-01



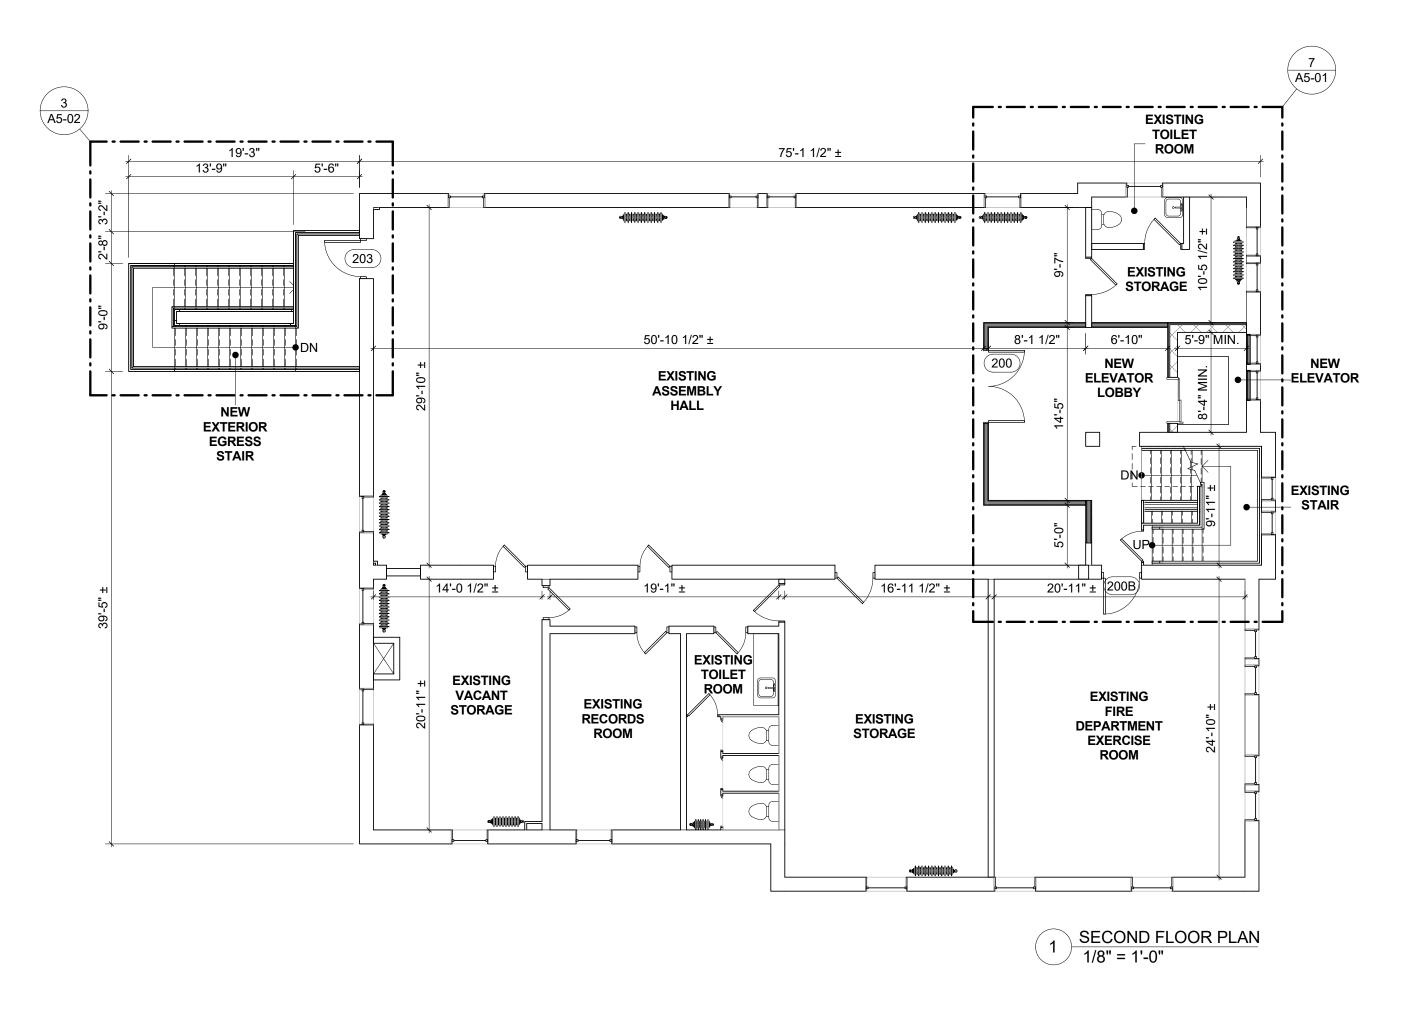


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FLYNN | BATTAGLIA

617 Main Street, Suite 401 Buffalo, New York 14203 Telephone (716) 854-2424



PETRILLI STRUCTURAL & CONSULTING ENGINEERING, P.C.

245 Kinsey Ave Kenmore, New York 14217 Telephone (716) 854-3508

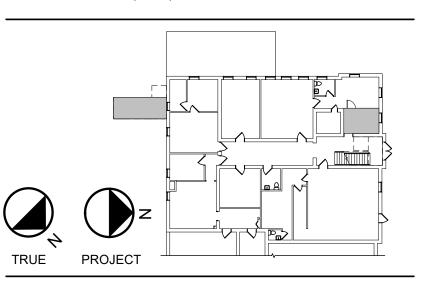

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VILLAGE OF PERRY 46 N. MAIN ST. **PERRY, NY 14530**

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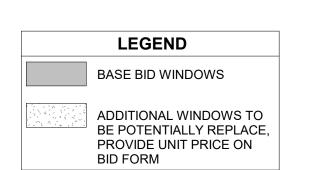
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FIRST AND SECOND FLOOR **PLANS**

Drawing Number

A1-02








3 NORTH ELEVATION 1/8" = 1'-0"

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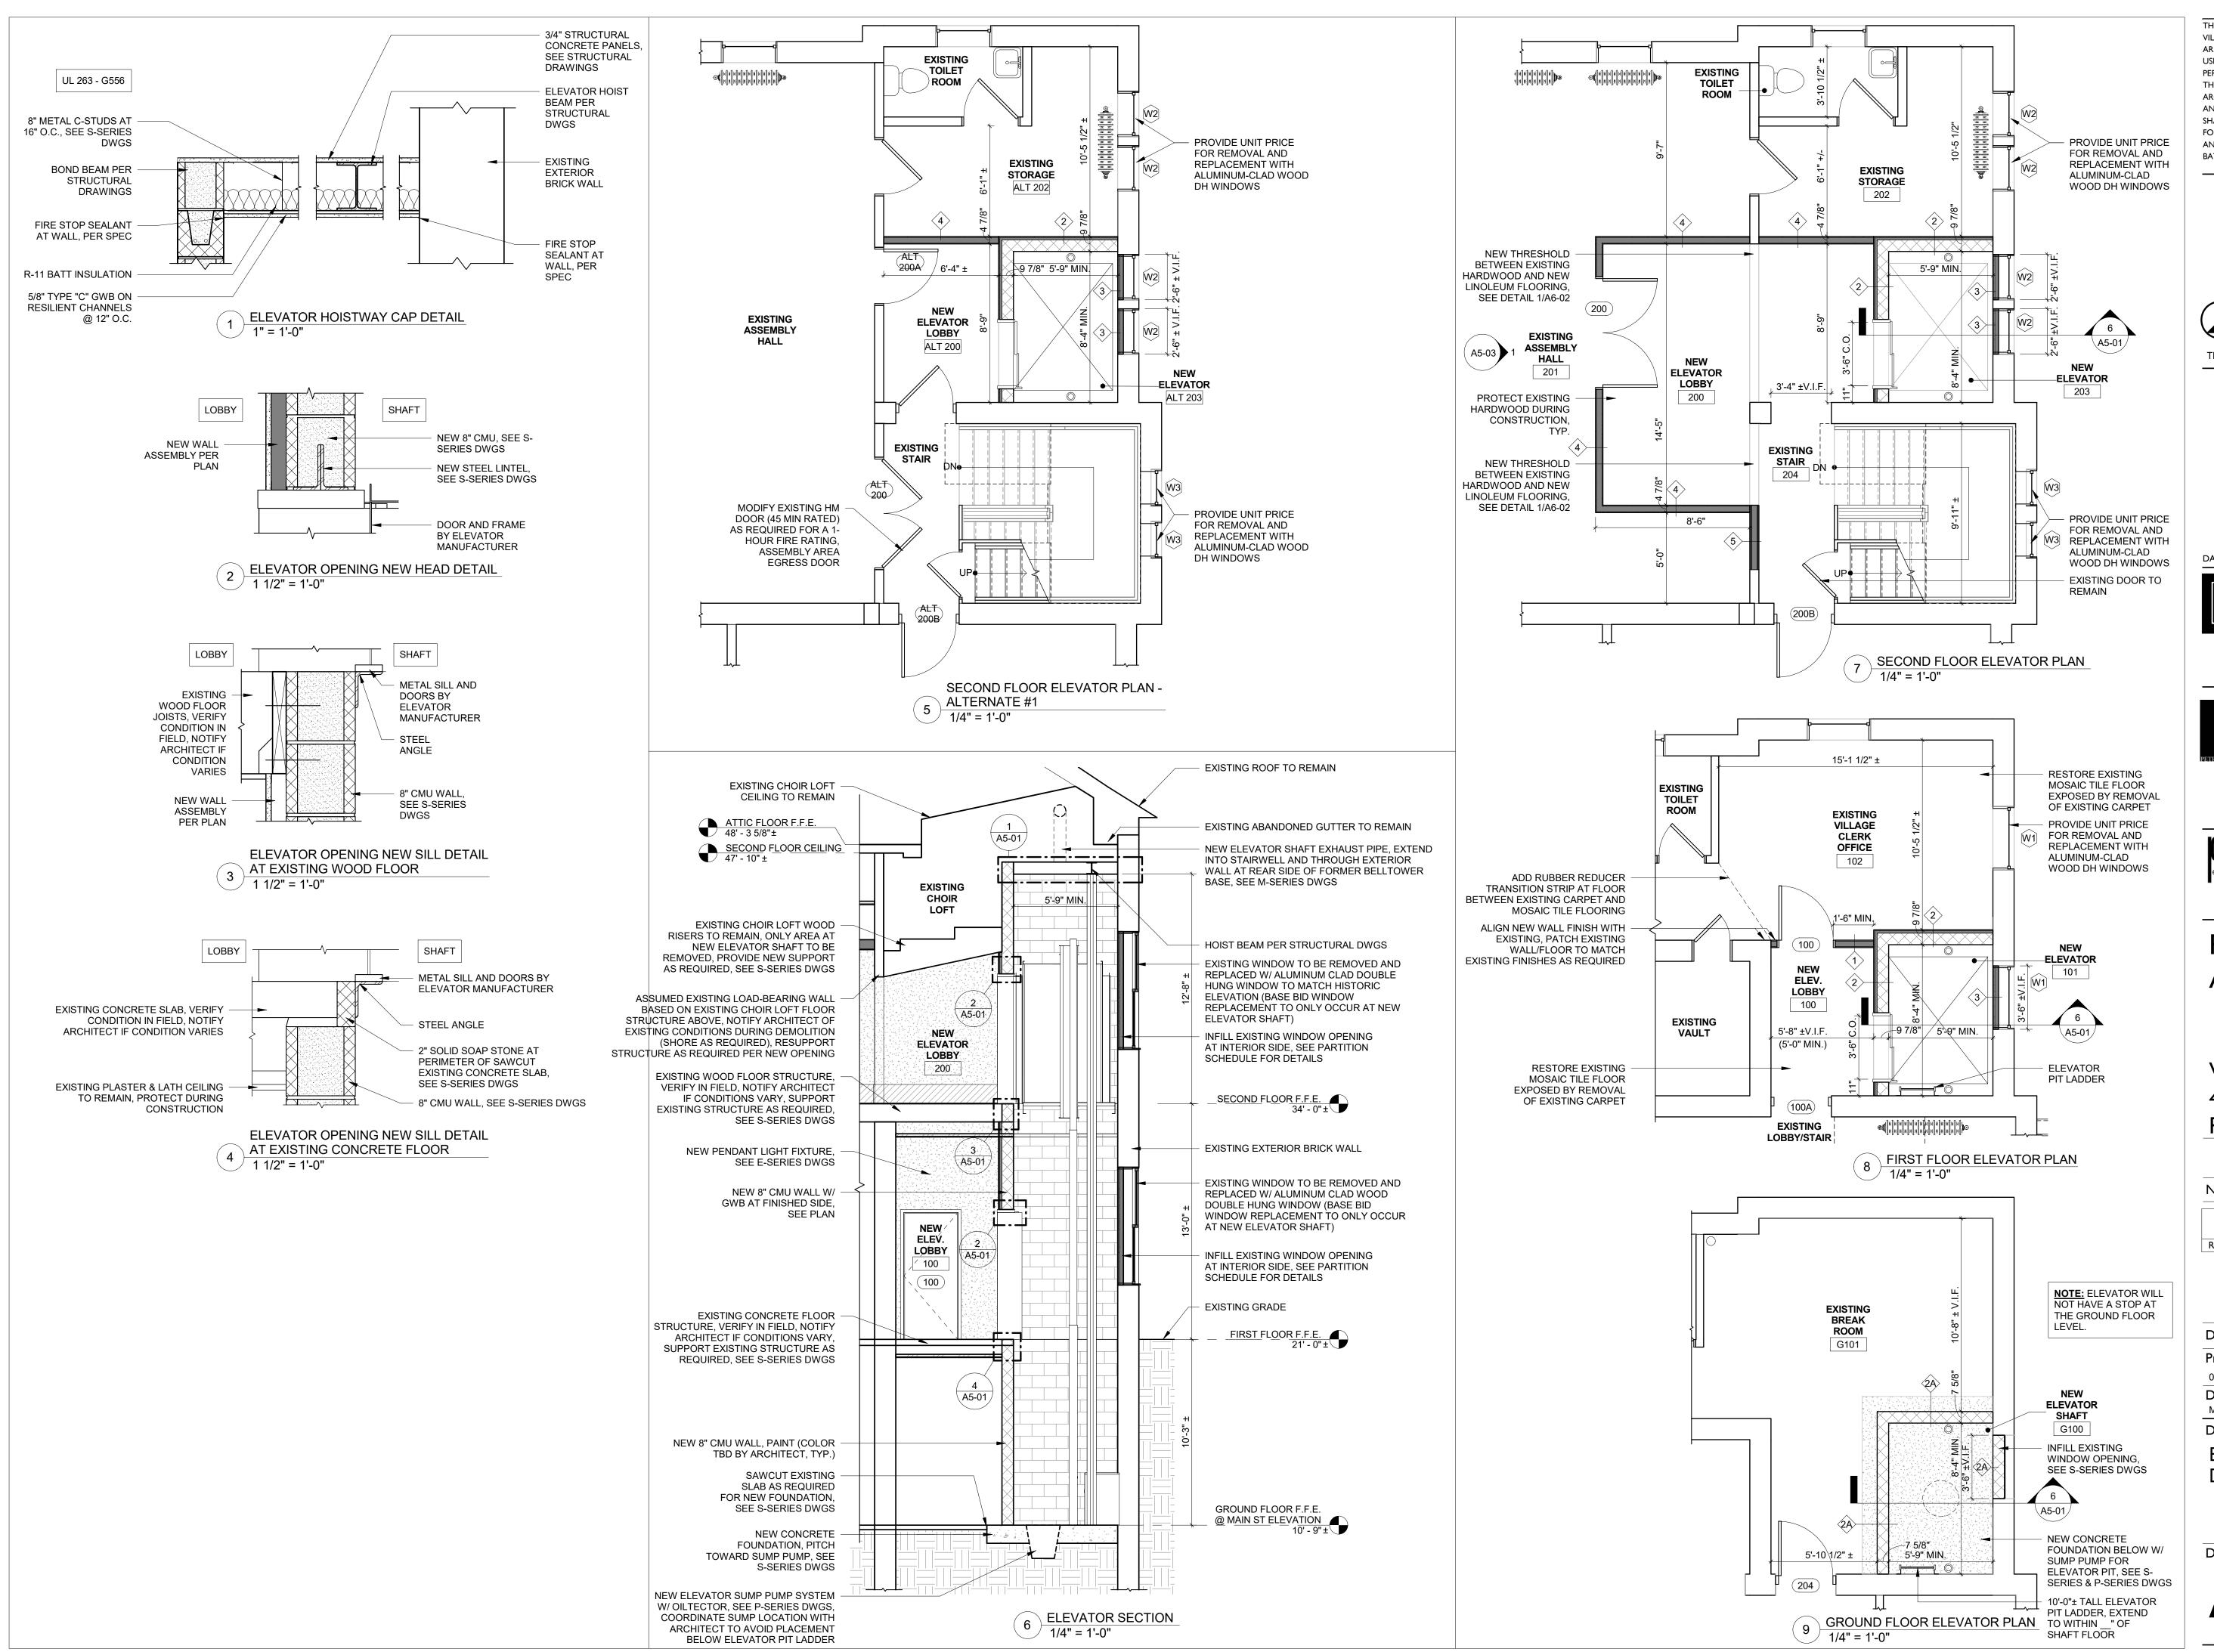
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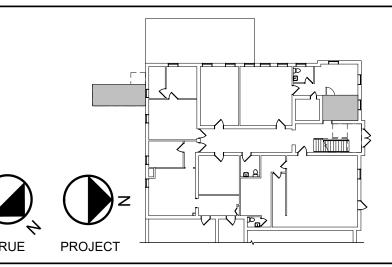
Drawing Title

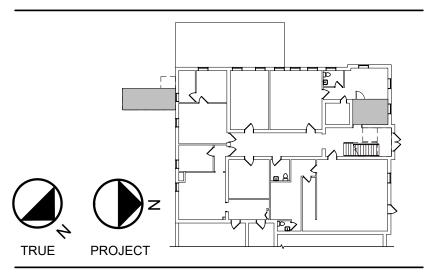ELEVATIONS

Drawing Number

A2-01





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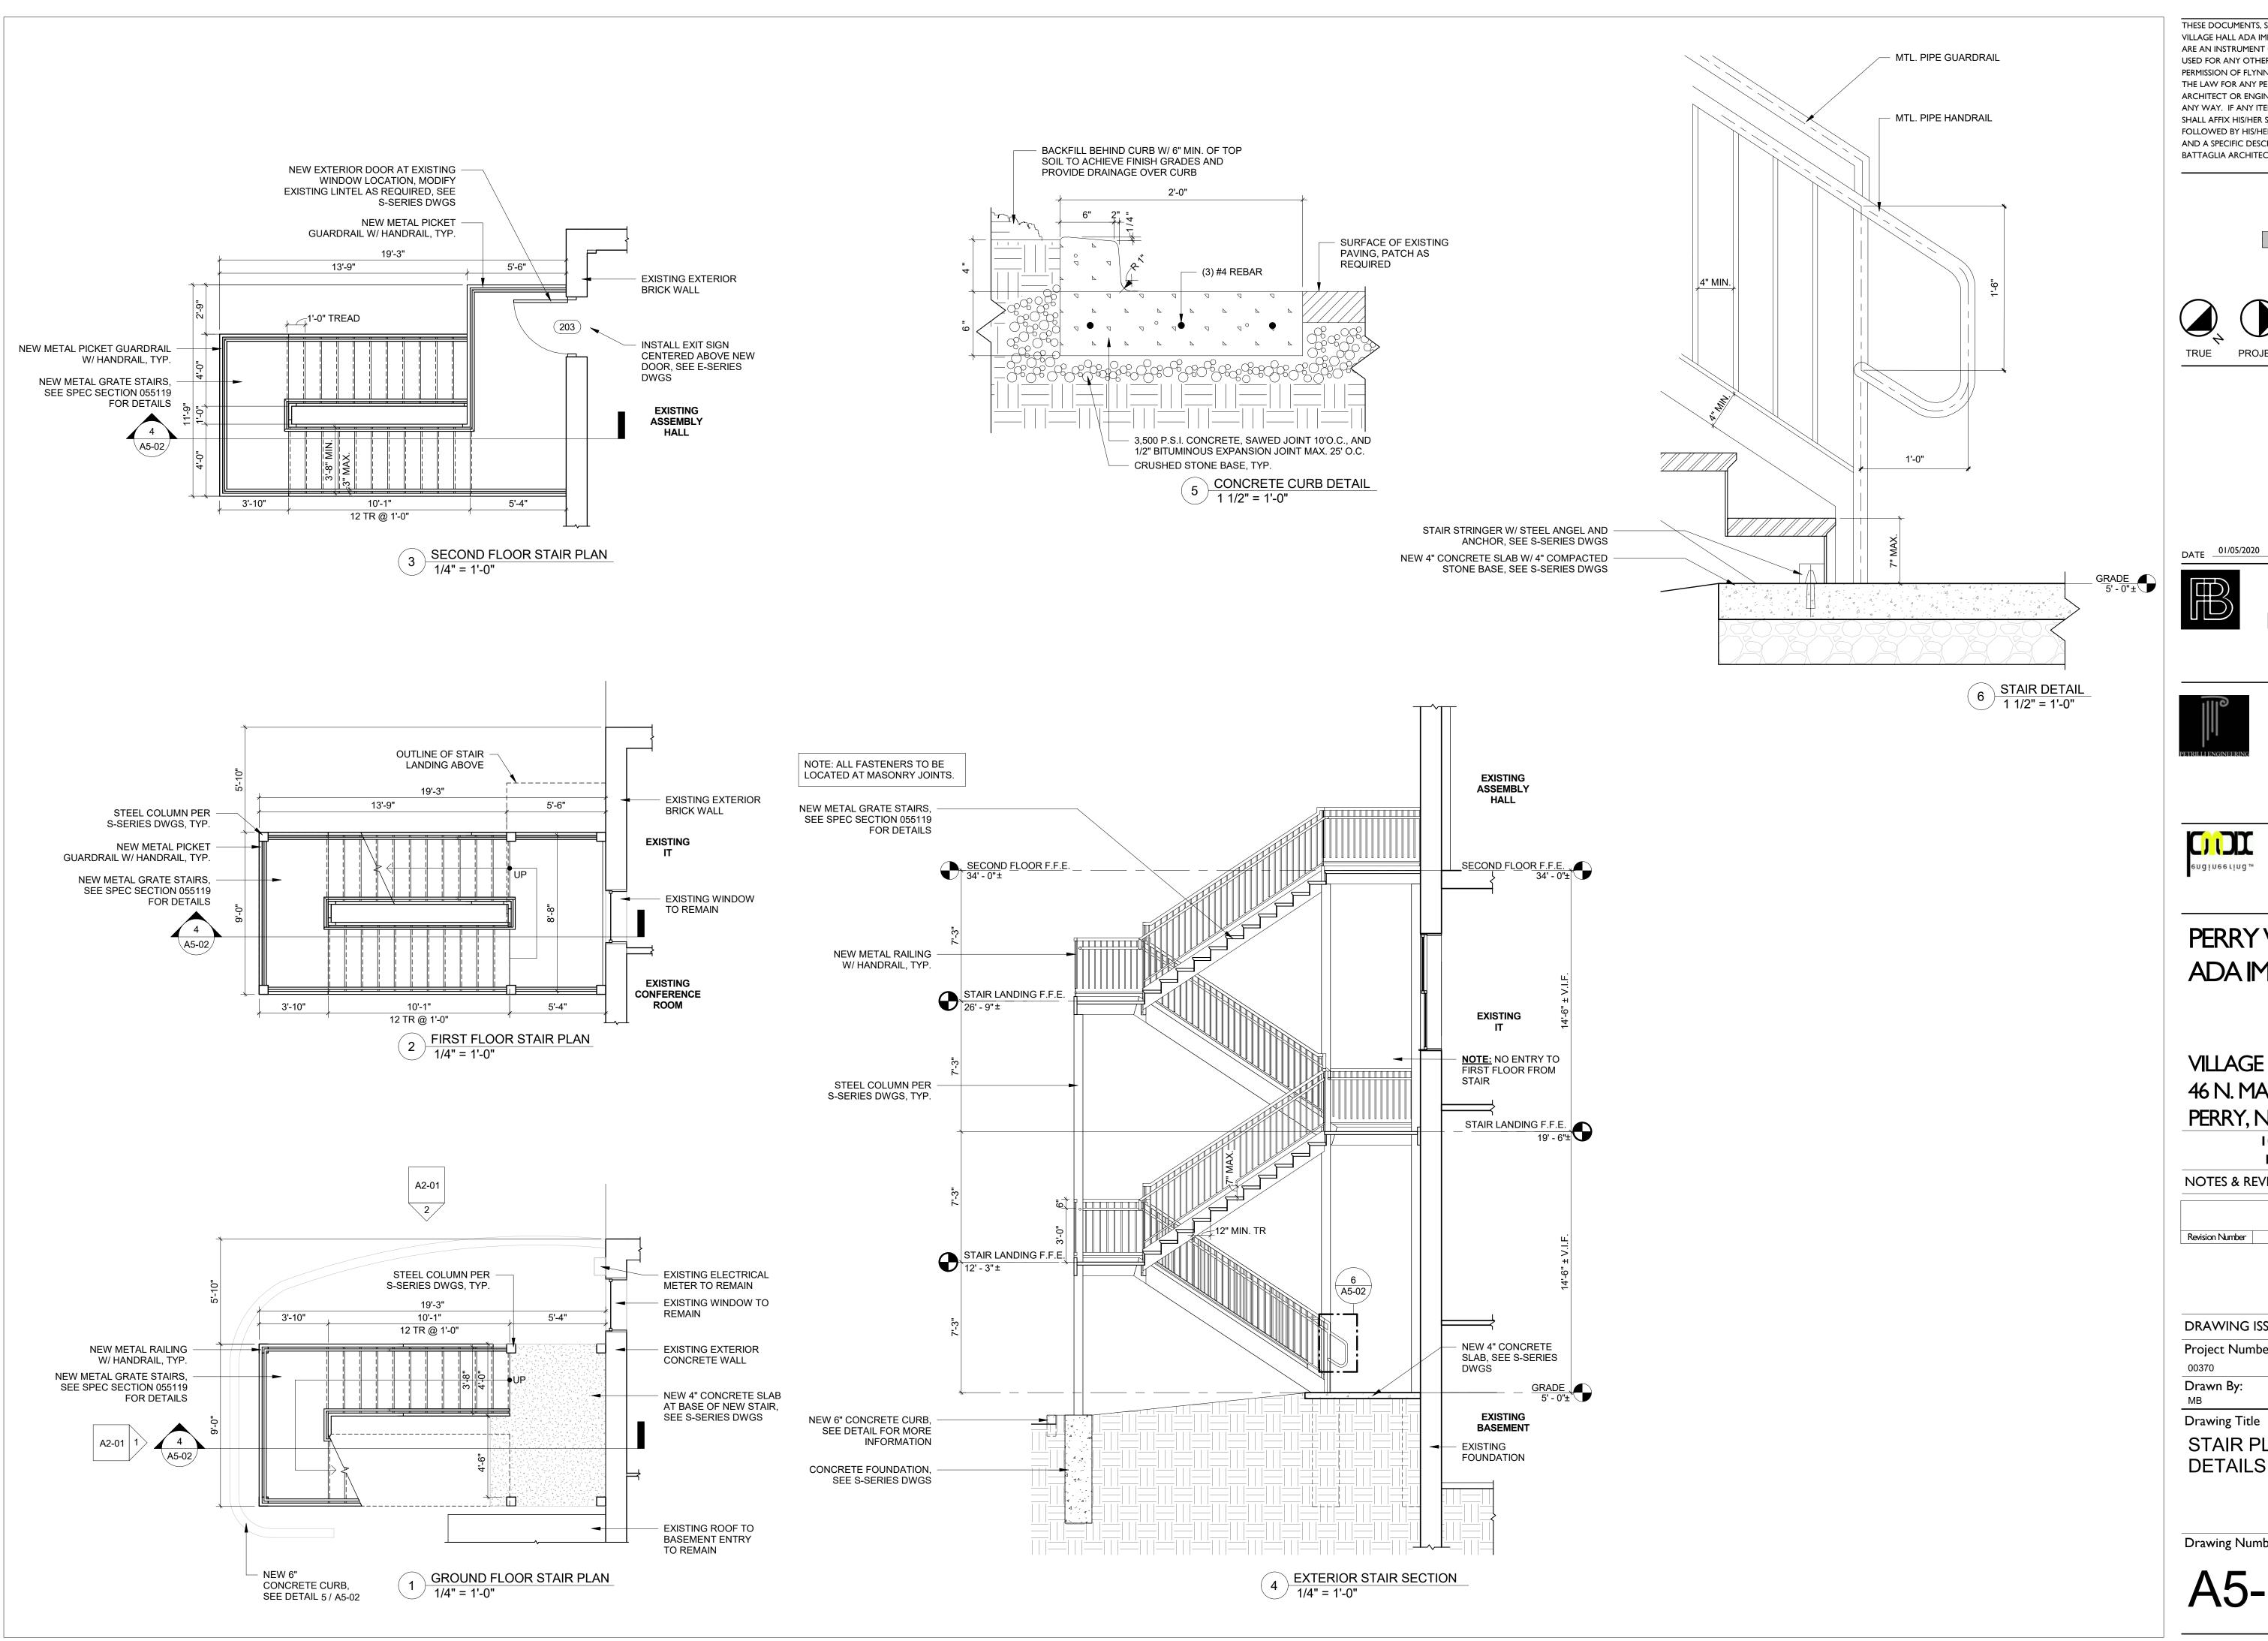
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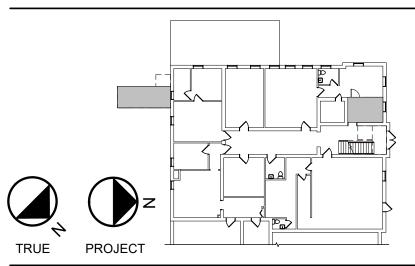
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Drawing Title

ELEVATOR PLANS, SECTION & DETAILS

Drawing Number





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Revision Schedule Revision Number


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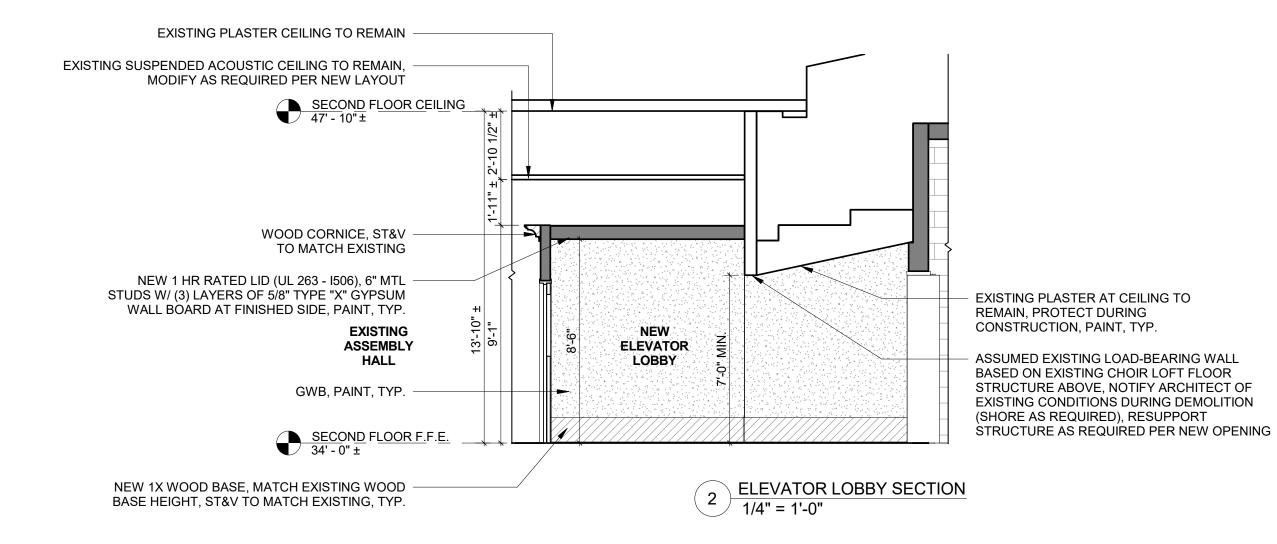
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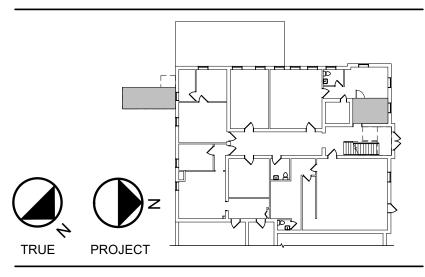
STAIR PLANS, SECTION & **DETAILS**

Drawing Number

A5-02





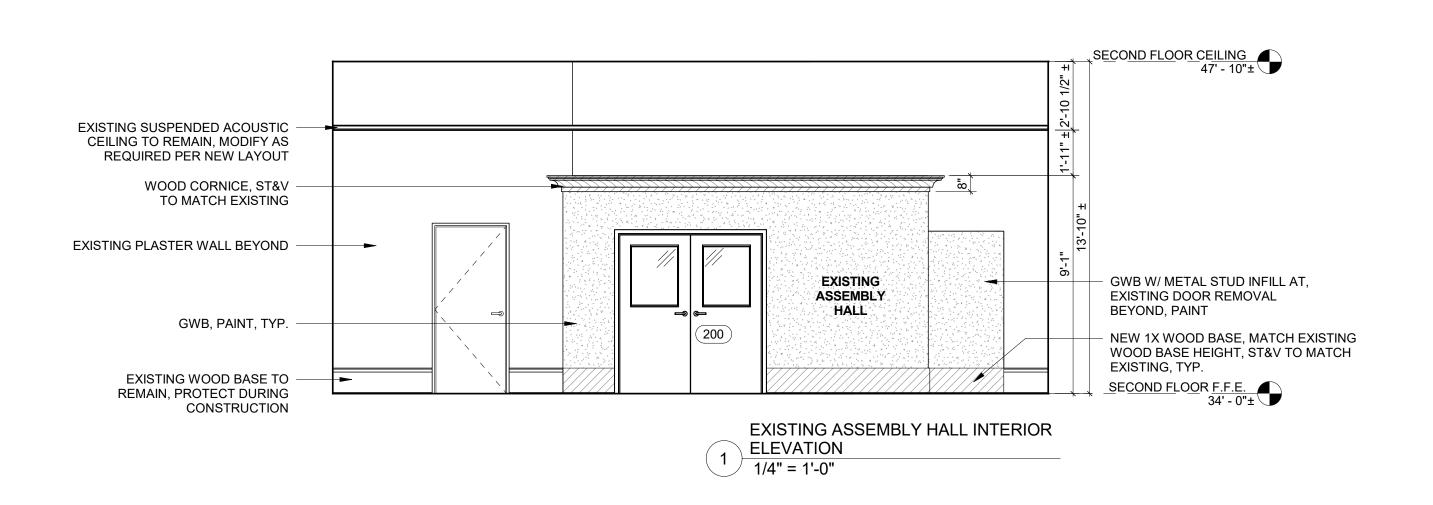

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FLYNN BATTAGLIA

617 Main Street, Suite 401 Buffalo, New York 14203 Telephone (716) 854-2424



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245 Kinsey Ave Kenmore, New York 14217 Telephone (716) 854-3508



P.MAX ENGINEERING, P.C.

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PERRY VILLAGE HALL ADA IMPROVEMENTS

VILLAGE OF PERRY 46 N. MAIN ST. **PERRY, NY 14530**

> 100% CONSTRUCTION **DOCUMENT BID SET**

NOTES & REVISIONS:

Revision Schedule								
Revision Number Date Description								

DRAWING ISSUED:	APRIL 5, 2021
Project Number:	Scale: 1/4" = 1'-0"
Drawn By:	Checked By:


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INTERIOR ELEVATIONS


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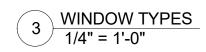
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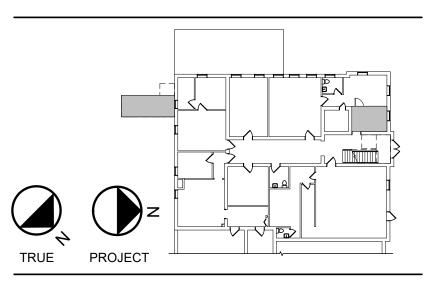




WINDOW SCHEDULE								
Type Mark	Size W x H	Material	Section #	Remarks	Sill Height			
W1	3'-6" X 6'-6"± VI.F.	ALUM-CLAD		EXISTING TRANSOM WINDOW ABOVE TO REMAIN, PROTECT DURING CONSTRUCTION	3'-0"± V.I.F.			
W2	2'-6" X 6'-6"± V.I.F.	ALUM-CLAD			3'-0"± V.I.F.			
W3	2'-0" X 4'-6"± V.I.F.	ALUM-CLAD			3'-0"± V.I.F.			
W4	1'-10" X 4'-0"± V.I.F.	ALUM-CLAD			V.I.F.			



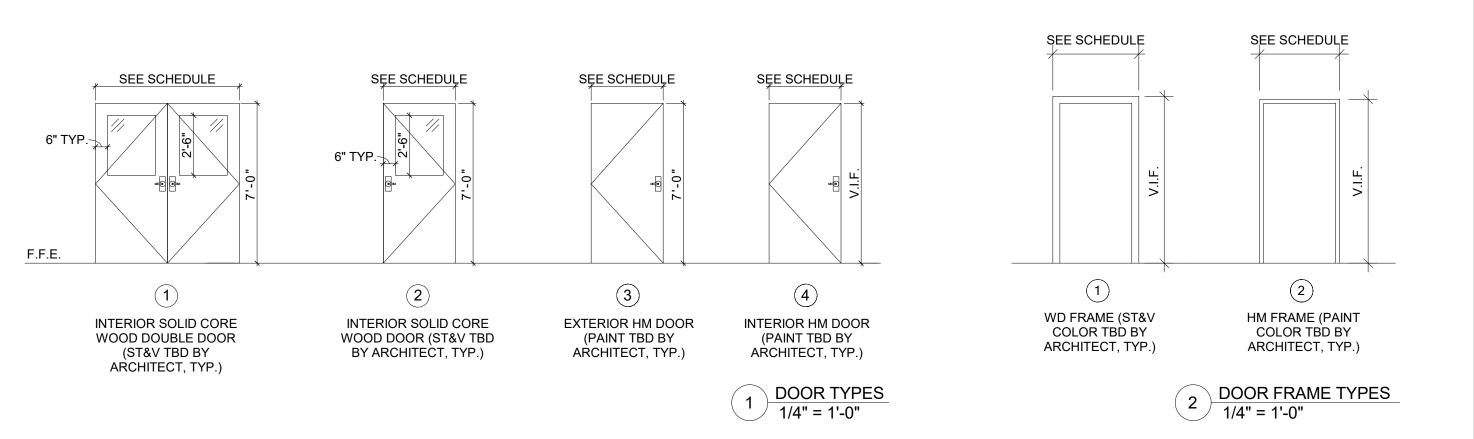

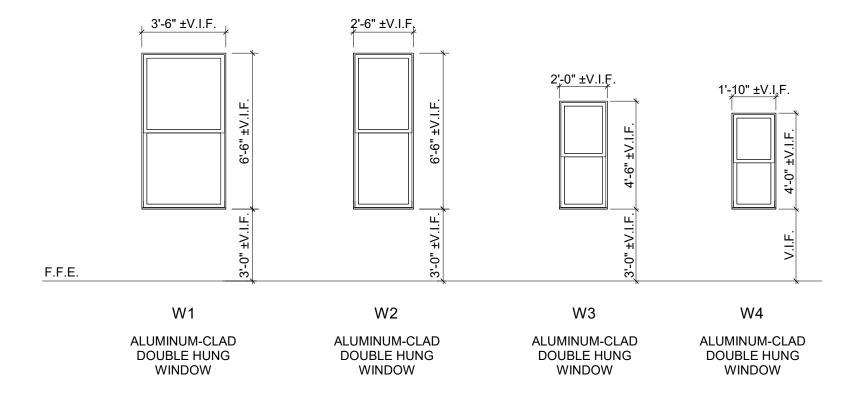

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598 Lafayette Ave Buffalo, New York 14222 Telephone (716) 381-9389

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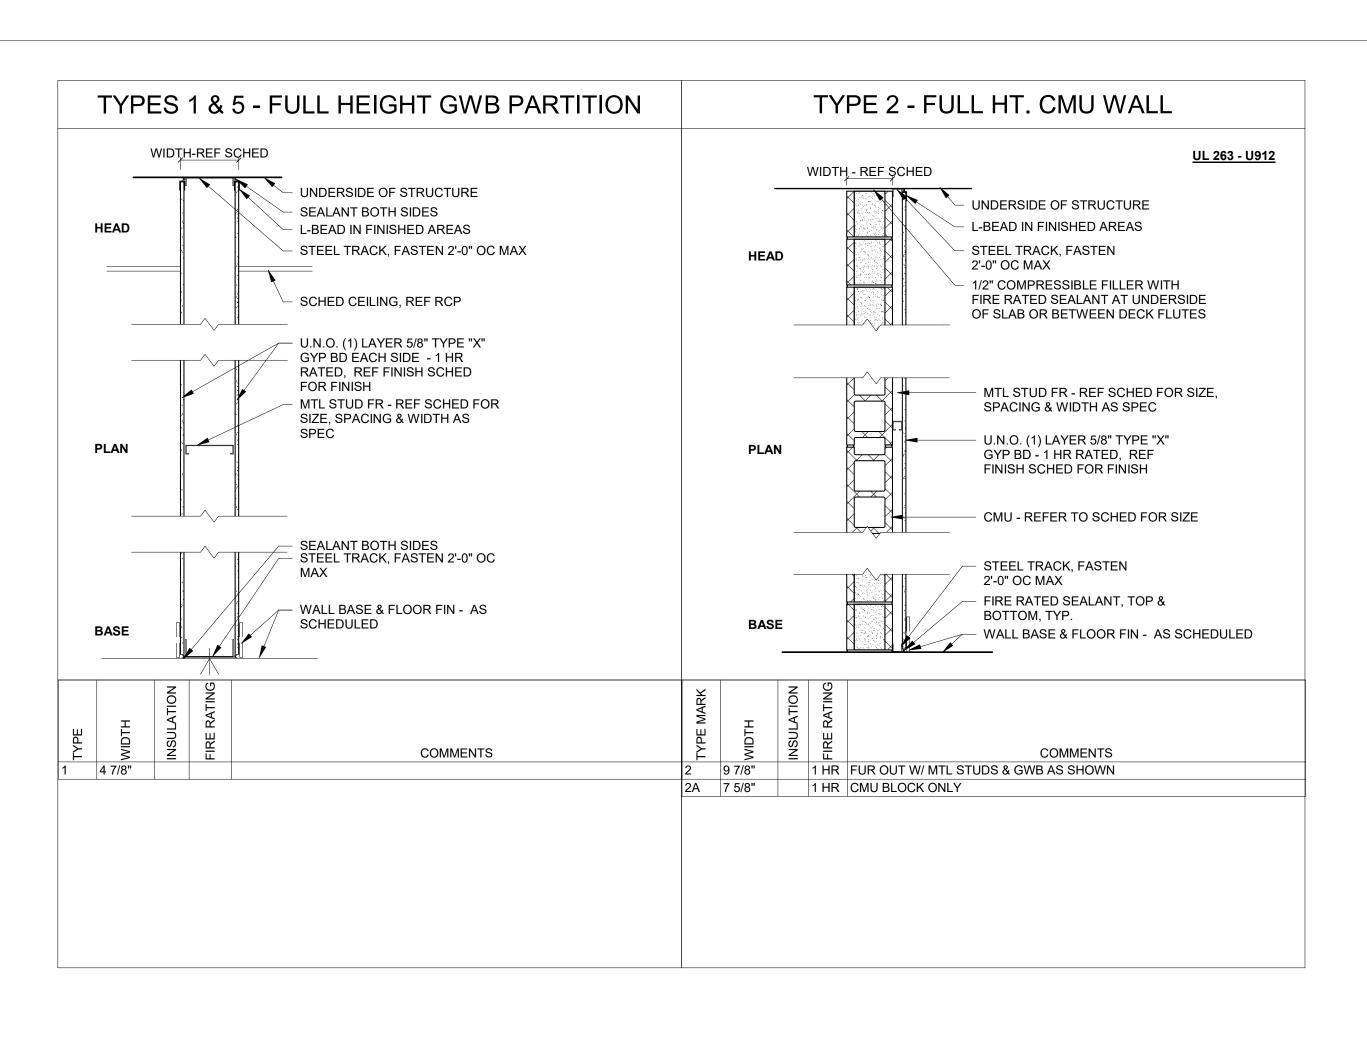
DRAWING ISSUED: APRIL 5, 2021 Project Number: Scale: Drawn By: Checked By: MM, LM

Drawing Title

WINDOW & DOOR SCHEDULES, TYPES & DETAILS

Drawing Number

A6-01



		TYPE 3 - SINGLE SIDED PARTITION		TYF	PES 4 & 5 - 1 HR RATED GWB PARTITION
		WIDTH-REF SCHED			<u>UL 263 - U423</u>
	HEAD	FIRE RATED SEALANT BOTH SIDES L-BEAD IN FINISHED AREAS STEEL TRACK, FASTEN 2'-0" OC MAX	ı	HEAD	UNDERSIDE OF STRUCTURE FIRE RATED SEALANT BOTH SIDES L-BEAD IN FINISHED AREAS STEEL TRACK, FASTEN 2'-0" OC MAX
	PLAN	U.N.O. (2) LAYERS 5/8" GYP BD ONE SIDE, REF FIN SCHED FOR FIN MTL STUD FR - REF SCHED FOR SIZE, SPACING & WIDTH AS SPEC STEEL TRACK, FASTEN 2'-0" OC MAX FIRE RATED SEALANT BOTH SIDES		PLAN — —	U.N.O. (1) LAYER 5/8" TYPE "X" GYP BD EACH SIDE - 1 HR RATED, REF FINISH SCHED FOR FINISH MTL STUD FR - REF SCHED FOR SIZE, SPACING & WIDTH AS SPEC SOUND BATT INSUL @ NON- RATED PARTITIONS. BATT INSULATION PER UL DESIGN NUMBER FIRE RATED SEALANT BOTH SIDES STEEL TRACK, FASTEN 2'-0" OC MAX WALL BASE & FLOOR FIN - AS SCHEDULED
3 TYPE	H □ ≫ 3 3/4"	NSULATION FIRE RATING COMMENTS	3d\L 4	H	VOILE STORATING 45 COMMENTS Yes 1 HR MIN. STC RATING 45
			5	6"	NO LE VENTA DE LA VENTA DEL VENTA DE LA VENTA DE LA VENTA DEL VENTA DE LA VENTA DEL VENTA DE LA VENTA DEL VENTA DE LA VENTA DE LA VENTA DE LA VENTA DE LA VENTA DEL VENTA DE LA VENTA DEL VENTA DEL VENTA DEL VENTA DEL VENTA DE LA VENTA DE LA VENTA DE LA VENTA DEL VENTA DE LA VENTA DEL VENTA DELA


ROOM FINISH SCHEDULE								
NUMBER	ROOM	FLOOR	BASE	WALL	CEILING	Comments		
G101	EXISTING BREAK ROOM	EXISTING CONCRETE						
00	NEW ELEV. LOBBY	EXISTING TILE	WD	EXISTING/PNT-1	EXISTING/PNT-2			
02	EXISTING VILLAGE CLERK OFFICE	EXISTING TILE	EXIST. WD	GWB/PNT-1	EXISTING/PNT-2	3		
.00	NEW ELEVATOR LOBBY	LINO-1	WD	PNT-1	PNT-2			
00A	NEW COAT CLOSET	EXIST. HARDWOOD	WD	GWB/PNT-1	GWB/PNT-2			
:01	EXISTING ASSEMBLY HALL	EXISTING HARDWOOD	EXIST. WD	GWB/PNT-1	EXISTING			
02	EXISTING STORAGE	EXISTING CONCRETE	RB-1	GWB/PNT-1	EXISTING	1		
204	EXISTING STAIR	LINO-1	WD	EXISTING/PNT-1	EXISTING/PNT-2	2		

ROOM FINISH SCHEDULE NOTES:


1. NEW GYPSUM WALL BOARD AT NEW WALL ADJACENT TO ELEVATOR SHAFT ONLY. PAINT ALL WALLS AND CEILING.

2. PAINT WALLS AND CEILING SURROUNDING TOP LANDING ONLY 3. RESTORE EXISTING MOSAIC TILE EXPOSED BY CARPET REMOVAL, SEE SPECIFIC NOTE #20/AD-02

	ROOM FINISH KEY
LINO-1	LINOLEUM FLOORING (SEE SPEC)
WD	WOOD
GWB/PNT	GYPSUM WALL BOARD PAINTED (SEE SPEC
PNT	PAINT
RB-1	RUBBER BASE

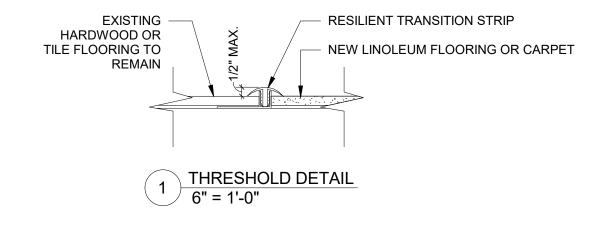

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245 Kinsey Ave Kenmore, New York 14217 Telephone (716) 854-3508

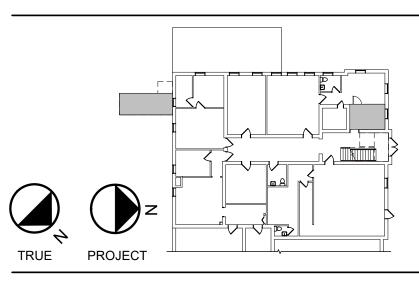

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VILLAGE OF PERRY 46 N. MAIN ST. **PERRY, NY 14530**

> 100% CONSTRUCTION **DOCUMENT BID SET**

NOTES & REVISIONS:

Revision Schedule Revision Number


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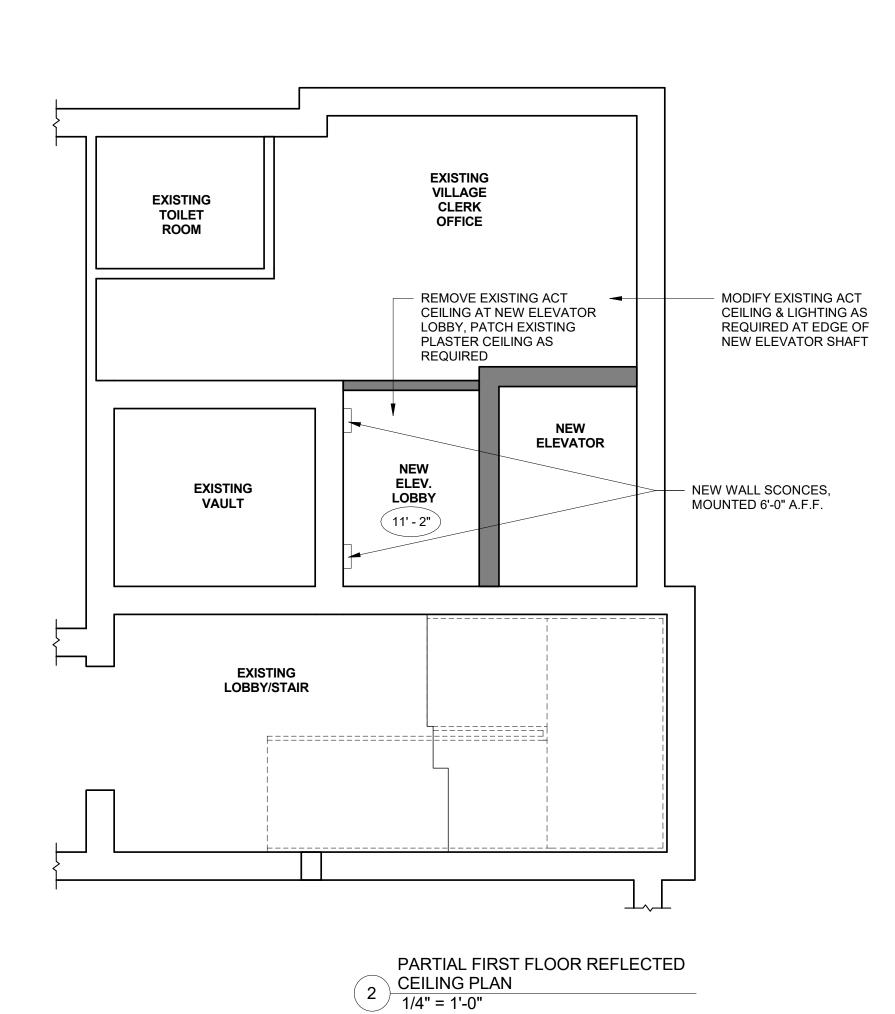
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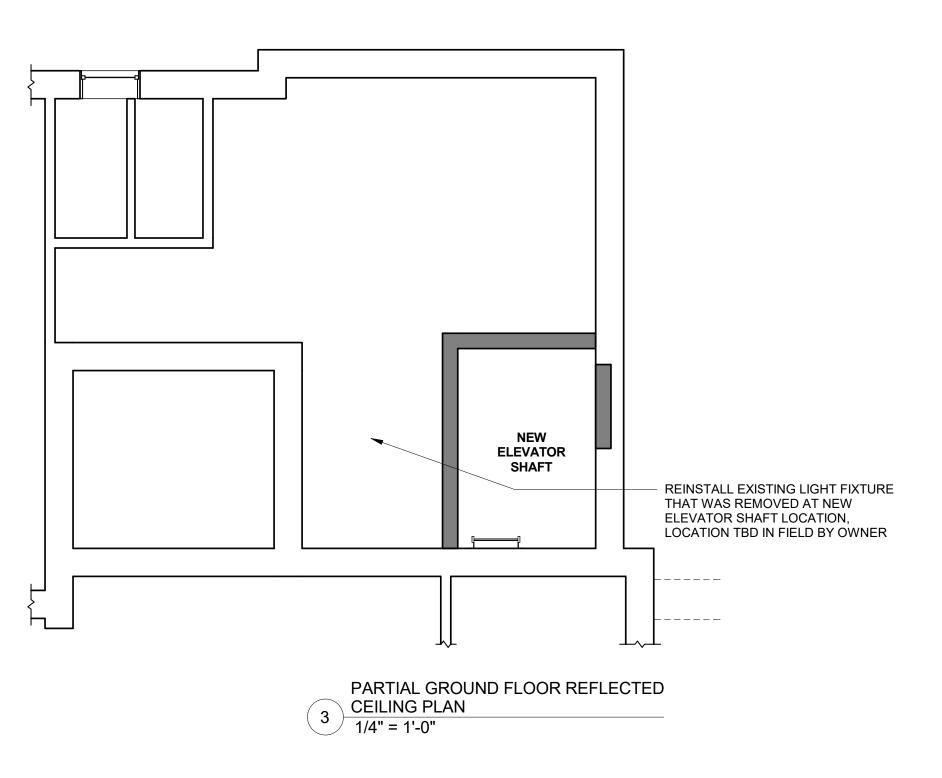
PARTITION & FINISH SCHEDULES

Drawing Number

A6-02





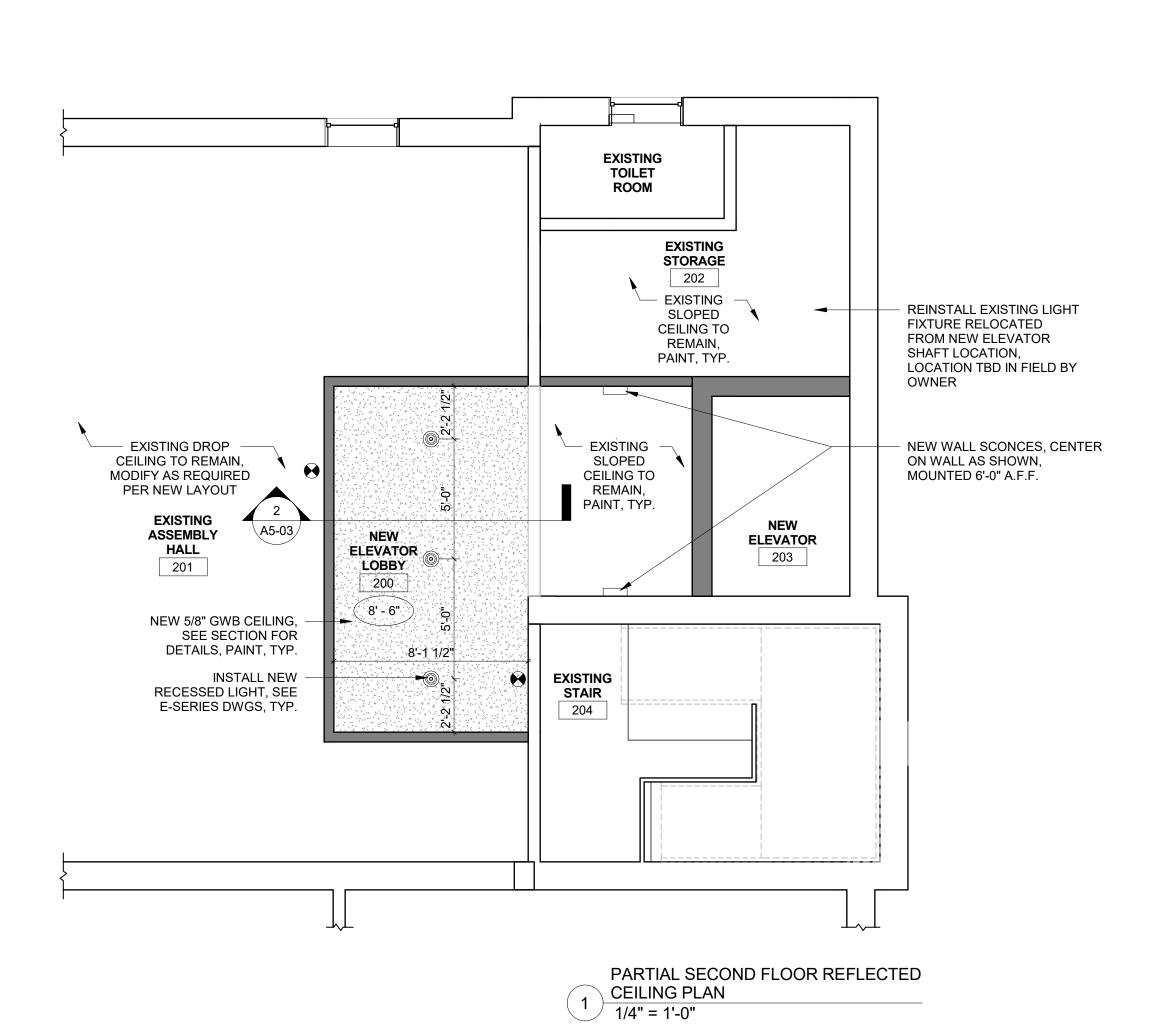

LEGEND:

CEILING EXHAUST FAN


EXIT LIGHT

EMERGENCY LIGHTING WALL PACK

NEW CEILING

FIRE ALARM W/ STROBE LIGHT

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245 Kinsey Ave Kenmore, New York 14217 Telephone (716) 854-3508

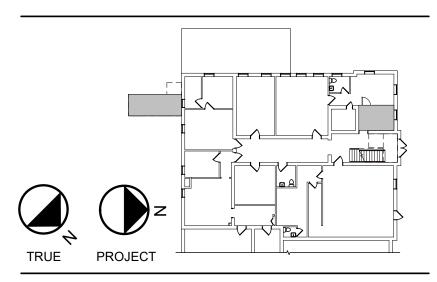

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PERRY VILLAGE HALL ADA IMPROVEMENTS

VILLAGE OF PERRY 46 N. MAIN ST. **PERRY, NY 14530**

100% CONSTRUCTION **DOCUMENT BID SET**

NOTES & REVISIONS:

	Revisi	on Schedule
Revision Number	Date	Description


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Drawn By:	Checked By:


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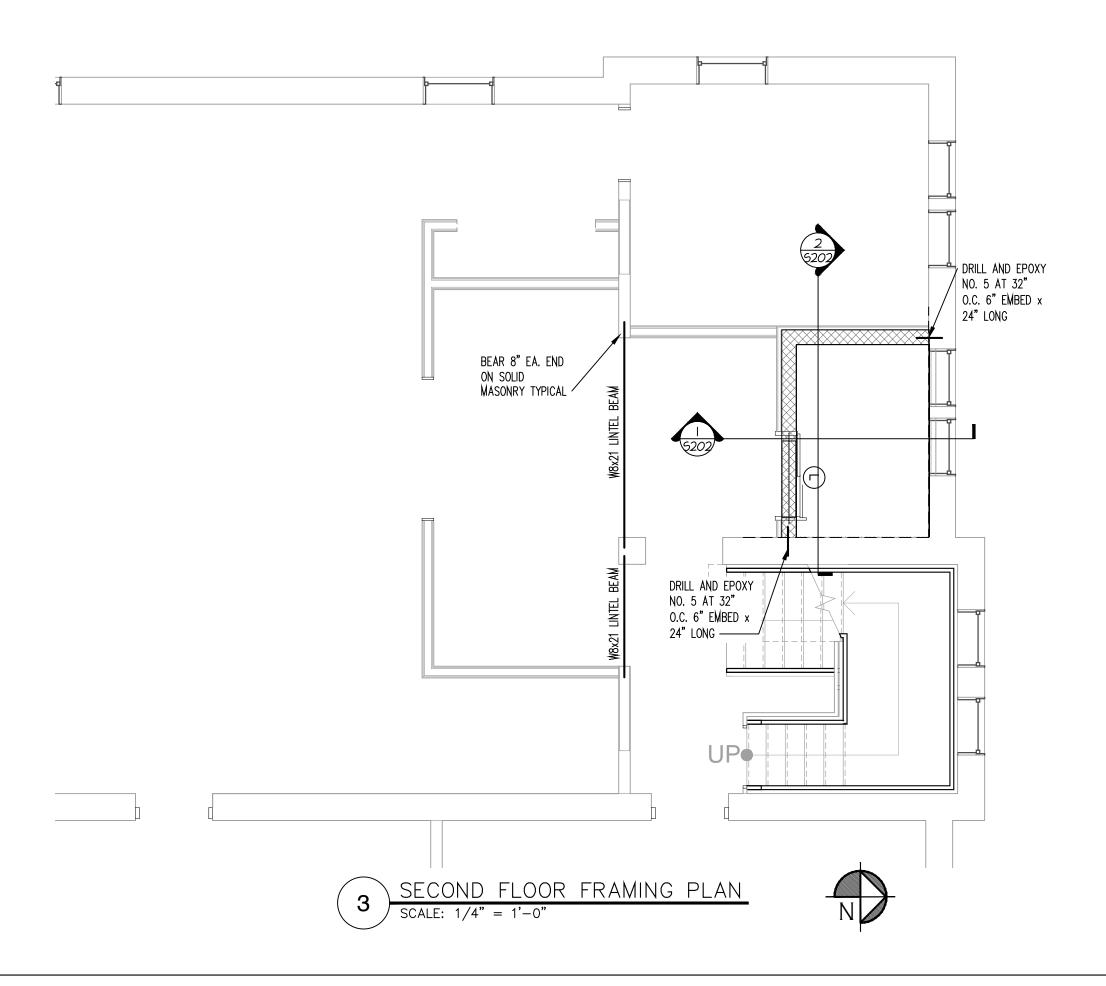
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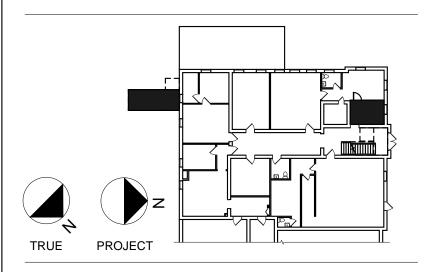
Drawing Number

A7-01





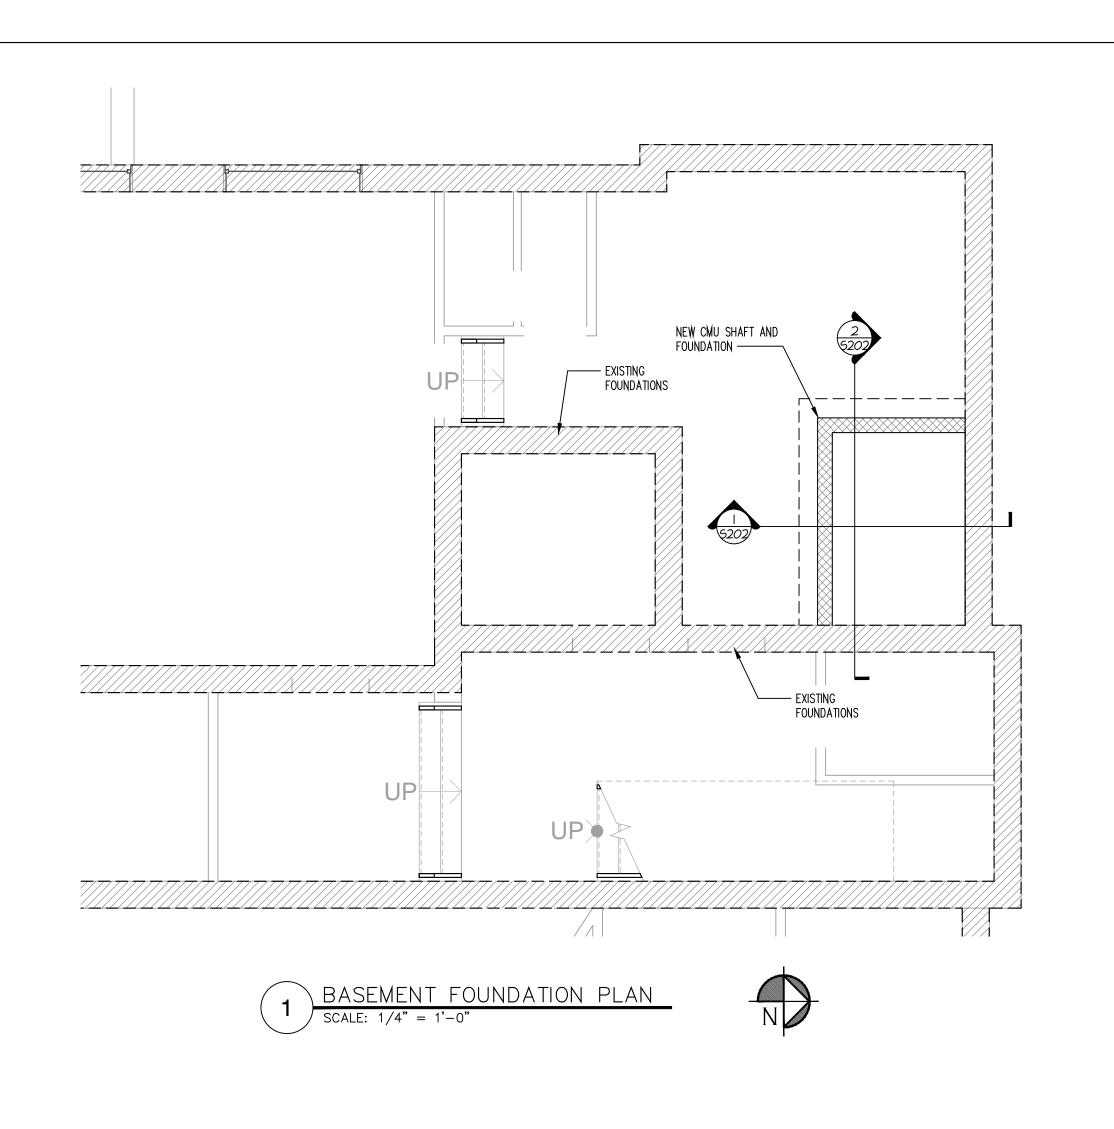

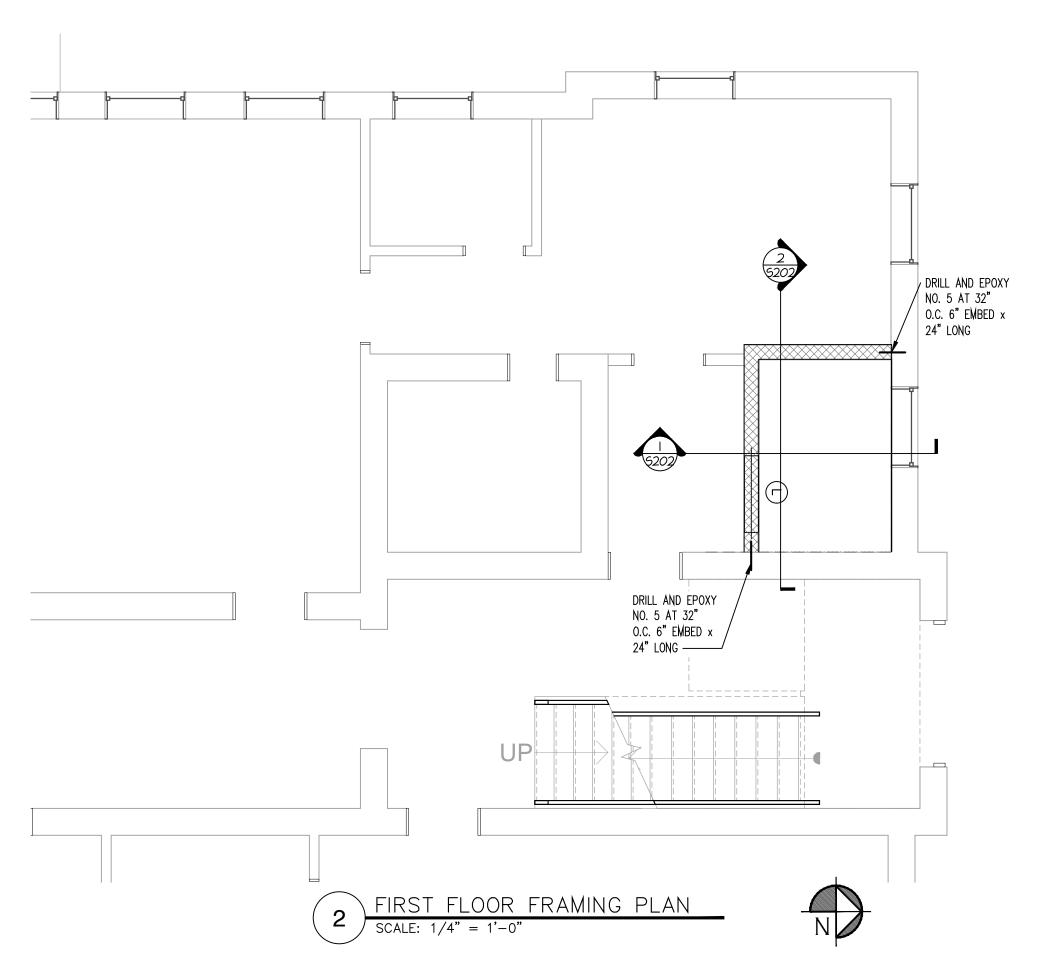

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PERRY VILLAGE HALL ADA **IMPROVEMENTS**

46 N. MAIN ST.

PERRY, NY 14530

VILLAGE OF PERRY

100% CONSTRUCTION **DOCUMENT SUBMISSION**

NOTES & REVISIONS:

Revision Number Date


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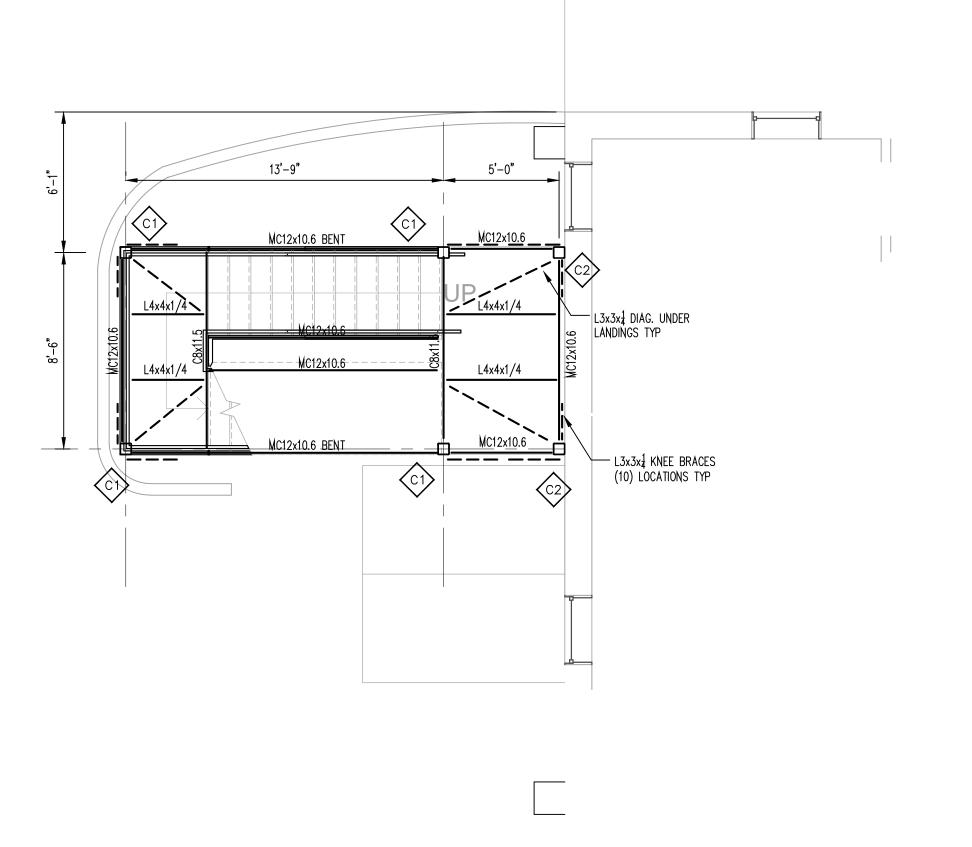
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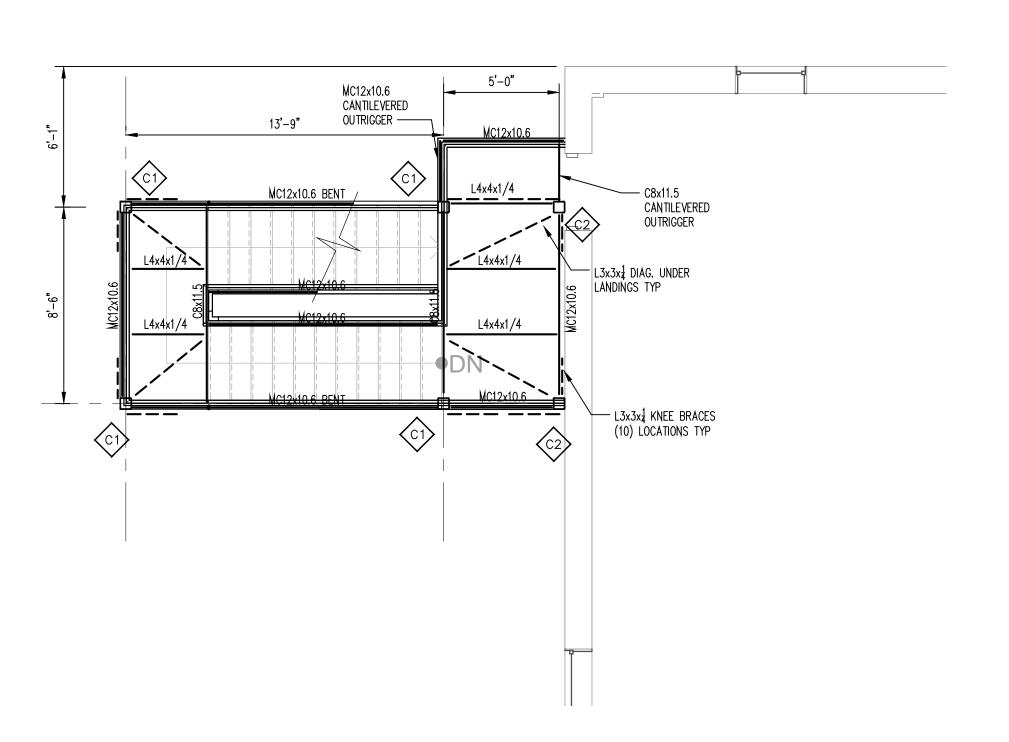
ELEVATOR PLANS


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S1-01








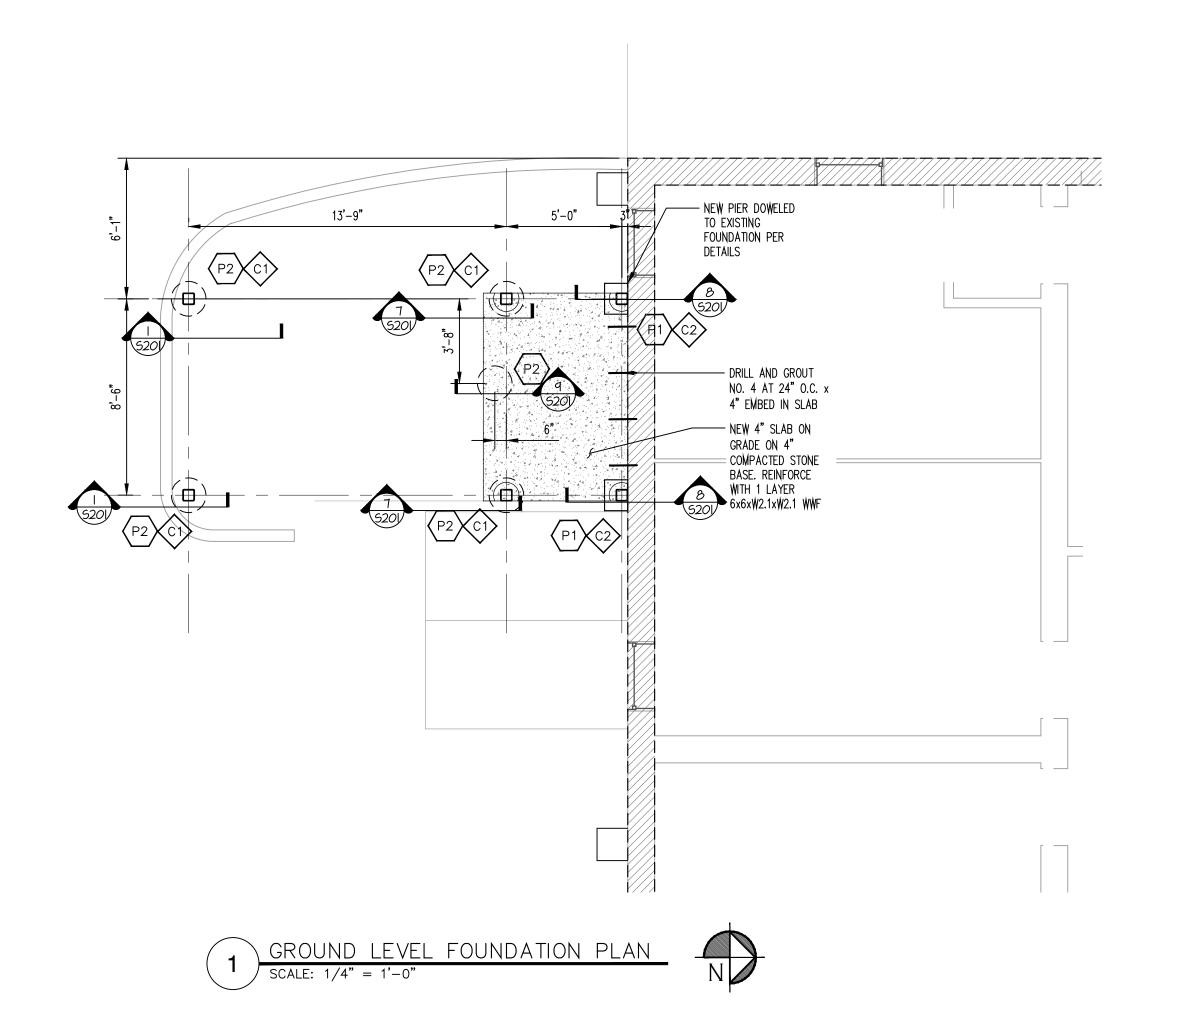

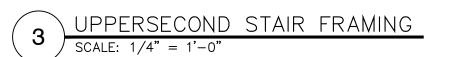

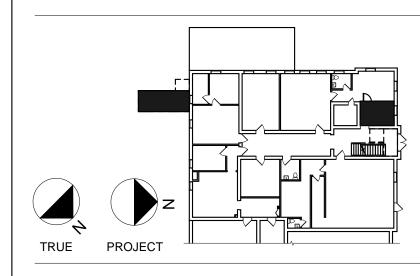

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245 Kinsey Ave Kenmore, New York 14217 Telephone (716) 854-3508



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PERRY VILLAGE HALL ADA **IMPROVEMENTS**

VILLAGE OF PERRY 46 N. MAIN ST.

PERRY, NY 14530 100% CONSTRUCTION DOCUMENT SUBMISSION

NOTES & REVISIONS:


Revision Schedule					
Revision Number	Date	Description			

DRAWING ISSUED:	MARCH 23, 2021
Project Number:	Scale:
00370	As indicated
Drawn By:	Checked By:
MB	LM

Drawing Title STAIR PLANS

Drawing Number

S1-02

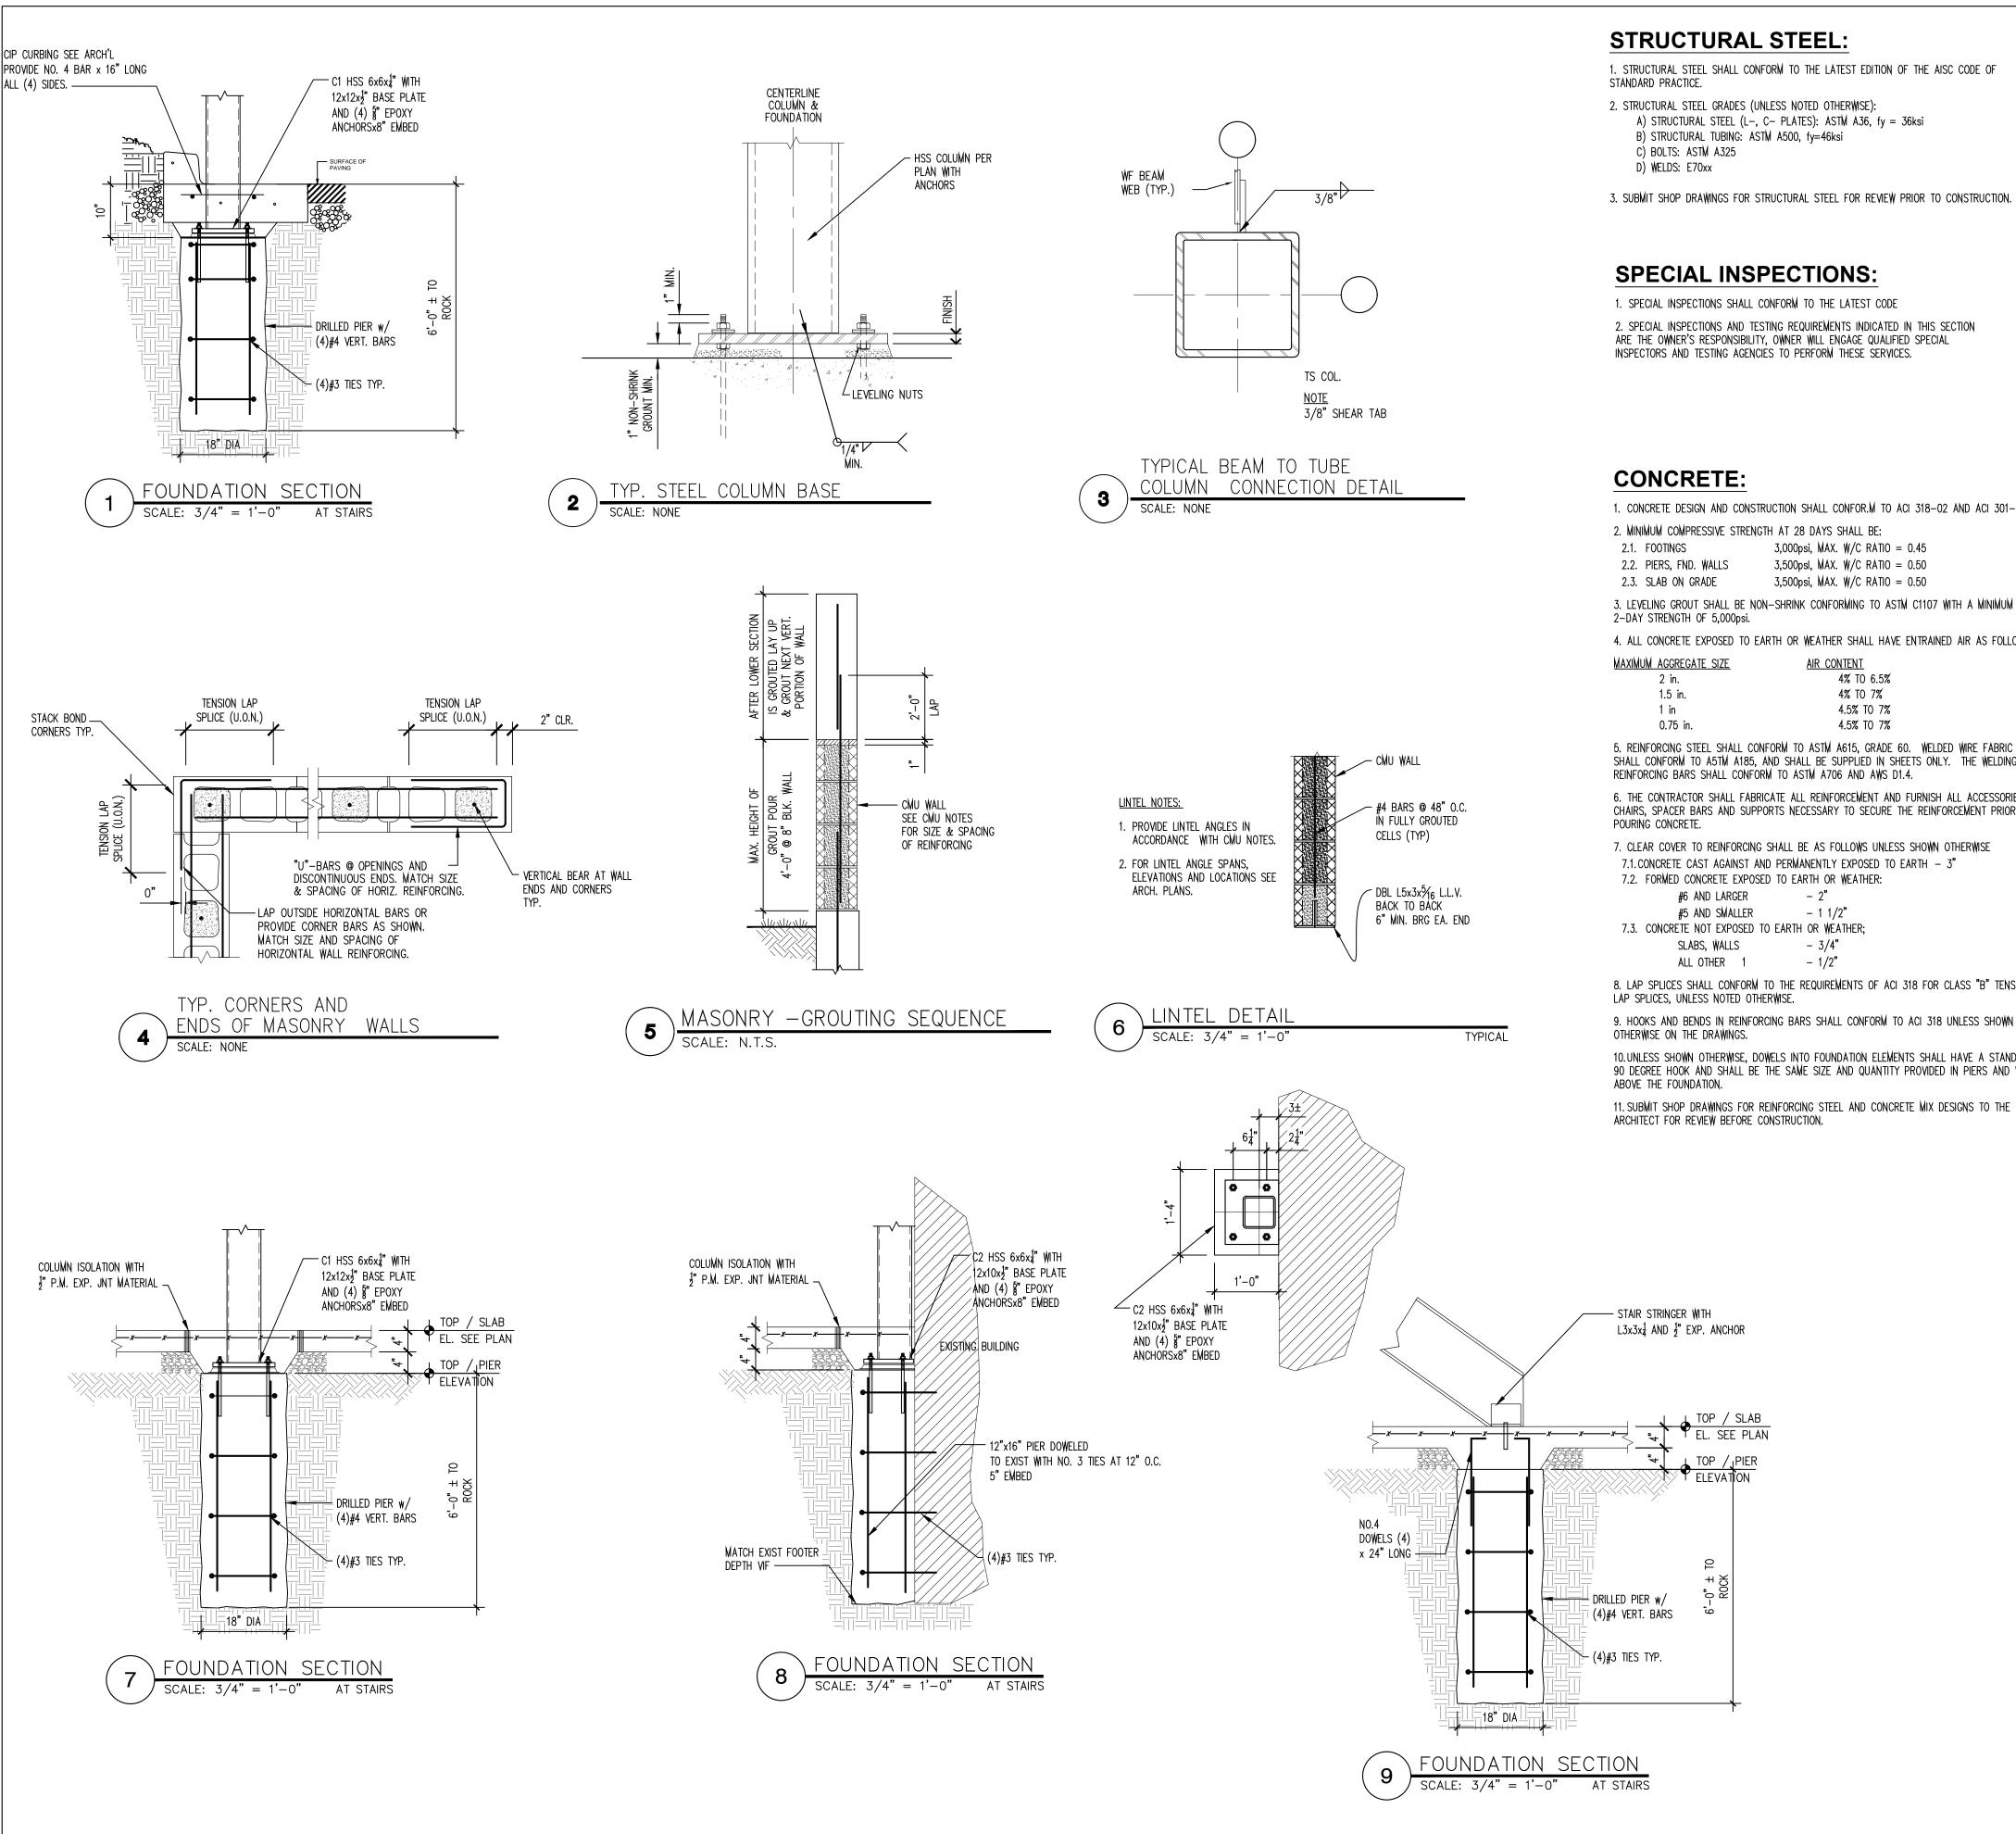

1. STRUCTURAL STEEL SHALL CONFORM TO THE LATEST EDITION OF THE AISC CODE OF

A) STRUCTURAL STEEL (L-, C- PLATES): ASTM A36, fy = 36ksi

3. SUBMIT SHOP DRAWINGS FOR STRUCTURAL STEEL FOR REVIEW PRIOR TO CONSTRUCTION.

2. SPECIAL INSPECTIONS AND TESTING REQUIREMENTS INDICATED IN THIS SECTION ARE THE OWNER'S RESPONSIBILITY, OWNER WILL ENGAGE QUALIFIED SPECIAL

1. CONCRETE DESIGN AND CONSTRUCTION SHALL CONFOR.M TO ACI 318-02 AND ACI 301-05.

3,000psi, MAX. W/C RATIO = 0.45 3,500psl, MAX. W/C RATIO = 0.50

3. LEVELING GROUT SHALL BE NON-SHRINK CONFORMING TO ASTM C1107 WITH A MINIMUM

4. ALL CONCRETE EXPOSED TO EARTH OR WEATHER SHALL HAVE ENTRAINED AIR AS FOLLOWS:

5. REINFORCING STEEL SHALL CONFORM TO ASTM A615, GRADE 60. WELDED WIRE FABRIC SHALL CONFORM TO A5TM A185, AND SHALL BE SUPPLIED IN SHEETS ONLY. THE WELDING OF

6. THE CONTRACTOR SHALL FABRICATE ALL REINFORCEMENT AND FURNISH ALL ACCESSORIES, CHAIRS, SPACER BARS AND SUPPORTS NECESSARY TO SECURE THE REINFORCEMENT PRIOR TO

7. CLEAR COVER TO REINFORCING SHALL BE AS FOLLOWS UNLESS SHOWN OTHERWISE 7.1. CONCRETE CAST AGAINST AND PERMANENTLY EXPOSED TO EARTH - 3"

8. LAP SPLICES SHALL CONFORM TO THE REQUIREMENTS OF ACI 318 FOR CLASS "B" TENSION

10. UNLESS SHOWN OTHERWISE, DOWELS INTO FOUNDATION ELEMENTS SHALL HAVE A STANDARD 90 DEGREE HOOK AND SHALL BE THE SAME SIZE AND QUANTITY PROVIDED IN PIERS AND WALLS

11, SUBMIT SHOP DRAWINGS FOR REINFORCING STEEL AND CONCRETE MIX DESIGNS TO THE

DESIGN LOADS:

 LIVE LOAD: EXITS = 100 PSF

2. SNOW LOADS:

Pg = 50psfPf = 35psf (42PSF AT OVERHANGS) = 1.0 (1.2 AT OVERHANGS)

3. WIND LOADS: Vult = 109mph $l_{W} = 1.0$ EXPOSURE = B

<u>SEISMIC</u>

SEISMIC USE GROUP "II" -SEISMIC DESIGN CATEGORY "B" SDS = 0.114q

SD1 = 0.031gSITE CLASS "A"

BASIC SEISMIC FORCE RESISTING SYSTEM = ORDINARY MOMENT

FRAMES R=3.0 DESIGN BASE SHEAR = 1kANALYSIS PROCEDURE = EQUIVALENT LATERAL FORCE

PROCEDURE I e = 1.00

TO CONSTRUCTION.

GENERAL STRUCTURAL NOTES:

 DESIGN AND CONSTRUCTION SHALL CONFORM TO THE NEW YORK STATE BUILDING CODE 2020. THE DRAWINGS AND SPECIFICATIONS REPRESENT THE FINISHED STRUCTURE AS A COMPLETE UNIT THE CONTRACTOR SHALL BE RESPONSIBLE FOR ALL MEANS, METHODS, AND SEQUENCES OF ALL PHASES OF CONSTRUCTION AND DEMOLITION INCLUDING TEMPORARY SHORING, BRACING, COLD AND HOT-WEATHER PROTECTION, AND FOUNDATION UNDERPINNING. THE CONTRACTOR SHALL COMPLY WITH ALL APPLICABLE CODES AND STANDARDS THAT PERTAIN TO MEANS, METHODS. AND SEQUENCES OF CONSTRUCTION.

THE GENERAL CONTRACTOR SHALL ENGAGE A LICENSED PROFESSIONAL ENGINEER IN THIS JURISDICTION TO DEVELOP SHORING CALCULATIONS AND PLANS SIGNED AND SEALED. THESE SHALL BE SUBMITTED TO THE ARCHITECT PRIOR TO THE START OF CONSTRUCTION.

2. THE STRUCTURAL DRAWINGS ARE TO BE USED IN CONJUNCTION AND COORDINATED WITH ALL OTHER CONTRACT DRAWINGS AND SPECIFICATIONS. THE CONTRACTOR SHALL COORDINATE SUCH REQUIREMENTS INTO THEIR WORK,

3, DETAILS NOT SPECIFICALLY SHOWN SHALL BE SIMILAR TO THOSE SHOWN FOR THE MOST NEARLY SIMILAR CONDITION AS DETERMINED BY THE ARCHITECT OR ENGINEER. 4. CONTRACTOR TO COORDINATE ALL OPENINGS, EQUIPMENT LOCATIONS, AND INSERTS SHOWN

ON THE STRUCTURAL DRAWINGS WITH THE TRADES THAT REQUIRE THEM. PENETRATIONS

THROUGH STRUCTURAL MEMBERS ARE NOT PERMITTED EXCEPT AS DETAILED. 5. CONTRACTOR SHALL VERIFY EXISTING CONDITIONS IN THE FIELD AND NOTIFY THE ARCHITECT OF ANY DISCREPANCIES, ALL DIMENSIONS TO THE EXISTING STRUCTURE AND ALL STRUCTURAL SIZES AND DEPICTIONS ARE APPROXIMATE AND SHALL BE VERIFIED BY THE CONTRACTOR PRIOR

6. WHERE DEMOLITION OR OTHER MODIFICATIONS TO THE EXISTING STRUCTURE ARE REQUIRED. THE CUTTING, DRILLING, AND REMOVALS SHALL OCCUR IN A MANNER WHICH WILL PREVENT DAMAGE TO ADJOINING CONSTRUCTION WHICH IS TO REMAIN. UNLESS OTHERWISE INDICATED, PROVIDE NEW MATERIALS TO MATCH THE APPEARANCE AND PERFORMANCE OF EXISTING CORRESPONDING MATERIALS WHERE DEMOLITION OCCURS.

7. STRUCTURAL MEMBERS MARKED (EX) ARE EXISTING AND ARE TO BE VERIFIED IN THE FIELD. 8. SHOP DRAWINGS PREPARED BY SUPPLIERS AND SUBCONTRACTORS SHALL BE REVIEWED AND SIGNED AND STAMPED BY THE CONTRACTOR PRIOR TO SUBMISSION TO THE ARCHITECT AND ENGINEER. REPRODUCTIONS OF THE STRUCTURAL DRAWINGS SHALL NOT BE USED FOR THE PREPARATION OF SHOP DRAWINGS. MANUFACTURED COMPONENTS SHALL BE SIGNED AND

9. ALL SHOP DRAWINGS SHALL INCORPORATE ACTUAL EXISTING CONDITIONS WHERE THE NEW CONSTRUCTION ADJOINS THE EXISTING STRUCTURE. THE EXISTING STRUCTURE IS TO BE EXPOSED AS NEEDED TO VERIFY THAT THE EXISTING STRUCTURE MATCHES THE DESIGN INTENT. THE ARCHITECT IS TO BE NOTIFIED WHEN THE EXISTING CONDITIONS DO NOT MATCH THE DESIGN INTENT OR WHEN THE EXISTING CONDITIONS NECESSITATE A CHANGE TO THE DESIGN.

STAMPED BY A LICENSED PROFESSIONAL ENGINEER PRIOR TO SUBMISSION.

FOUNDATIONS:

1. SOIL BEARING SURFACES SHALL BE DRY AND FREE FROM FROST OR LOOSE MATERIAL. EXISTING SOIL TO BE REMOVED AND REPLACED AS RECOMMENDED BY THE GEOTECHNICAL ENGINEER. ALL SOIL BEARING SURFACES AND BACKFILL SHALL BE INSPECTED AND APPROVED BY THE GEOTECHNICAL ENGINEER OR OTHER APPROVED TESTING AGENT.

2. CONTRACTOR SHALL VERIFY AND LOCATE ALL EXISTING BELOW GRADE UTILITIES PRIOR TO CONSTRUCTION.

3. CONTRACTOR TO PROVIDE TEMPORARY PROTECTION AS REQUIRED FOR FOUNDATIONS EXPOSED TO WATER OR FREEZING.

MASONRY:

1. CONCRETE MASONRY DESIGN AND CONSTRUCTION SHALL CONFORM TO THE LATEST EDITION OF

2. CONCRETE MASONRY UNITS SHALL CONFORM TO ASTM C-90, TYPE I, GRADE N, MOISTURE CONTROLLED UNITS WITH F'm = 2,000psi.

3. MORTAR SHALL BE TYPE M OR S AND SHALL CONFORM TO ASTM CC70.

4. HORIZONTAL JOINT REINFORCING: 9ga, ASTM A82, GALVANIZED LADDER-TYPE SHALL BE PROVIDED AT 16" O.C. UNLESS NOTED OTHERWISE.

5. GROUT FOR FILLING BLOCK CORES SHALL CONFORM TO ASTM C476 WITH A MINIMUM COMPRESSIVE STRENGTH OF 2,000psi AT 28 DAYS. GROUT SHALL BE PLACED IN LIFTS NOT EXCEEDING 7 COURSES IN HEIGHT UNLESS OTHERWISE APPROVED BY THE ENGINEER.

6. FULL HEAD AND BED JOINTS SHALL BE PROVIDED. 7. COORDINATE LOCATION OF ALL MASONRY WALLS, PARTITIONS AND OPENINGS WITH

ARCHITECTURAL DRAWINGS. 8. LAP SPLICES IN VERTICAL REINFORCING FOR CONCRETE BLOCK MASONRY WALLS AND PILASTERS SHALL BE A MINIMUM OF 48 BAR DIAMETERS UNLESS DETAILED OTHERWISE ON THE


9. ALL LINTELS AT MASONRY OPENINGS SHALL HAVE 4" MIN. OR 1" FOR EACH FOOT OF SPAN OF BEARING AT EACH END. ALL EXTERIOR LINTELS SHALL BE HOT DIPPED GALVANIZED. 10. REFERENCE ARCHITECTURAL DRAWINGS AND PROJECT SPECIFICATIONS FOR CONTROL JOINT LOCATION REQUIREMENTS. ALL BOND BEAM REINFORCEMENT TO BE CONTINUOUS AT CONTROL JOINT LOCATIONS. SCORE BOND BEAM SHELL 3/8" EACH SIDE AT CONTROL JOINTS.

11. MASONRY COURSING INDICATED ON THE STRUCTURAL DRAWINGS IS APPROXIMATE. REFER TO ARCHITECTURAL DRAWINGS FOR ACTUAL COURSING LAYOUT.

12. REINFORCING STEEL SHALL BE IN PLACE AND SECURE PRIOR TO PLACING GROUT. 13. ALL MASONRY CELLS BELOW GRADE SHALL BE GROUTED SOLID.

14. SUBMIT SHOP DRAWINGS FOR REINFORCING STEEL, GROUT AND MORTAR MIX DESIGNS, AND CMU PRODUCT DATA TO THE ARCHITECT FOR REVIEW BEFORE CONSTRUCTION.

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617 Main Street, Suite 401 Buffalo, New York 14203 Telephone (716) 854-2424

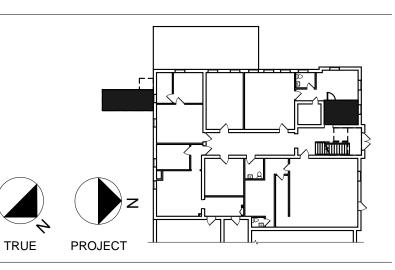

PETRILLI STRUCTURAL & CONSULTING ENGINEERING, P.C.

245 Kinsey Ave Kenmore, New York 14217 Telephone (716) 854-3508



P.MAX ENGINEERING, P.C.

Buffalo, New York 14222 Telephone (716) 381-9389

PERRY VILLAGE HALL ADA **IMPROVEMENTS**

VILLAGE OF PERRY 46 N. MAIN ST. PERRY, NY 14530

100% CONSTRUCTION **DOCUMENT SUBMISSION**

NOTES & REVISIONS:


Revision Schedule Revision Number Date


DRAWING ISSUED: MARCH 23, 2021 Project Number: |Scale: As indicated Drawn By: Checked By: Drawing Title

DETAILS

Drawing Number

S2-01

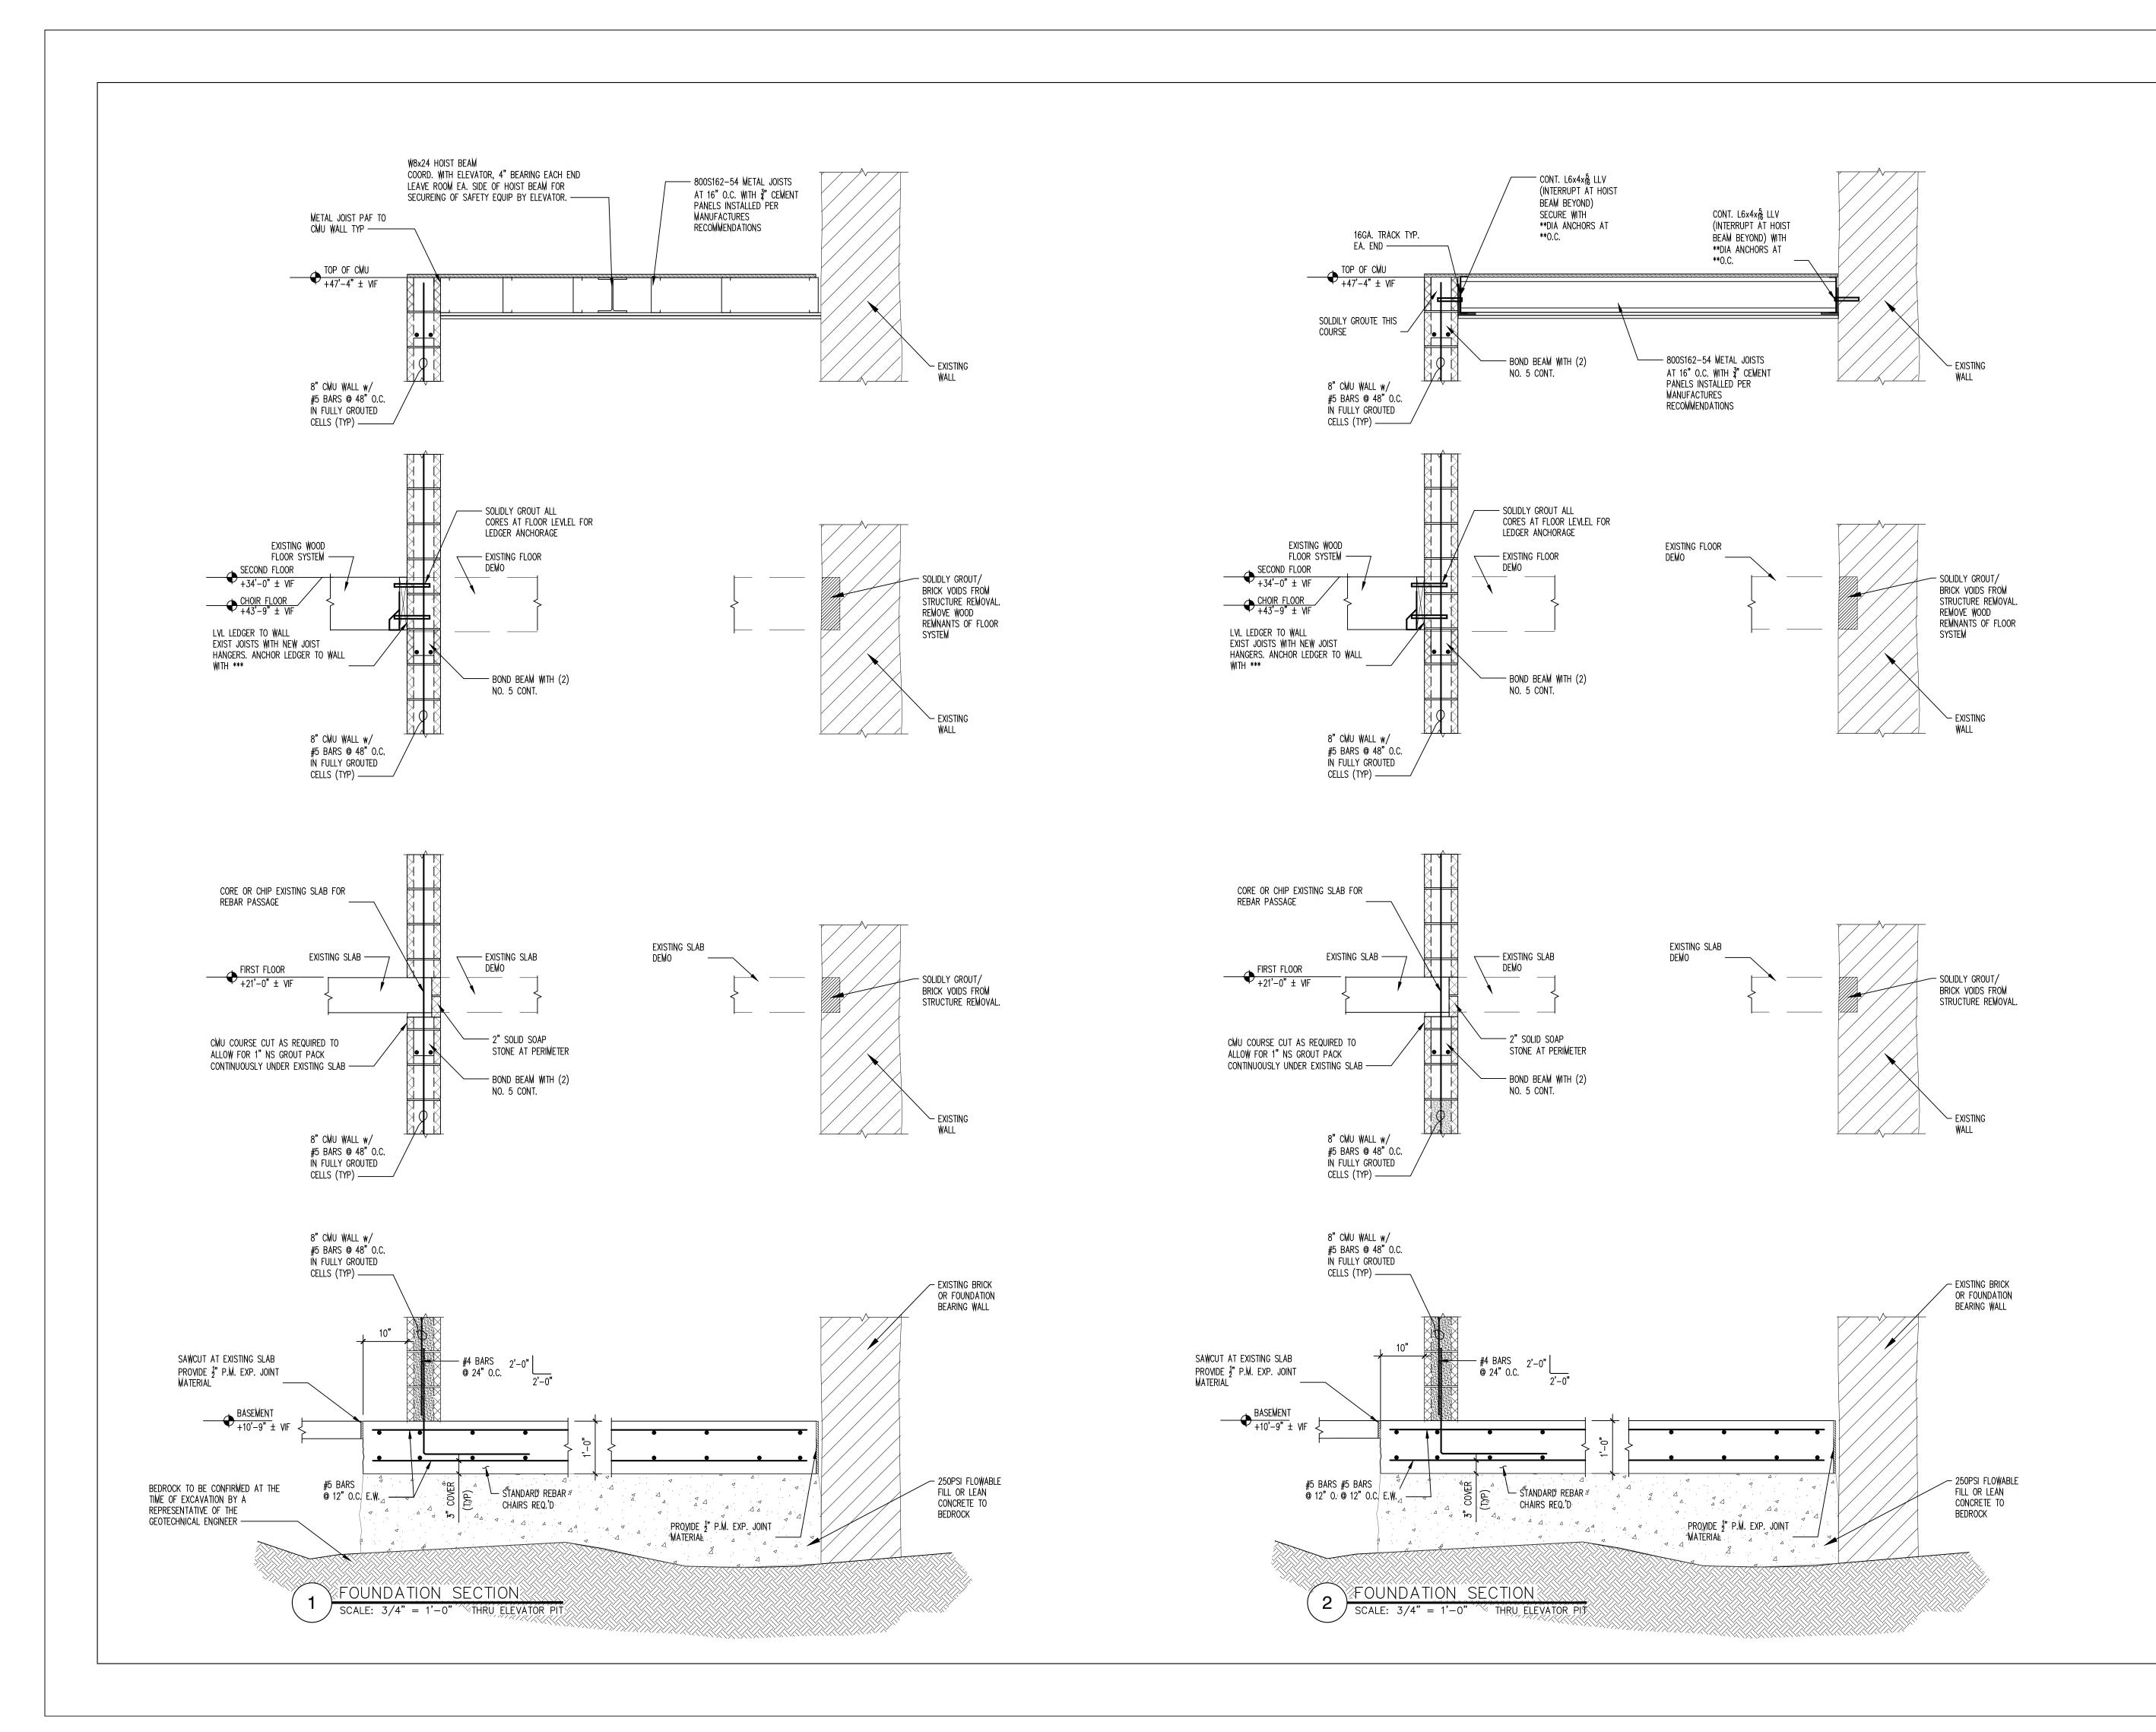

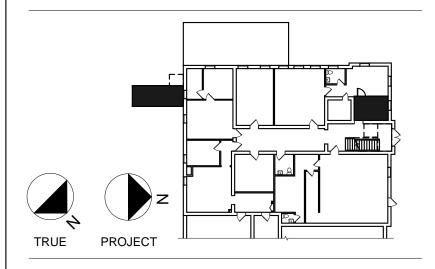

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DATE 01/05/2020

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245 Kinsey Ave Kenmore, New York 14217 Telephone (716) 854-3508



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engineering™ 298 Fafayette Ave Buffalo, New York 14222 Telephone (716) 381-9389

PERRY VILLAGE HALL ADA **IMPROVEMENTS**

VILLAGE OF PERRY 46 N. MAIN ST.

PERRY, NY 14530

100% CONSTRUCTION DOCUMENT SUBMISSION

NOTES & REVISIONS:

Revision Schedule Revision Number Date

DRAWING ISSUED: FEBRUARY 01, 2021 Project Number: Scale: As indicated 00370 Drawn By: Checked By: **Drawing Title**


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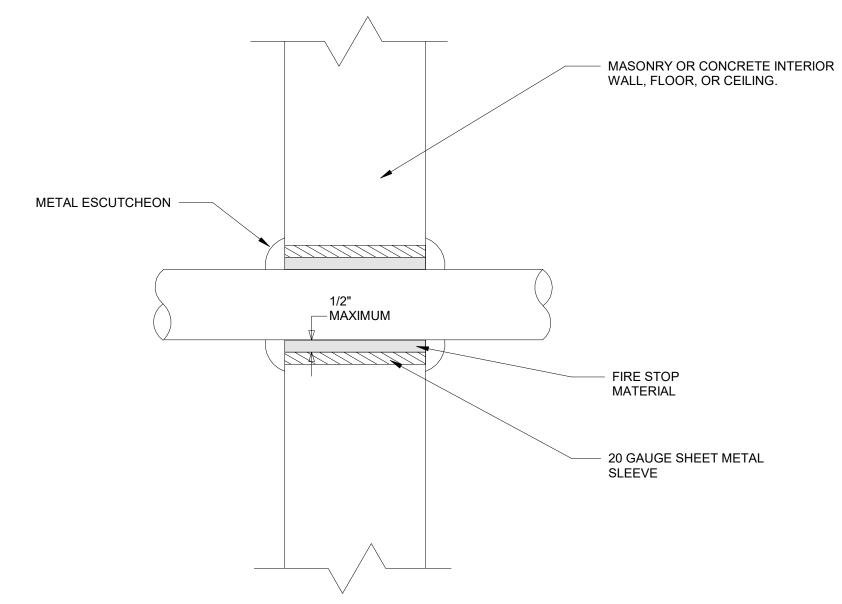
S2-02

GENERAL PLUMBING NOTES:

- PROVIDE FOR THE PROPER FIELD FITTING OF WORK. THE CONTRACTOR SHALL PROVIDE FOR FIELD MEASUREMENTS AS REQUIRED AND SHALL BE RESPONSIBLE
- THIS CONTRACTOR SHALL REVIEW ALL CONTRACT DRAWINGS AND SPECIFICATIONS TO COORDINATE THE PLACEMENT OF PLUMBING WORK WITH THE WORK OF
- PROVIDE FOR ALL CUTTING, PATCHING, CORE DRILLING AND FIRE STOPPING REQUIRED TO ACCOMPLISH WORK SHOWN FOR THIS TRADE. PATCH AND SEAL OPENINGS TO MATCH EXISTING WALLS, FLOORS, CEILINGS, ETC. UNLESS OTHERWISE INDICATED. ALL WORK IN FINISHED AREAS SHALL BE CONCEALED UNLESS OTHERWISE INDICATED OR DIRECTED BY THE ARCHITECT.
- PROVIDE ALL MAKE-UP WATER, DRAINS, INDIRECT WASTE DRAINS, ETC. CONNECTIONS TO MECHANICAL EQUIPMENT AS INDICATED ON THE PLANS. COORDINATE WITH OTHER TRADES FOR FINAL CONNECTION POINTS.
- PROVIDE ALL SUBMITTED EQUIPMENT AND SYSTEMS IN COMPLIANCE WITH THE MANUFACTURERS WRITTEN INSTALLATION INSTRUCTIONS AND SPECIFICATIONS.
- ALL PHYSICAL ATTRIBUTES OF EQUIPMENT AND DEVICES ARE BASED ON THOSE MANUFACTURERS LISTED IN THE SPECIFICATIONS AND/OR THE EQUIPMENT SCHEDULES. PROVIDE FOR ALL CHANGES BROUGHT ABOUT BY THE USE OF ITEMS SUBMITTED AND BY OTHER MANUFACTURERS AT NO COST TO OWNER. THE ARCHITECT/ENGINEER HAS RESERVED THE RIGHT TO REJECT ITEMS BY OTHER MANUFACTURERS.
- PROVIDE FOR THE PROPER OFF-SITE DISPOSAL OF ALL CONSTRUCTION DEBRIS AND/OR EXCAVATED MATERIALS ASSOCIATED WITH WORK IN THIS TRADE IN COMPLIANCE WITH LOCAL, NEW YORK STATE AND FEDERAL LAWS AND REQUIREMENTS.
- PROVIDE ALL MATERIALS, EQUIPMENT, LABOR, ETC. AS REQUIRED TO PERFORM THE CONTRACT WORK. ALL SYSTEMS AND EQUIPMENT SHALL BE COMPLETE AND OPERATIONAL.
- PLUMBING FIXTURES AND EQUIPMENT IN SPACES ACCESSIBLE TO THE PUBLIC SHALL BE FULLY HANDICAPPED ACCESSIBLE. EQUIPMENT FOR USE IN SPACES SPECIFICALLY DESIGNATED FOR HANDICAPPED USE SHALL BE DESIGNED FOR HANDICAPPED USE AND SHALL CONFORM TO THE AMERICANS WITH DISABILITIES
- PROVIDE ALL WORK IN COMPLIANCE WITH ALL LOCAL, STATE, AND FEDERAL CODES AND ORDINANCES, SUCF DESIGN GUIDELINES AS WELL AS ALL APPLICABLE NFPA STANDARDS, AND OTHER REFERENCED STANDARDS.
- PROVIDE FOR ALL NECESSARY INSPECTIONS PRIOR TO COMPLETION OF WALLS AND CEILINGS. PROVIDE ONE WEEK WRITTEN NOTIFICATION.
- LOCATE PIPING TO PREVENT FREEZING. DO NOT INSTALL WATER PIPING IN EXTERIOR WALLS.
- THE DRAWINGS ARE SCHEMATIC IN INTENT. PROVIDE ALL MATERIALS, EQUIPMENT, AND LABOR NECESSARY FOR A COMPLETE INSTALLATION. ADJUST THE LOCATION OF ALL PIPING, STACKS, EQUIPMENT, AND CONNECTIONS TO ACCOMMODATE ACTUAL CONSTRUCTION CONDITIONS ENCOUNTERED; OBTAIN APPROVAL FROM THE ARCHITECT FOR ALL BUT MINOR CHANGES. ALL EQUIPMENT SHALL BE INSTALLED TO BE FULLY ACCESSIBLE FOR OPERATION AND MAINTENANCE IN ACCORDANCE WITH MANUFACTURER'S INSTALLATION REQUIREMENTS.
- ALL PIPES PENETRATING RATED WALLS AND FLOOR DECKS SHALL BE FIRESTOPPED USING APPROVED, U.L. LISTED FIRE STOPPING MATERIAL. REFER TO THE ARCHITECTURAL DRAWINGS FOR FIRE RATED WALL AND FLOOR LOCATIONS; CONFIRM ALL LOCATIONS WITH ARCHITECTURAL DRAWINGS.
- PROVIDE ALL EQUIPMENT IN COMPLETE COMPLIANCE WITH MANUFACTURERS INSTALLATION INSTRUCTIONS, AND THE PROJECT SPECIFICATIONS.
- PROVIDE ACCESS PANELS FOR ALL VALVES, WATER HAMMER ARRESTORS, CLEANOUTS, FAUCET / FLUSH VALVE TRANSFORMERS, ETC CONCEALED BEHIND WALLS AND ABOVE CEILINGS, WHERE OTHERWISE INACCESSIBLE. PROVIDE FIRE RATED WHERE ARCHITECTURAL DRAWINGS SHOW RATING. ACCESS PANELS TO MATCH RATING FOR WALL/CEILING.
- PROVIDE A PRODUCT SUBMITTAL FOR ANY PRODUCTS TO BE INSTALLED THAT ARE NOT IDENTIFIED IN THE PROJECT MANUAL OR ON THE DRAWINGS.
- TEST ALL EQUIPMENT AND PIPING SYSTEMS FOR PROPER OPERATION. PROVIDE FOR PRESSURE TESTING OF ALL PIPING AND EQUIPMENT IN COMPLIANCE WITH THE 2020 PLUMBING CODE OF NEW YORK STATE AND IN ACCORDANCE WITH MANUFACTURERS REQUIREMENTS. PROVIDE COPIES OF TEST REPORTS IN THE FINAL O&M MANUALS.
- PROVIDE RECORD DRAWINGS DEPICTING THE LOCATIONS OF PIPING, EQUIPMENT, VALVES, AND CLEANOUTS AS-BUILT ON A CLEAN SET OF DRAWINGS. PROVIDE FULL SIZE COPIES FOR THE OWNER, ARCHITECT AND ENGINEER. PROVIDE COPIES OF THE OPERATION AND MAINTENANCE MANUALS TO OWNER INCLUDING ALL PRODUCTS AND MECHANICAL EQUIPMENT IN COMPLIANCE WITH THE CONTRACT REQUIREMENTS. RECORD DRAWINGS SHALL BE PROVIDED ON THE ORIGINAL BID DOCUMENT PLANS AS SUPPLIED BY THE ARCHITECT. CONTRACTOR SHALL OBTAIN THE ORIGINAL BID DOCUMENTS AND PERMISSION FOR THE USE FROM THE ARCHITECT.
- PROVIDE FOR ALL ACCESSORIES, INCLUDING HANGERS, SUPPORTS, CONTROLS, INSULATION, VALVES, AS REQUIRED FOR A COMPLETE INSTALLATION.
- ALL ROOF WORK REQUIRED INCLUDING CUTTING AND PATCHING SHALL BE PROVIDED TO COMPLY WITH ROOFING MANUFACTURER'S WRITTEN REQUIREMENTS AND SHALL COMPLY WITH ALL WARRANTY CONDITIONS.
- MINIMUM SLOPE FOR DRAINAGE PIPE WITHIN 5'-0" OF BUILDING IS 1/4" PER FOOT FOR 2-1/2" DIAMETER AND LESS AND 1/8" PER FOOT FOR 3" DIAMETER AND
- DOMESTIC HOT WATER SHALL BE SUPPLIED TO PLUMBING FIXTURES AT 140 DEGREES F. ALL INDIVIDUAL LAVATORIES, SINKS AND MOP SINKS SHALL BE PROVIDED WITH ASSE 1070 POINT OF USE MIXING DEVICES DESIGNED TO FAIL TO COLD WATER.
- PROVIDE FOR PAINTING OF ALL EXPOSED PIPING. SANITARY, VENT, STORM AND NATURAL GAS SHALL BE COATED WITH A RUST INHIBITOR, PRIMED AND PAINTED. EXPOSED INSULATION ON DOMESTIC COLD, HOT AND HOT WATER RECIRCULATION PIPING SHALL BE FINISHED PAINTED. REFER TO ARCHITECTURAL PLANS AND S PECIFICATIONS FOR PAINTING REQUIREMENTS.
- ALL PLUMBING FIXTURE AND EQUIPMENT WATER CONNECTIONS SHOULD BE SUPPLIED WITH LINE-SIZE BALL VALVES FOR ISOLATION.






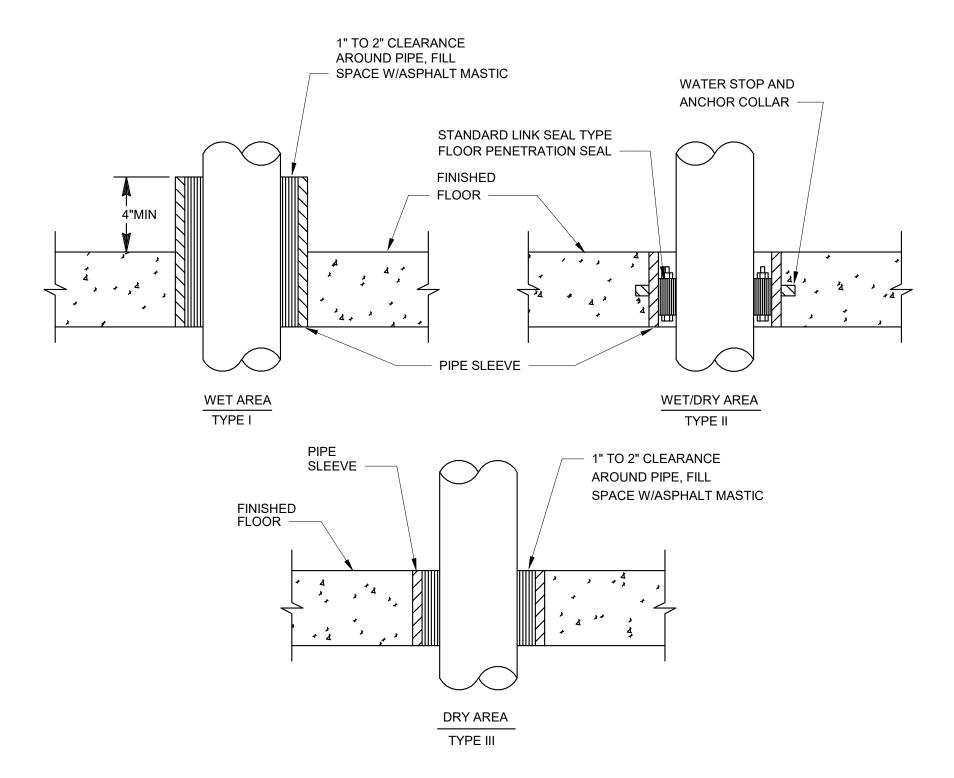


PIPE PENETRATION - INTERIOR WALL DETAIL


P1-01 DRAWING NOTES

1 PROVIDE 2" PUMPED DISCHARGE CONNECTION TO EXISTING 4" WASTE STACK. FIELD VERIFY EXACT LOCATION OF STACK. PROVIDE ELEVATOR SUMP PUMP, WITH OIL SENSOR AND ALARM, 25 GPM @ 16FT. HEAD, 1/3HP, 120V, LIBERTY PUMPS ELV250 OR EQUIVALENT. PROVIDE SILENT CHECK VALVE IN DISCHARGE RISER. COORDINATE WITH EVELATOR CONTRACTOR AND G.C.

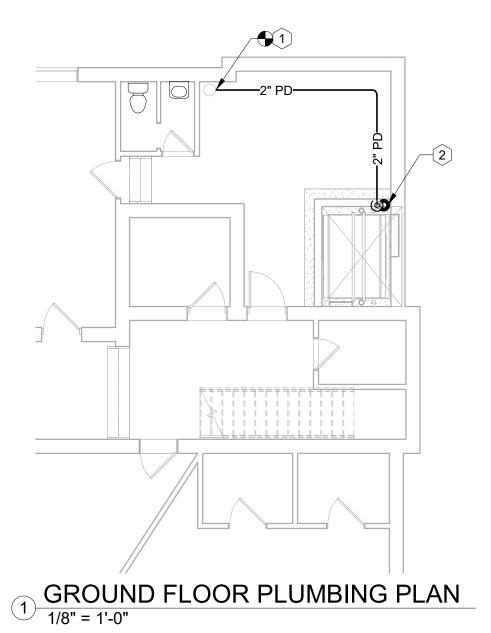

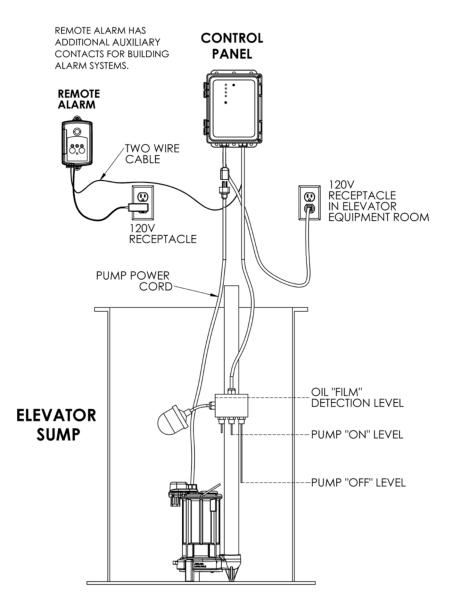


SUMP PUMP DETAIL

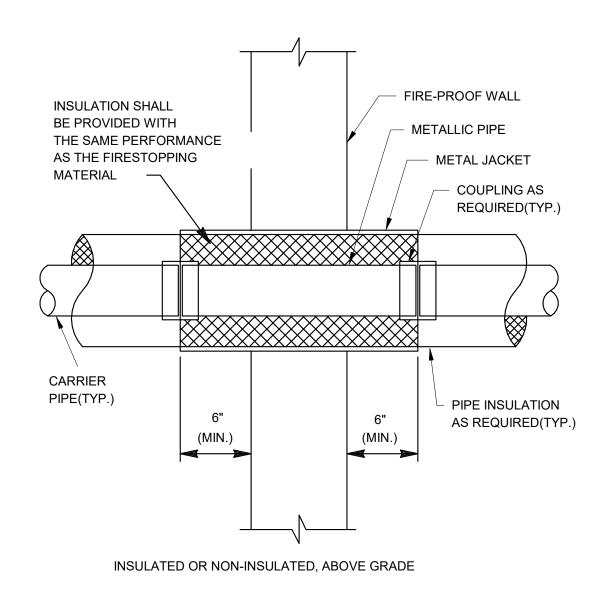

FIRE-PROOF WALL PENETRATION DETAIL

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NOTES & REVISIONS:

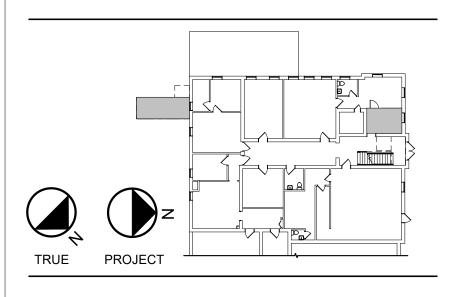Revision Schedule Revision Number Description

DRAWING ISSUED: APRIL 5, 2021 Project Number: Scale: As indicated Drawn By: Checked By:

Drawing Title

FIRST FLOOR PLAN - PLUMBING

Drawing Number

P1-01

GENERAL MECHANICAL NOTES:

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SYMBOLS AND ABBREVIATIONS:

T	THERMOSTAT
Š	TEMPERATURE SENSOR
(E)	EXISTING TO REMAIN
AHU	AIR HANDLING UNIT
BOD	BOTTOM OF DUCT ELEVATION
CFM	CUBIC FEET PER MINUTE
DSD	DUCT SMOKE DETECTOR
EA	EXHAUST AIR
EC	ELECTRICAL CONTRACTOR
EWT	ENTERING WATER TEMPERATURE
FA	FRESH AIR
G.C.	GENERAL CONTRACTOR

GLYCOL WATER RETURN GLYCOL WATER SUPPLY HEAT PUMP

INCHES OF WATER GAUGE (COLUMN) LEAVING WATER TEMPERATURE MCA MINIMUM CURRENT AMPACITY MOCP MAXIMUM OVERCURRENT PROTECTION O.E.D OPEN ENDED DUCT

OUTDOOR AIR PLUMBING CONTRACTOR


PERMANENT SPLIT CAPACITOR MOTOR RETURN AIR RATED LOAD AMPS

SUPPLY AIR SUPPLY FAN **SEER** SEASONAL ENERGY EFFICIENCY RATIO SMACNA SHEET METAL AND AIR CONDITIONING

CONTRACTORS NATIONAL ASSOCIATION

TRANSFER

DIFFUSER / REGISTER TAG DIFFUSER / REGISTER CFM

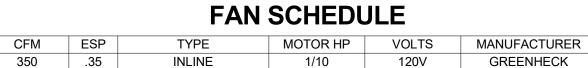

MODEL

SQ-80-VG


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TAG


EF-1

2. PROVIDE WITH BACKDRAFT DAMPER. 3. PROVIDE WITH IAQ TEMP/HUMIDITY CONTROL.

4. PROVIDE WITH DUCT MOUNT SMOKE DETECTOR, WIRED TO SHUT FAN DOWN UPON SMOKE DETECTION.

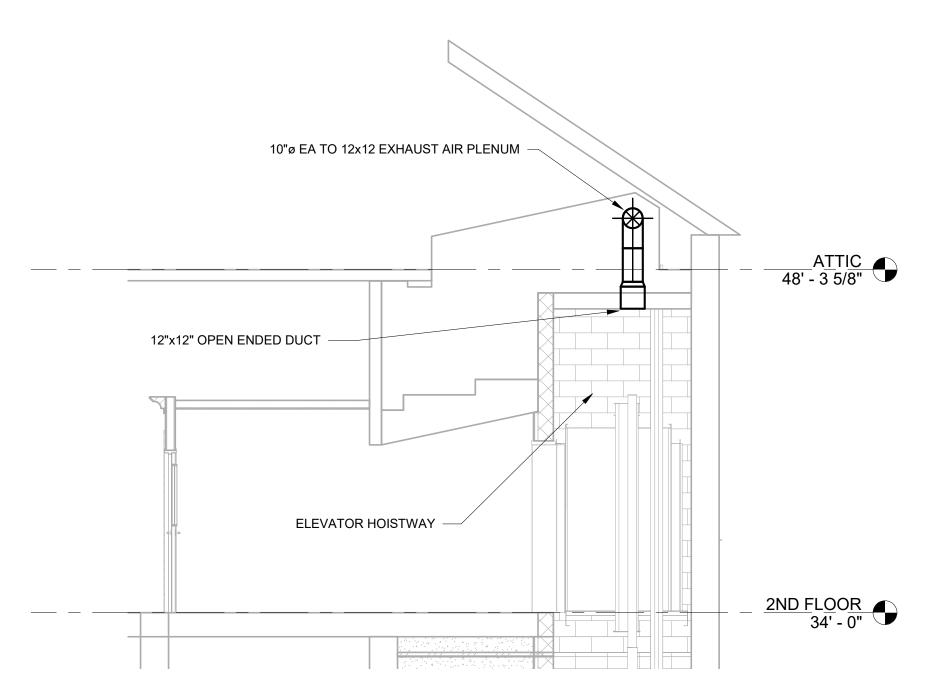


2 ELEVATOR EXHAUST FAN SECTION VIEW

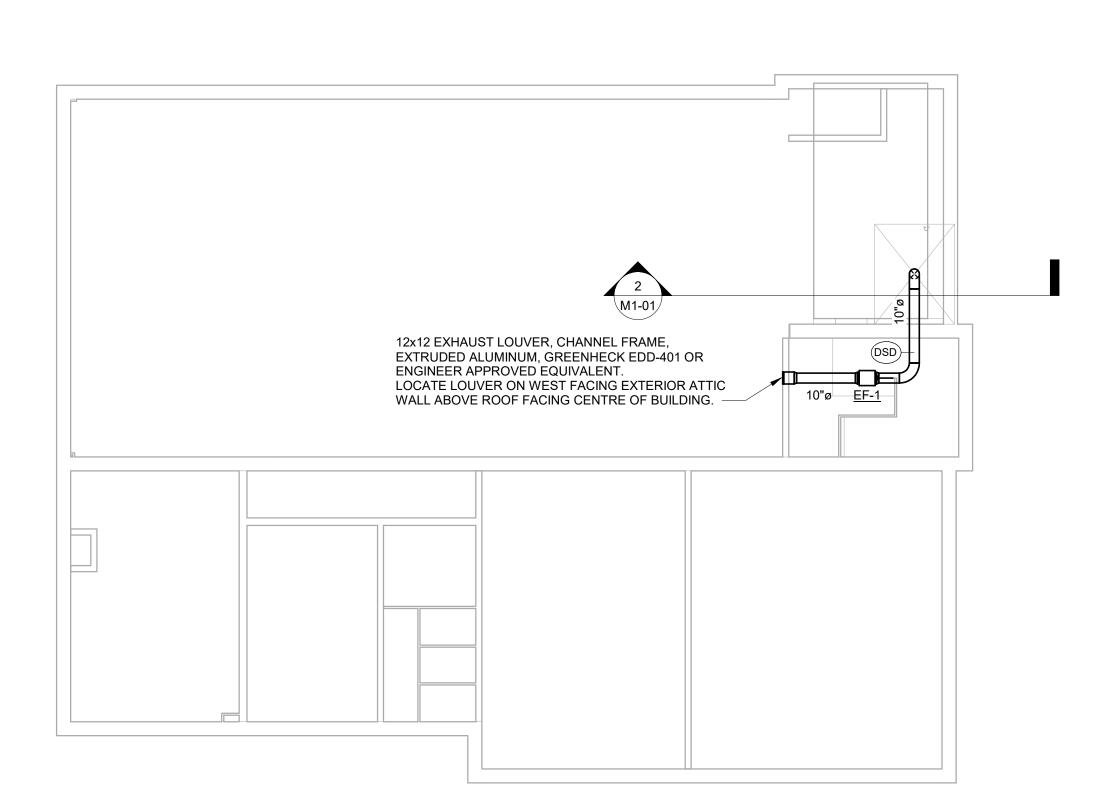

1 ATTIC PLAN - MECHANICAL 1/8" = 1'-0"

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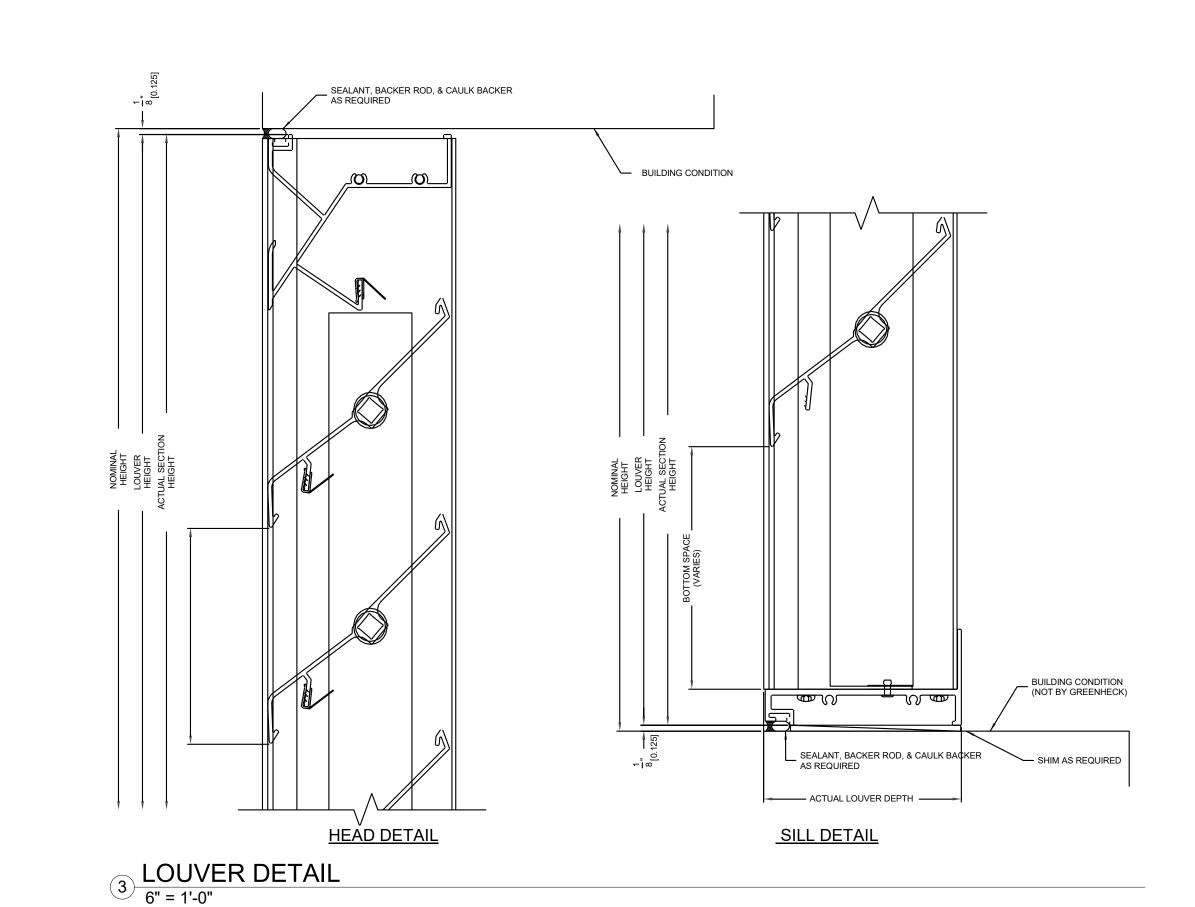
DRAWING ISSUED: APRIL 5, 2021 Project Number: Scale: As indicated Drawn By: Checked By:


Drawing Title

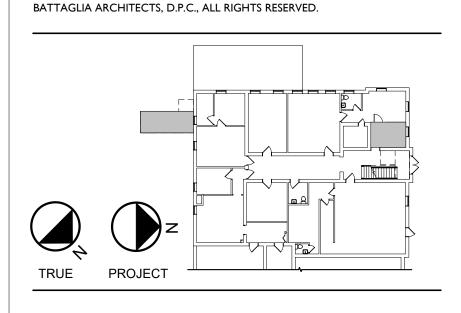ATTIC PLAN - MECHANICAL


Drawing Number

M1-01



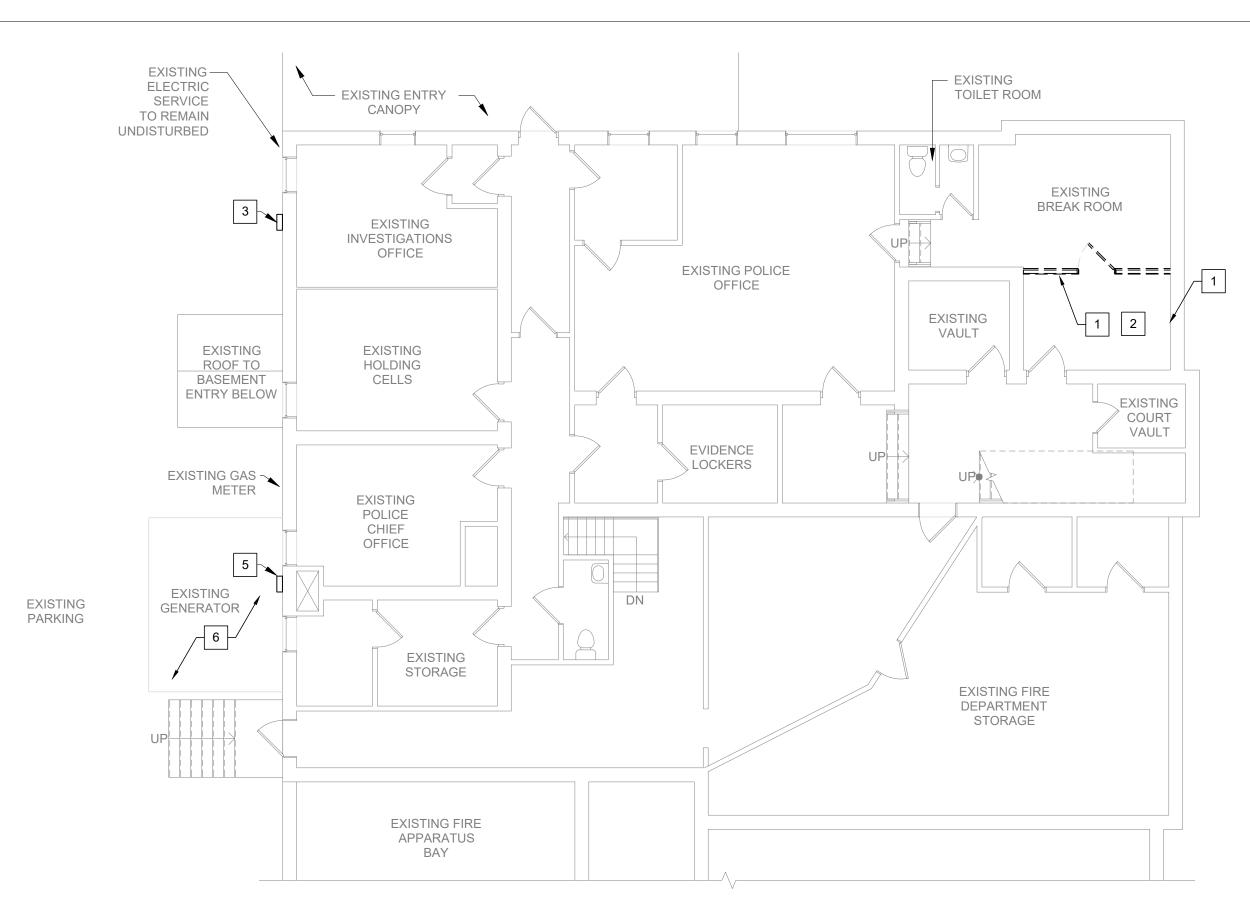

GROUND FLOOR DEMOLITION PLAN

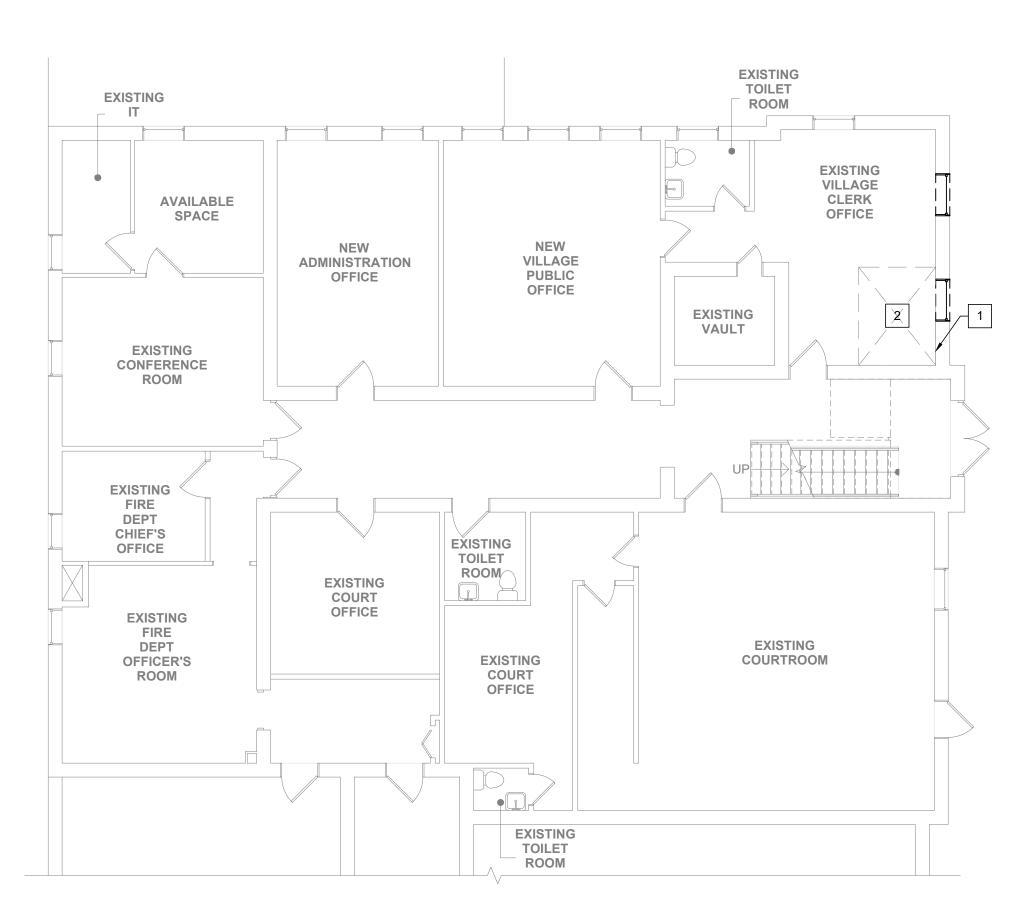

2 FIRST FLOOR DEMOLITION PLAN 1/8" = 1'-0"

MISCELLANEOUS SYMBOLS


- PANELBOARD, SURFACE MOUNTED
- FUSED DISCONNECT AS INDICATED. INDOOR NEMA 1.
- MOTOR CONNECTION "1/2" DENOTES HORSEPOWER RATING
- HOMERUN TO PANELBOARD PP.
- ✓ PP-2 FED FROM BREAKER, CIRCUIT #2, UNLESS INDICATED OTHERWISE.
- DUPLEX RECEPTACLE DEVICE. 120V. 20AMP.
- ← LIGHT SWITCH DEVICE. 120V. 15AMP.
- (S) SMOKE DETECTION UNIT PROVISION
- JUNCTION BOX

GENERAL NOTES:


- A. EXISTING CONDITIONS WERE NOTED FROM FIELD OBSERVATIONS AND EXISTING DRAWINGS. CONTRACTOR SHALL FIELD VERIFY EXISTING CONDITIONS AND NOTIFY OF DISCREPANCIES TO OWNER AND/OR ARCHITECT/ENGINEER.
- B. DISCONNECT AND REMOVE EXISTING DEVICES, FIXTURES, RACEWAYS AND EQUIPMENT AS INDICATED. MAINTAIN CIRCUIT INTEGRITY AND OPERATION AT ALL TIME IN "NOT-IN-CONTRACT" (N.I.C) SPACES. EXISTING CIRCUITS SHOULD BE TRACED WITH "AMPROBE PHASOR" DEVICE OR SIMILAR INSTRUMENT TO VERIFY THEIR IMPACT IN ADJACENT AND/OR N.I.C AREAS PRIOR TO REMOVAL AND INTERRUPTION.
- C. CONTRACTOR SHALL PROTECT AND PROVIDE TEMPORARY POWER TO ALL EXISTING TO REMAIN DEVICES IMPACTED DURING THE CONSTRUCTION PHASE. PROVIDE ALL MATERIALS TO RE-FEED DOWNSTREAM DEVICES TO REMAIN(IF ANY). FOLLOW AND COORDINATE CONSTRUCTION PHASING PLAN TO MEET BUILDING OPERATIONS.
- D. DISCONNECT AND REMOVE IMPACTED AND ABANDONED EXPOSED SURFACE RACEWAYS, INCLUDING UNUSED DEVICES.
- REFER TO EXISTING LUMINAIRES TO BE RELOCATED. RE-USED LIGHT FIXTURES SHOULD BE STORED IN A CLEAN DRY LOCATION FREE FROM DAMAGE. CLEAN, RE-LAMP, REPLACE LENS, AND RE-BALLAST SHALL BE PROVIDED PRIOR TO RE-INSTALLATION.
- F. CONTRACTOR SHALL COORDINATE SALVAGED DEVICES AND FIXTURES WITH OWNER. FIXTURES OR DEVICES CONTAINING PCB OR HAZARD MATERIALS SHALL BE HANDLED AND DISPOSAL AS REQUIRED BY ASBESTOS CONTRACTOR AND AS INDICATED IN UNIVERSAL WASTE SPECIFICATION SECTION, UNLESS OTHERWISE NOTED.
- G. ALL SHOWN DASHED ELEMENTS ARE FOR REMOVAL, UNLESS OTHERWISE NOTED. SHOWN ELEMENTS ARE TO DEPICT REMOVAL, BUT NOT NECESSARILY REPRESENT EXACT DEVICE QUANTITIES. CONTRACTOR TO FIELD VERIFY AND CONFIRM FINAL QUANTITIES, LENGTHS, TYPE.

KEYED DEMOLITION NOTES:


- 1. DISCONNECT AND REMOVE EXISTING ELECTRICAL DEVICES, EQUIPMENT IN THE IMPACTED, DEMOLISHED WALL(S).
- 2. DISCONNECT, REMOVE AND SALVAGE EXISTING OVERHEAD LUMINAIRE(S) TO ACCOMMODATE NEW ELEVATOR SHAFT. RETAIN CIRCUITS. RE-USE AND RELOCATE LUMINAIRE(S) OUTSIDE THE SHAFT SPACE, EXTEND CIRCUITRY AS NEEDED.
- 3. EXISTING WALLPACK FIXTURE (TYP. OF 2). DISCONNECT AND REMOVE IN ITS ENTIRETY. RETAIN EXTERIOR LIGHTING CIRCUITRY FOR RE-USE.
- 4. DISCONNECT AND REMOVE M/E/P ELEMENTS, DEVICES AS PART OF ALTERNATE #1. COORDINATE FINAL DEMOLITION SCOPE WITH ARCHITECT.
- 5. EXISTING WALLPACK LUMINAIRE AND CIRCUIT TO REMAIN AS IS.
- 6. EXISTING EMERGENCY GENERATOR UNIT TO REMAIN AS IS. PROTECT DURING CONSTRUCTION PHASE.

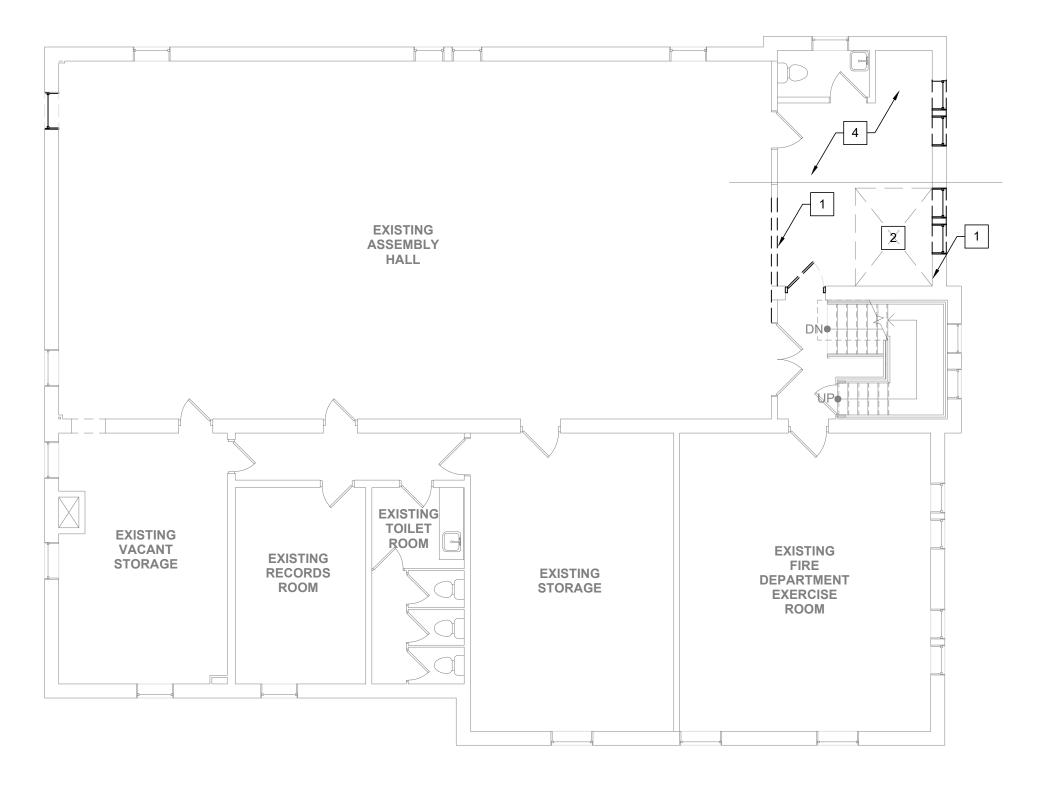

SECOND FLOOR DEMOLITION PLAN 1/8" = 1'-0"

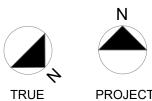

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THE REGISTERED PROFESSIONAL CERTIFIES THAT THIS PROJECT HAS BEEN DESIGNED BY ME, OR UNDER MY SUPERVISION, IN ACCORDANCE WITH: THE BUILDING CODE OF NEW YORK STATE AND THE ENERGY CONSERVATION CODE OF NEW YORK STATE AND APPLICABLE FEDERAL LAWS AND REGULATIONS AND TO THE BEST OF MY KNOWLEDGE AND BELIEF, THESE CONSTRUCTION DOCUMENTS ARE IN CONFORMANCE THEREWITH.

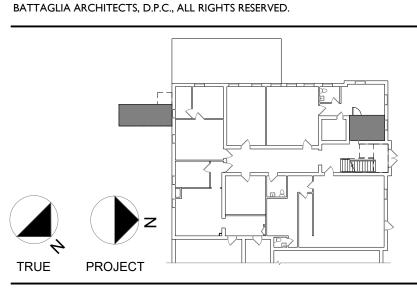DATE _____04/02/2021



FLYNN BATTAGLIA

617 Main Street, Suite 401 Buffalo, New York 14203 Telephone (716) 854-2424



PETRILLI STRUCTURAL & CONSULTING ENGINEERING, P.C.

245 Kinsey Ave Kenmore, New York 14217 Telephone (716) 854-3508



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PERRY VILLAGE HALL

VILLAGE OF PEERY 46 N. MAIN ST. **PERRY, NY 14530**

100% CONSTRUCTION **DOCUMENT SUBMISSION**

NOTES & REVISIONS:

	Revisi	ion Schedule
Revision Number	Date	Description


DRAWING ISSUED: APRIL 5, 2021 Project Number: Scale: As indicated Drawn By: Checked By:


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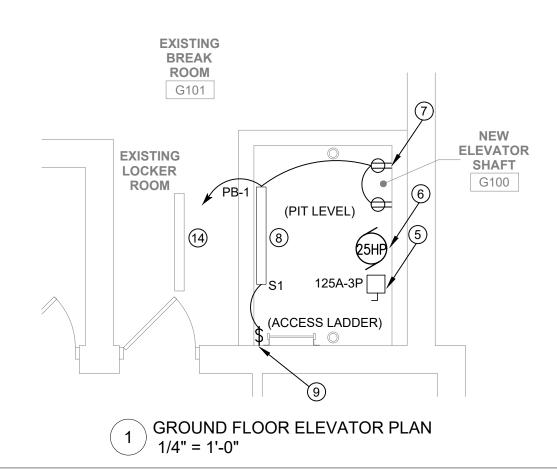
ELECTRICAL DEMOLITION PLAN


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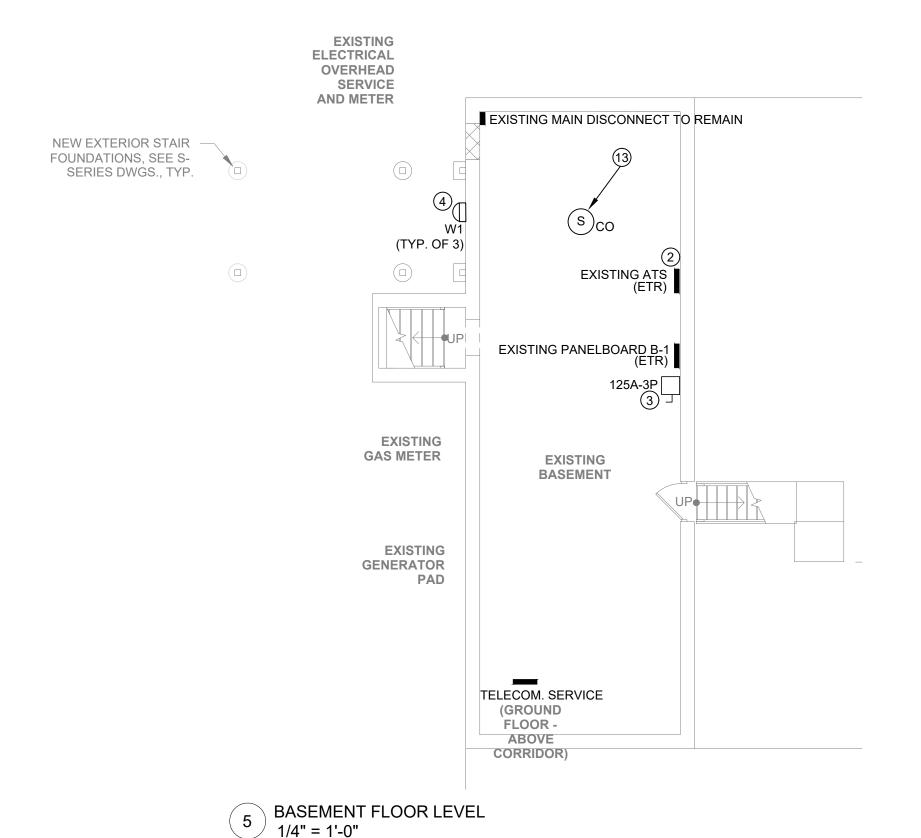






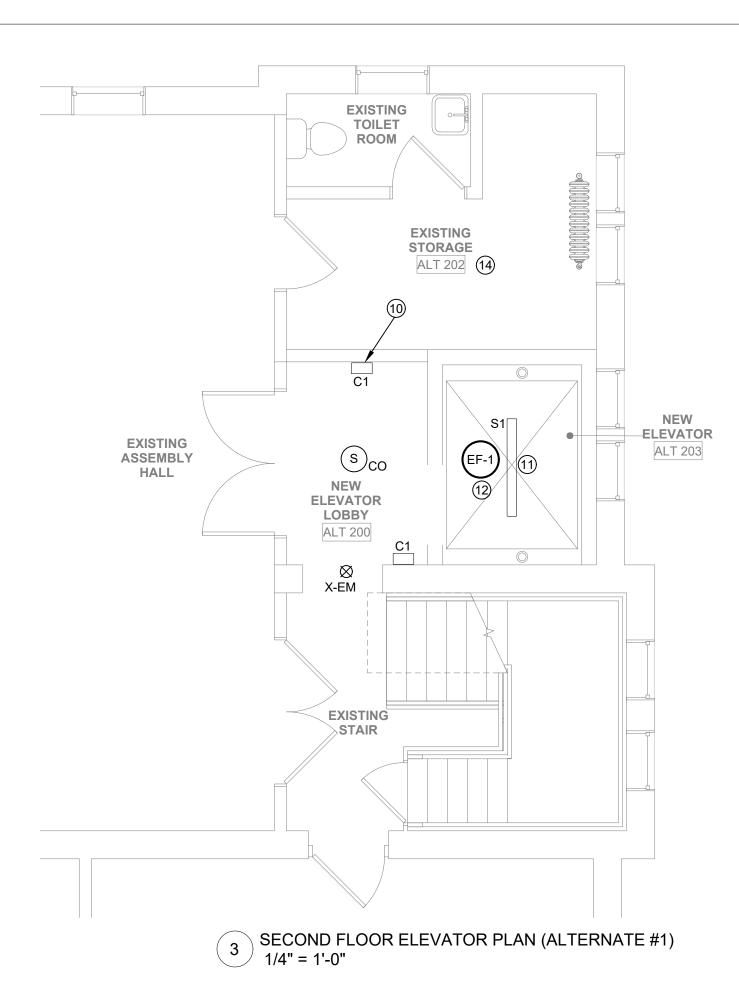

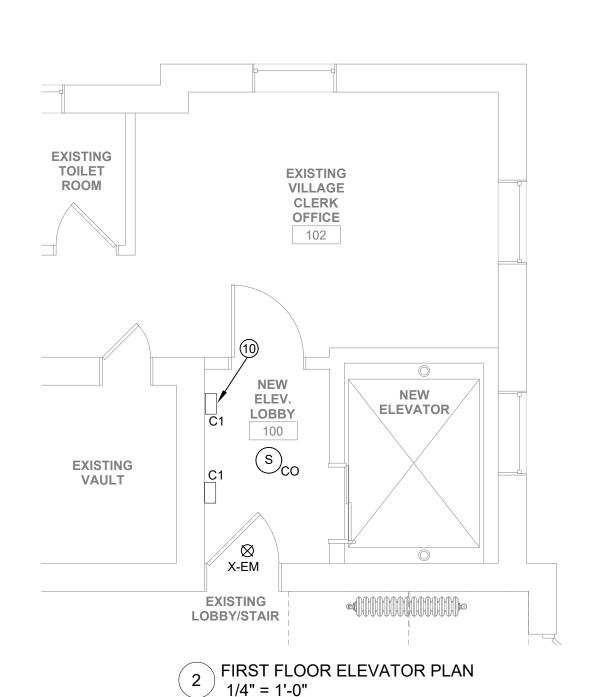

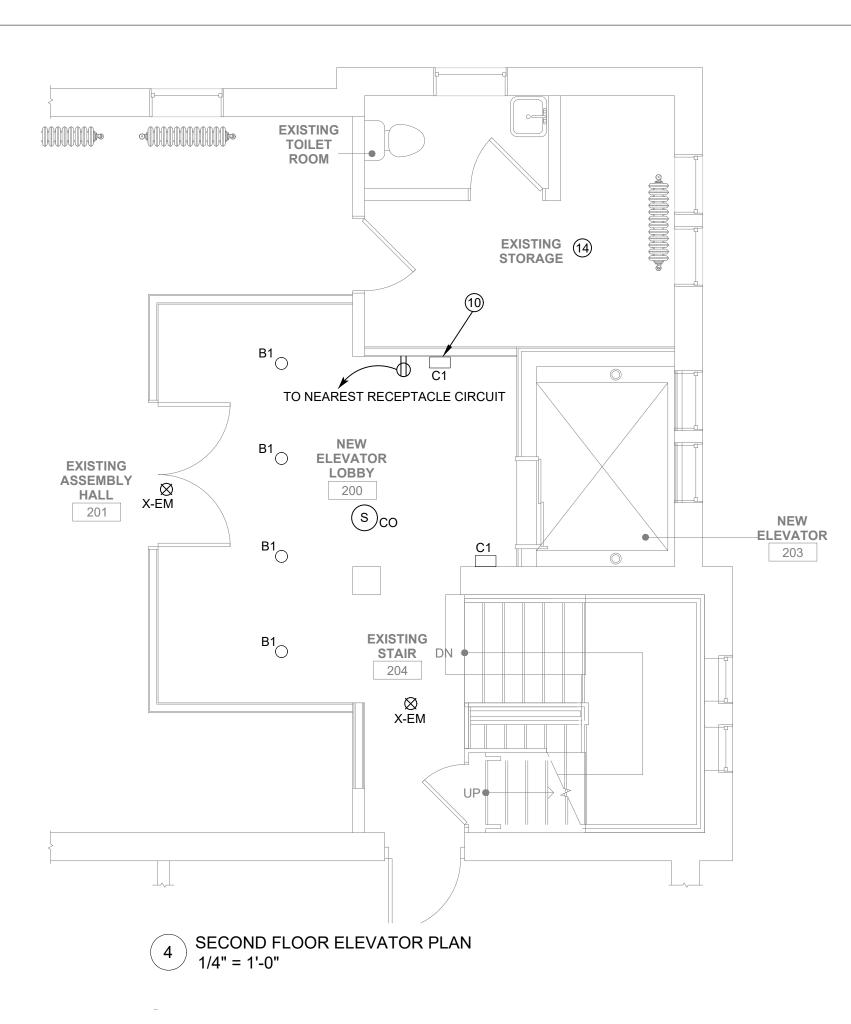

GENERAL NOTES (ALL SHEETS)

- a. CONTRACTOR TO COORDINATE FINAL ELECTRICAL REQUIREMENTS WITH ELEVATOR CONTRACTOR.
- b. CONTRACTOR TO FOLLOW PERRY OF VILLAGE PROCEDURES FOR ACCESS AND WORK IN FACILITIES.
- c. AREAS OF WORK AND OTHER DISTURBED AREAS DO FOLLOW A PHASING PLAN AND/OR CONSTRUCTION SEQUENCE, REFER TO MASTER PLAN DOCUMENTS AND OTHER DISCIPLINES (IF APPLICABLE).
- d. RELATED POWER SHUT-DOWNS SHALL BE SCHEDULED IN ADVANCE WITH OWNER'S REPRESENTATIVE, INDICATING AFFECTED CIRCUITS, AREAS/ROOMS AND POWER SHUT-DOWN DATE(S) AND TIME(S). CONSIDER AFTER BUSINESS AND/OR WEEKEND HRS. TO COMPLETE PROJECT WORK WITH MINIMAL DISTURBANCE AND/OR INTERRUPTIONS.
- e. ALL ELECTRICAL MATERIALS AND EQUIPMENT SHALL BE SUITABLE FOR AREAS OF WORK. I.E. HOISTWAY. ALL EXPOSED RACEWAYS SHALL BE PAINTED AND MATCH TO EXISTING WALL COLOR. UTILIZE SURFACE MOUNT RACEWAYS IN FINISH SPACES.
- SALVAGE AND/OR RE-USED EQUIPMENT/MATERIAL SHALL BE PROTECTED FROM CONSTRUCTION OR STORED AND RE-INSTALL AS INDICATED. CLEAN AND PROVIDE NEW MOUNTING SUPPORTS AS REQUIRED.
- RELOCATE UNFORESEEN ELECTRICAL ITEM(S) IMPACTED BY NEW WORK AND NOT INDICATED SPECIFICALLY ON DOCUMENTS. MATCH WIRE, CONDUIT CHARACTERISTICS.
- CONTRACTOR TO PROVIDE WALL/FLOOR PENETRATIONS, AND PROVIDE FIREPROOF MATERIALS FOR INSTALLED CONDUIT(S) IN FIRE RATED FLOORS, WALLS SYSYEMS. REFER TO DIVISION 7 SPECIFICATIONS.
- j. CONTRACTOR TO PATCH, PAINT AND RESTORE TO ORIGINAL CONDITIONS DISTURBED AREAS OF WORK. MATCH TO FINISH COLOR, COORDINATE WITH GENERAL CONSTRUCTION CONTRACT.


GENERAL NOTES:

- A. LUMINAIRE WITH LASTING "EM" DESIGNATION SHALL BE PROVIDED WITH EMERGENCY BATTERY PACK.
- B. NEW EXIT SIGNS TIE TO UN-SWITCHED LOCAL LIGHTING CIRCUIT.
- C. REFER TO LUMINAIRE SCHEDULE FOR SPECIFIED FIXTURES.
- D. ALL LUMINAIRES SHALL BE CONNECTED TO NEAREST LIGHTING CIRCUIT. RUN MIN. 2-#12 AWG, 1-#12 AWG IN 3/4"C UNLESS OTHERWISE NOTED. RE-USE AS MUCH AS POSSIBLE OF EXISTING CIRCUITS.
- E. CONTRACTOR TO COORDINATE WITH ARCHITECT CEILING HEIGHT(S) AND FINAL MOUNTING HEIGHT(S).
- F. PROVIDE NEW SUPPORTS AND CIRCUITRY EXTENSION FOR ANY RELOCATED FIXTURE(S). COORDINATE FINAL LOCATION IN CEILING PRIOR TO INSTALLATION.
- G. CONTRACTOR TO PROVIDE ALL PATHWAYS, JUNCTION BOXES, WIRING AND DEVICES FOR A FUTURE FIRE ALARM SYSTEM. FIRE ALARM WIRING SHALL BE IN RACEWAYS IN VERTICAL RUNS.
- H. POWER RECEPTACLES TO BE CONNECTED AT INDICATED PANELBOARD. RUN #12AWG MIN. IN 3/4" C, UNLESS OTHERWISE NOTED.
- CONTRACTOR TO REFER TO EQUIPMENT CONNECTION SCHEDULE FOR ALL REQUIRED POWER CONNECTIONS NOT SHOWN IN THIS SHEET.
- J. REMOVED UN-USED ELECTRICAL DEVICES IN SCOPE AND PROVIDE BLANK COVERS. SAME APPLIES FOR ABANDONED POWER CONNECTIONS. DISCONNECT AND REMOVE WIRING UP TO THE PANELBOARD SOURCE

KEY NOTES:

- 1. NOT USED.
- PROVIDE 1" CONDUIT WITH WIRING (MIN. 4-#16 AWG) TO ELEVATOR CONTROLLER FOR TWO (2)
 REQUIRED SIGNALS. ORIGINATE SIGNALS IN ATS UNIT. REPLACE ATS ELECTRONIC CONTROLLER TO
 ACCEPT SIGNALS (IF NEEDED). VERIFY ON FIELD ATS UNIT.
- 3. TAP POWER FROM PANELBOARD "B-1" FOR NEW ELEVATOR FEEDER. PROVIDE 3-#1 AWG, 1-#6 GND. IN 2" CONDUIT TO NEW 200AMP. DISCONNECT, 3P, FUSED AT 125AMP. MOUNT DISCONNECT NEXT TO PANELBOARD B-1. RECONFIGURE EXISTING CONDUITS, EQUIPMENT AS NEEDED.
- 4. NEW WALLPACK FIXTURE (TYP. OF 4), MOUNT FIXTURES AT DIFFERENT HEIGHTS IN THE NEW STAIRWELL. VERIFY ON FIELD AND CONNECT TO EXISTING LIGHTING CIRCUIT, EXTEND CONDUIT, WIRING AS REQUIRED. PAINT CONDUIT TO MATCH EXTERIOR FINISH COLORS.
- 5. NEW 200AMP. DISCONNECT, 3P, FUSED AT 125 AMP. MOUNT NEXT TO ELEVATOR POWER UNIT.
- 6. ELEVATOR MOTOR. CONFIRM FINAL MOTOR RATING PRIOR TO ELECTRICAL INSTALLATION.
- 7. PROVIDE 120V SERVICE RECEPTACLE (TYP. OF 2) MOUNTED ON THE PIT LEVEL. RUN 2-#12 AWG, 1-#12 AWG IN 3/4" C CIRCUIT ALONG WITH LIGHTING LOAD TO NEAREST POWER SOURCE, OTHERWISE CONNECT TO PANELBOARD B-1. ONE 120V RECEPTACLE DEVICE WILL SERVE NEW SUMP PUMP.
- 8. PROVIDE AND MOUNT LUMINAIRE IN THE PIT LEVEL. REFER TO LUMINAIRE SCHEDULE.
- 9. PROVIDE 15A, 120V LIGHT SWITCH. LOCATE SWITCH BY ACCESS LADDER AS REQUIRED.
- 10. PROVIDE LED WALL SCONCE. REFER TO LUMINAIRE SCHEDULE. CONNECT TO NEAREST AVAILABLE LIGHTING CIRCUIT OR PANELBOARD SOURCE. RUN CONDUIT, WIRING AS REQUIRED.
- 11. PROVIDE LUMINAIRE AND CIRCUITRY. MOUNT FIXTURE ON TOP BEAM OR TOP LEVEL OF ELEVATOR SHAFT. CONTROL LIGHT FROM PIT LEVEL SWITCH, UNLESS OTHERWISE NOTED.
- 12. PROVIDE POWER TO NEW EXHAUST FAN IN THE ATTIC SPACE. REFER TO EQUIPMENT CONNECTION SCHEDULE. COORDINATE FINAL LOCATION ON FIELD.
- 13. UNDER THIS PHASE PROVIDE COMBINATION SMOKE AND CARBON MONOXIDE DETECTOR, CEILING DEVICE, WITH INTEGRATED ALARM AND 10 YEAR SEALED LITHIUM BATTERY OR APPROVED EQUAL
- 14. RELOCATE AND REINSTALL PENDANT/SURFACE LUMINAIRE(S) AND CENTER WITHIN THE SPACE. CLEAN, RE-LAMP AND EXTEND CIRCUITRY, CONTROL WIRING AS NEEDED.

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FLYNN BATTAGLIA
617 Main Street, Suite 401

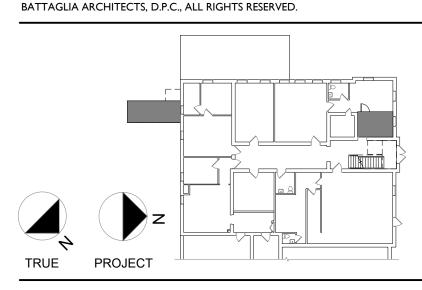Buffalo, New York 14203 Telephone (716) 854-2424



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NOTES & REVISIONS:

Revision Schedule

Revision Number Date Description

DRAWING ISSUED:

Project Number:

00370

Drawn By:

AD

APRIL 5, 2021

Scale:

1/4" = 1'-0"

Checked By:


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Drawing Title

ELECTRICAL FLOOR PLANS

Drawing Number

E-01

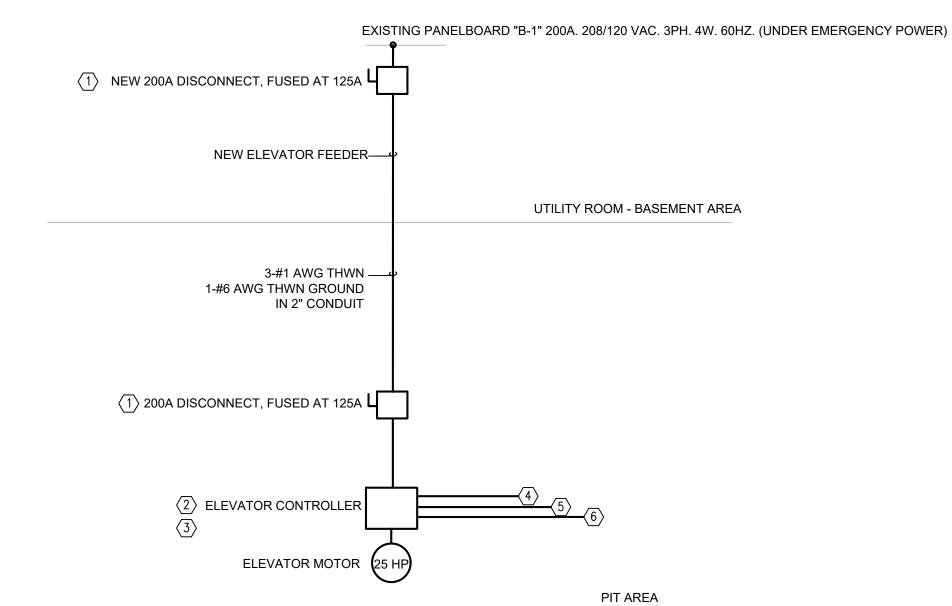


KEY NOTES


AS INDICATED BY: $\langle \# \rangle$

- 1. PROVIDE 200AMP. DISCONNECT, FUSED AT 125 AMP. "R" TYPE OR AS INDICATED OTHERWISE.
- 2. ELEVATOR CONTROLLER AND MOTOR BY ELEVATOR CONTRACTOR.
- 3. ALL SIGNAL AND LOW VOLTAGE CONTROL WIRING BY ELEVATOR CONTRACTOR.
- 4. PROVIDE NEW PHONE DIGITAL OR ANALOG LINE TO CONTROLLER. ORIGINATE AT POINT OF TELECOM. ENTRY.
- 5. PROVIDE EXTERNAL JUNCTION BOX TO RECEIVE AUTOMATIC TRANSFER SIGNALS, PRE-TRANSFER AND EMERGENCY POWER OPERATION. RUN SIGNALS FROM ATS UNIT, BASEMENT AREA.
- 6. PROVIDE EXTERNAL JUNCTION BOX TO RECEIVE FUTURE FIRE ALARM SIGNALS.

1 PARTIAL POWER RISER DIAGRAM FOR ELEVATOR SYSTEM SCALE: NONE

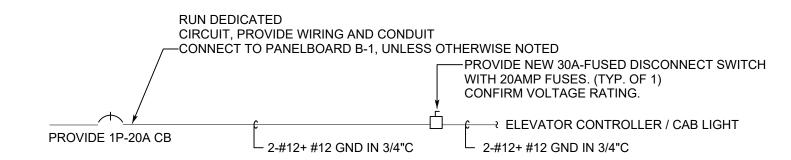

PARTIAL POWER RISER DIAGRAM FOR CAB LIGHTING SCALE: NONE

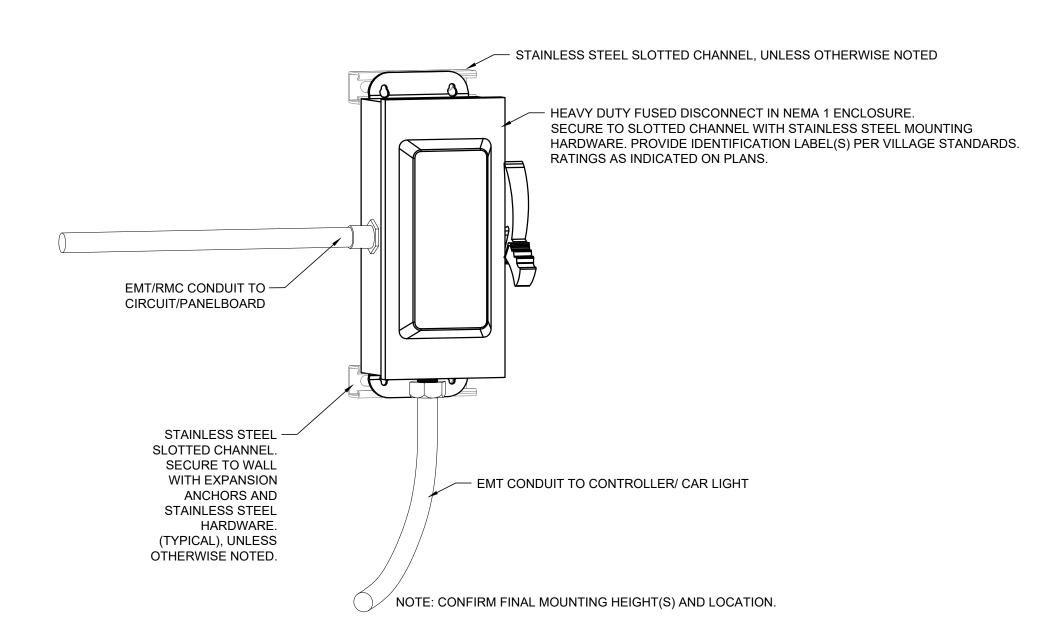

3 LOCKABLE FUSED DISCONNECT DETAIL (TYP.) SCALE: NONE

		EQUIF	PMEI	NT C	CONI	NEC	TION	SCHE	DUL	E			
0.	EQUIPMENT	NT LOCATION	LOAD DATA SUPPLY DA		Y DATA		CONTROLS		REMARKS				
ITEM NO.	O EQUIPIVIEIN I		KW HP AMPS	VOLTS	PHASE	PANEL.	CKT. BRK.	WIRE	CDT.	VARIABLE FREQUENCY DRIVE	DRIVE COMBINATION MAGNETIC MOTOR STARTER		
EF-1	EXHAUST FAN UNIT	ATTIC AREA	1/10HP	120	1	B-1	20A-1P	2#12+#12G	3/4"	DIV. 23	DIV. 23		


EQUIPMENT C & C SCHEDULE GENERAL NOTES:

- 1. ELECTRICAL CONTRACTOR SHALL ROUTE AND WIRE TO ALL EQUIPMENT AND SUPPLY 120V POWER FOR CONTROLS.
- 2. ELECTRICAL CONTRACTOR SHALL PROVIDE ALL WIRING, CONDUIT FOR FIRE ALARM INTERFACE (IF APPLICABLE). LEAVE FOR FUTURE PROVISIONS.
- 3. PROVIDE FIRE ALARM INTERFACE BETWEEN SMOKE DETECTOR, EXHAUST FAN AND MOTORIZED LOUVER. LEAVE FOR FUTURE PROVISIONS.

LUMINAIRE SCHEDULE								
FIXTURE TYPE	VOLTAGE	LAMPS						
B1	LED DOWNLIGHT. RECESSED TYPE. 1500-1700 LUMENS. LITHONIA LIGHTING, LRM4 SERIES OR APPROVED EQUAL. INCLUDE FLANGE KIT ADAPTORS.	120-208V	14W LED					
C1	WALL SCONCE LED. 1450 LUMENS. PROGRESS LIGHTING. MODEL P560001-129-30 OR APPROVED EQUAL. INCLUDE MOUNTING ACCESORIES.	120-208V	18W LED					
S1	LINEAR LED 4FT. LITHONIA FEM SERIES, 4000K. 3000LM. WHITE FINISH OR APPROVED EQUAL. PROVIDE ALL ACCESSORIES FOR MOUNTING.	120/208V	19W LED					
W1	WALLPACK, OUTDOOR TYPE. LITHONIA MODEL OLWX1 LED 40W 50K 5. DARK BRONZE FINISH OR APPROVED EQUAL. ADD INTEGRAL PHOTOCELL.	120-208V	37W LED					
х	EMERGENCY EXIT SIGN FIXTURE. LITHONIA, EDG SERIES. SURFACE MOUNT. BRUSH AL FINISH. AC OPTION OR APPROVED EQUAL.	120-208V	5W LED					

NOTE: COORDINATE FINAL FIXTURE MOUNTING LOCATION AND COLOR TEMPERATURE. PROVIDE ALL ACCESSORIES. COORDINATE WITH ARCHITECT COLOR FINISHES AND FINAL MOUNTING HEIGHTS. CONTRACTOR TO FIELD VERIFY EXISTING CIRCUIT VOLTAGE(S). PROVIDE ALL FIXTURES WITH DLC OR ENERGY STAR RATINGS AND WITH DIMMABLE CAPABILITIES.

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Checked By:
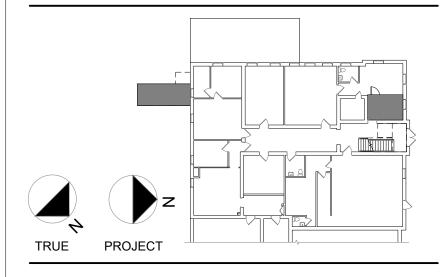
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ELECTRICAL DETAILS AND SCHEDULES

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E-02